

NORTH REGION STAGE 1 BID PACKAGE N1-3 PRIDCO-FEMA 4339 DR PROGRAM

REPAIR AND IMPROVEMENTS OF PUERTO RICO INDUSTRIAL BUILDINGS OF THE INDUSTRIAL DEVELOPMENT COMPANY FOR THE:

IND	EX OF	DRAW	INGS - PW 7801, DI 219340
	Sheet	Current	
Discipline	Number	Revision	Sheet Name
00-GENERAL	1GI001		COVER SHEET - DI 219340
00-GENERAL	1GI002		GENERAL NOTES, ABBREVIATIONS AND LEGEND
03-ARCHITECTURAL	1AE101		SITE PLAN BUILDING T085506700 DI 219340
05-DETAILS	1DT501		DETAILS AND SPECIFICATIONS
05-DETAILS	1DT502		DETAILS AND SPECIFICATIONS
05-DETAILS	1DT503		DETAILS AND SPECIFICATIONS

INDEX OF DRAWINGS - PW 7801, DI 219341				
	Sheet	Current		
Discipline	Number	Revision	Sheet Name	
00-GENERAL	2GI001		COVER SHEET - DI 219341	
00-GENERAL	2GI002		GENERAL NOTES, ABBREVIATIONS AND LEGEND	
03-ARCHITECTURAL	2AE101		SITE PLAN BUILDING T095407000 DI 219341	
05-DETAILS	2DT501		DETAILS AND SPECIFICATIONS	
05-DETAILS	2DT502		DETAILS AND SPECIFICATIONS	

INDEX OF DRAWINGS - PW 7801, DI 219342			
Discipline	Sheet Number	Current Revision	Sheet Name
Discipine	Number	Kevision	Silectivalile
00-GENERAL	3GI001		COVER SHEET - DI 219342
00-GENERAL	3GI002		GENERAL NOTES, ABBREVIATIONS AND LEGEND
03-ARCHITECTURAL	3AE101		SITE PLAN BUILDING T102907000 DI 219342
05-DETAILS	3DT501		DETAILS AND SPECIFICATIONS
05-DETAILS	3DT502		DETAILS AND SPECIFICATIONS

INDEX OF DRAWINGS - PW 8067, DI 219458			
	Sheet	Current	
Discipline	Number	Revision	Sheet Name
00-GENERAL	4GI001		COVER SHEET - DI 219458
00-GENERAL	4GI002		GENERAL NOTES, ABBREVIATIONS AND LEGEND
03-ARCHITECTURAL	4AE101		SITE PLAN BUILDING T089406700 DI 219458
05-DETAILS	4DT501		DETAILS AND SPECIFICATIONS
05-DETAILS	4DT502		DETAILS AND SPECIFICATIONS
05-DETAILS	4DT503		DETAILS AND SPECIFICATIONS

IND	EX OF	DRAW	INGS - PW 8144, DI 218811
Discipline	Sheet Number	Current Revision	Sheet Name
00-GENERAL	5GI001		COVER SHEET - DI 218811
00-GENERAL	5GI002		GENERAL NOTES, ABBREVIATIONS AND LEGEND
03-ARCHITECTURAL	5AE101		SITE PLAN BUILDING T082506700 DI 218811
05-DETAILS	5DT501		DETAILS AND SPECIFICATIONS
05-DETAILS	5DT502		DETAILS AND SPECIFICATIONS

IND	EX OF	DRAW	INGS - PW 8144, DI 218815
	Sheet	Current	
Discipline	Number	Revision	Sheet Name
00-GENERAL	6GI001		COVER SHEET - DI 218815
00-GENERAL	6GI002		GENERAL NOTES, ABBREVIATIONS AND LEGEND
03-ARCHITECTURAL	6AE101		SITE PLAN BUILDING T093606800 DI 218815
05-DETAILS	6DT501		DETAILS AND SPECIFICATIONS
05-DETAILS	6DT502		DETAILS AND SPECIFICATIONS

IND	EX OF	DRAW	INGS - PW 8144, DI 218823
	Sheet	Current	,
Discipline	Number	Revision	Sheet Name
00-GENERAL	7GI001		COVER SHEET - DI 218823
00-GENERAL	7GI002		GENERAL NOTES, ABBREVIATIONS AND LEGEND
03-ARCHITECTURAL	7AE101		SITE PLAN BUILDING T125507900 DI 218823
05-DETAILS	7DT501		DETAILS AND SPECIFICATIONS
05-DETAILS	7DT502		DETAILS AND SPECIFICATIONS
05-DETAILS	7DT503		DETAILS AND SPECIFICATIONS

1. PW: 7801 / DI: 219340 / Bldg: T085506700 / Mun: Quebradillas

2. PW: 7801 / DI: 219341 / Bldg: T095407000 / Mun: Quebradillas


3. PW: 7801 / DI: 219342 / Bldg: T102907000 / Mun: Quebradillas

4. PW: 8067 / DI: 219458 / Bldg: T089406700 / Mun: Utuado

5. PW: 8144 / DI: 218811 / Bldg: T082506700 / Mun: Arecibo

6. PW: 8144 / DI: 218815 / Bldg: T093606800 / Mun: Arecibo


7. PW: 8144 / DI: 218823 / Bldg: T125507900 / Mun: Arecibo

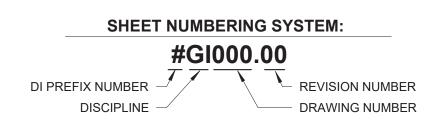







COVER SHE	ET - N1-3
SCALE:	
A.C. C.I.I	OWN
AS SH	OWN
DELIVERY DATE:	PROJECT NUMBER 21-0258-02
PRINT DATE & TIME:	
	21-0258-02

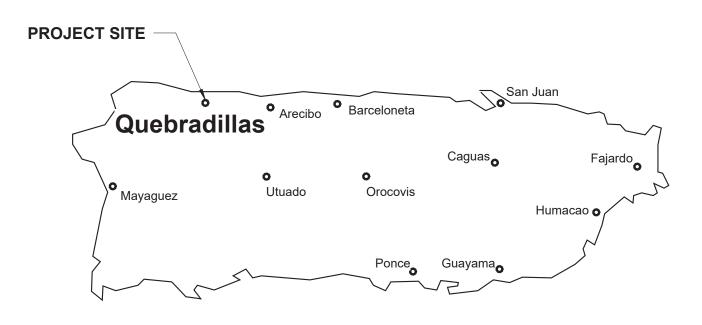

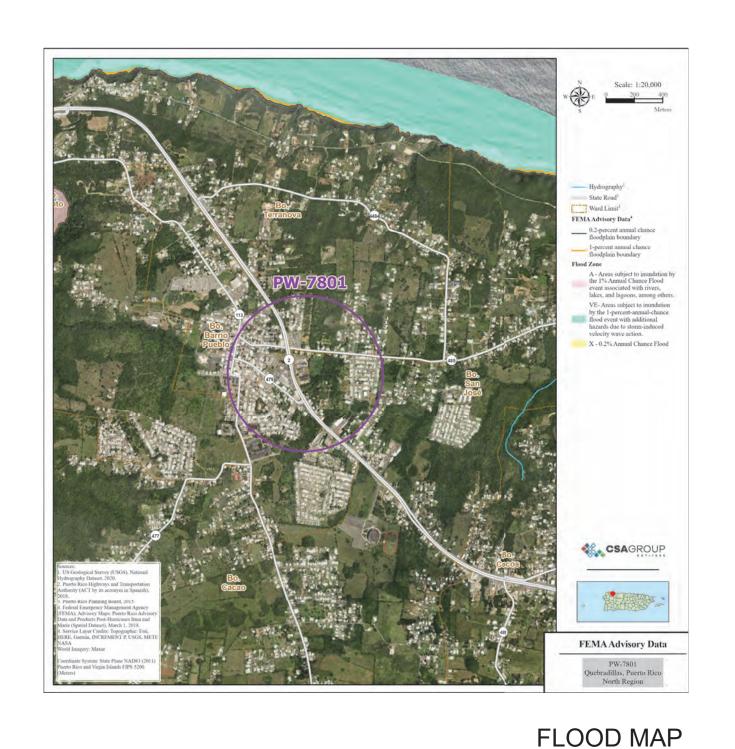



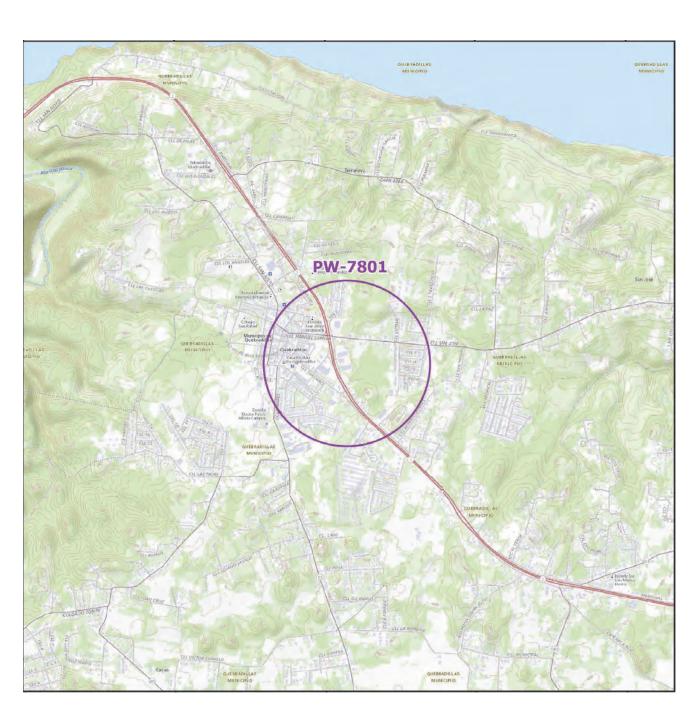

LOCATION MAP SCALE 1:20,000

. 2005 14,7 (1

AERIAL PHOTO

INDEX OF DRAWINGS - PW 7801, DI 219340 Discipline Sheet Number Current Revision Sheet Name 00-GENERAL 1GI001 COVER SHEET - DI 219340 00-GENERAL 1GI002 GENERAL NOTES, ABBREVIATIONS AND LEGEND 03-ARCHITECTURAL 1AE101 SITE PLAN BUILDING T085506700 DI 219340 05-DETAILS 1DT501 DETAILS AND SPECIFICATIONS 05-DETAILS 1DT502 DETAILS AND SPECIFICATIONS 05-DETAILS 1DT503 DETAILS AND SPECIFICATIONS

IND	EX OF	DRAW	INGS - PW 7801, DI 219341
	Sheet	Current	
Discipline	Number	Revision	Sheet Name
00-GENERAL	2GI001		COVER SHEET - DI 219341
00-GENERAL	2GI002		GENERAL NOTES, ABBREVIATIONS AND LEGEND
03-ARCHITECTURAL	2AE101		SITE PLAN BUILDING T095407000 DI 219341
05-DETAILS	2DT501		DETAILS AND SPECIFICATIONS
05-DETAILS	2DT502		DETAILS AND SPECIFICATIONS

INDEX OF DRAWINGS - PW 7801, DI 219342			
	Sheet	Current	
Discipline	Number	Revision	Sheet Name
00-GENERAL	3GI001		COVER SHEET - DI 219342
00-GENERAL	3GI002		GENERAL NOTES, ABBREVIATIONS AND LEGEND
03-ARCHITECTURAL	3AE101		SITE PLAN BUILDING T102907000 DI 219342
05-DETAILS	3DT501		DETAILS AND SPECIFICATIONS
05 DETAILS	3DT502		DETAILS AND SPECIFICATIONS


NORTH REGION STAGE 1 BID PACKAGE N1-3 PRIDCO-FEMA 4339 DR PROGRAM

REPAIR AND IMPROVEMENTS OF INDUSTRIAL BUILDINGS OF THE PUERTO RICO INDUSTRIAL DEVELOPMENT COMPANY FOR THE:

1. PW: 7801 / DI: 219340 / Bldg: T085506700 / Mun: Quebradillas

2. PW: 7801 / DI: 219341 / Bldg: T095407000 / Mun: Quebradillas


3. PW: 7801 / DI: 219342 / Bldg: T102907000 / Mun: Quebradillas

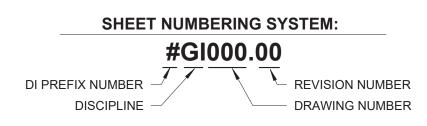










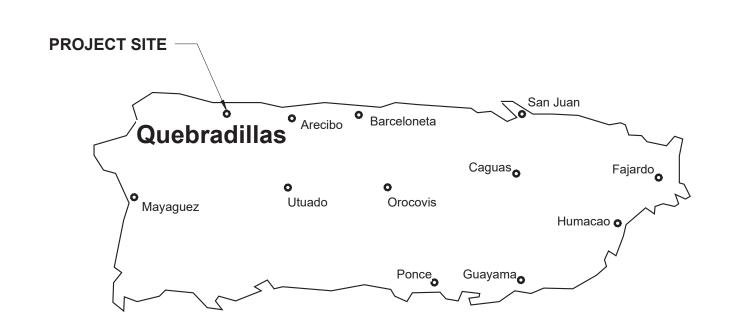

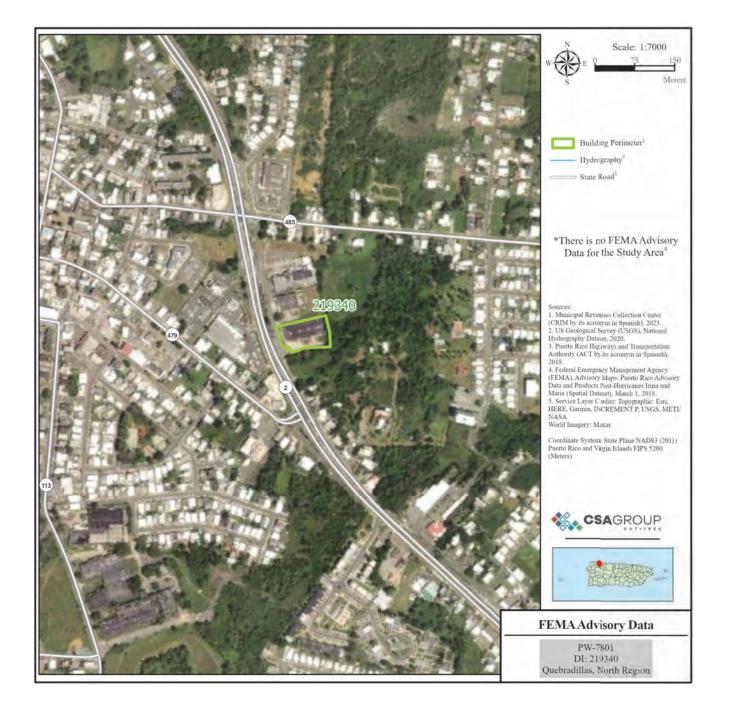

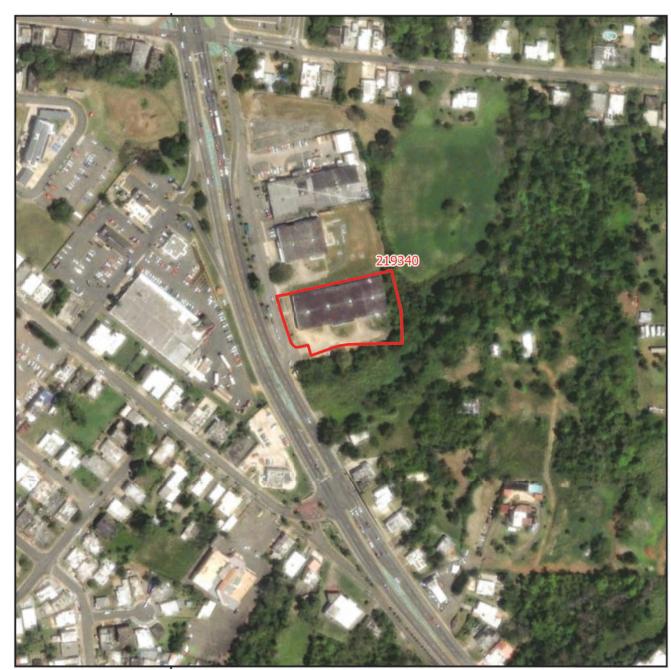

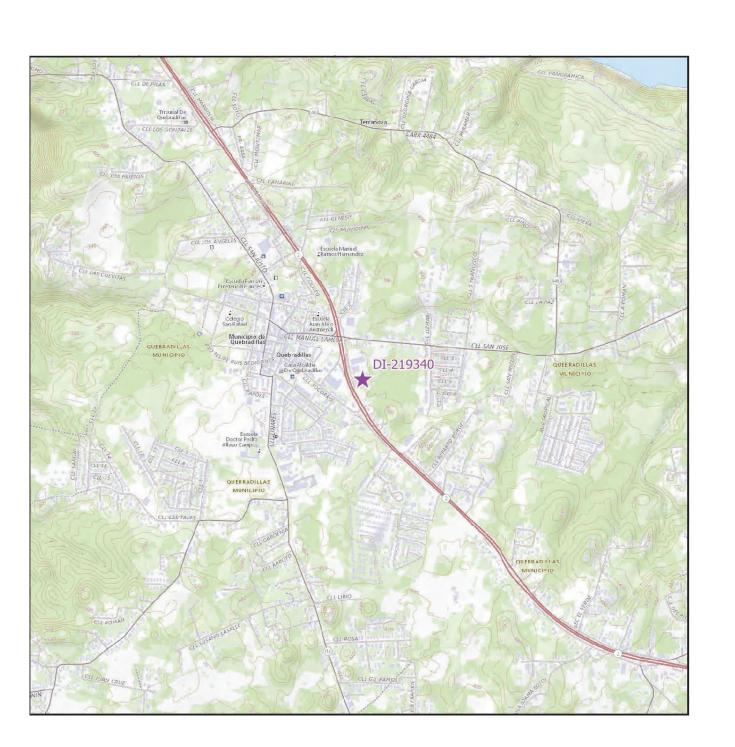

FLOOD MAP

LOCATION MAP SCALE 1:20,000


IND	INDEX OF DRAWINGS - PW 7801, DI 219340				
	Sheet	Current			
Discipline	Number	Revision	Sheet Name		
00-GENERAL	1GI001		COVER SHEET - DI 219340		
00-GENERAL	1GI002		GENERAL NOTES, ABBREVIATIONS AND LEGEND		
03-ARCHITECTURAL	1AE101		SITE PLAN BUILDING T085506700 DI 219340		
05-DETAILS	1DT501		DETAILS AND SPECIFICATIONS		
05-DETAILS	1DT502		DETAILS AND SPECIFICATIONS		
OF DETAIL O	4DTC00		DETAIL CLAND ODECIFICATIONS		

PRIDCO-FEMA 4339 DR PROGRAM NORTH REGION STAGE 1 BID PACKAGE N1-3

AERIAL PHOTO 18.47179, -66.93382

1. PW:7801 | DI:219340 | Bldg:T085506700

Road PR-2, Km. 100.8, San Jose Ward Quebradillas, Puerto Rico

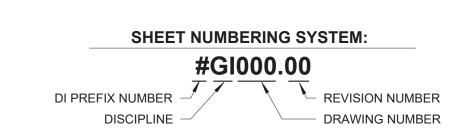





COVER SHEET - DI 219340			
SCALE:			
AS SH	OWN		
DELIVERY DATE:	PROJECT NUMBER		
PRINT DATE & TIME: 4/22/2024 3:28:19 PM	BIM FILE NAME:		

CODES 2018, AND WITH OTHER CODES, STANDARDS, AND REGULATIONS CALLED FOR IN SAID CODES COMPLY WITH APPLICABLE RULES AND REGULATIONS FOR OBTAINING NECESSARY AND REQUIRED INSPECTIONS, APPROVALS AND PERMITS

NECESSARY TO PERFORM WORK AND SERVICES FOR THE PROJECT. EXECUTE WORK IN ACCORDANCE WITH THE BEST ACCEPTED TRADE PRACTICES, AS PER MANUFACTURER'S WRITTEN RECOMMENDATIONS, AND IN A CAREFUL AND ORDERLY MANNER WITH THE LEAST POSSIBLE

NOISE, DUST, OR DISTURBANCE TO OCCUPANTS. IMPLEMENT SAFETY CONTROLS DURING DEMOLITION/CONSTRUCTION

DAILY REMOVE DEBRIS RESULTING FROM DEMOLITION/CONSTRUCTION AND TRANSPORT IT OUT OF PROJECT LIMITS. PERFORM DISPOSAL OPERATION IN ACCORDANCE WITH GOVERNMENT APPROVALS AND REGULATIONS. SITE AND STRUCTURE SHALL BE LEFT BROOM CLEAN FOR SUBSTANTIAL COMPLETION.

DO NOT SCALE DRAWINGS. VERIFY DIMENSIONS IN THE FIELD BEFORE PROCEDING WITH ANY PORTION OF THE WORK. ADVISE IN WRITING TO CONSTRUCTION MANAGER AND ARCHITECT OF DISCREPANCY BETWEEN EXISTING CONDITIONS AND DRAWINGS.

REPORT TO CONSTRUCTION MANAGER AND ARCHITECT DISCREPANCIES IN THE CONTRACT DRAWINGS, SPECIFICATIONS OR DETAILS PRIOR TO COMMENCING THE WORK. COORDINATE CIVIL, MECHANICAL, ELECTRICAL, ARCHITECTURAL AND

STRUCTURAL REQUIREMENTS FOR PROPER LOCATION AND PROVISIONS OF SLEEVES, INSERTS, OPENINGS AND ROUGH-IN REQUIRED CONDUCT DEMOLITION/CONSTRUCTION OPERATION TO INSURE MINIMUM INTERFERENCE WITH ROADS, STREETS, SIDEWALKS AND OTHER

ADJACENT FACILITIES. THE USE OF A BRAND NAME AND/OR MODEL NUMBER TO DENOTE PRODUCTS, EQUIPMENTS, MATERIALS, OR PROCESS, IS INTENDED TO ESTABLISH A STANDARD OF QUALITY AND SHALL NOT BE CONSTRUED AS

LIMITING COMPETITION. DO NOT COMMENCE ANY DEMOLITION OF SITE ELEMENTS OR STRUCTURE UNTIL THE HAZARDOUS MATERIAL ABATEMENT IS DONE AND EPA CERTIFICATION IS OBTAINED, STATING THAT THE SITE ELEMENTS AND STRUCTURES ARE FREE OF HAZARDOUS MATERIALS. PRIOR TO COMMENCEMENT OF THE HAZARDOUS MATERIAL ABATEMENT THE

BUILDING AND SITE SHALL BE VACANT. SPECIFIED TREE PRUNING OR CUTTING OR INCIDENTAL TO OTHER REPAIR WORK MAY REQUIRE A DRNA PERMIT. THE CONTRACTOR IS RESPONSIBLE FOR OBTAINING PERMIT BEFORE PERFORMING THE WORK.

GENERAL NOTES

PRESSURE WASH, MINIMUM 3,000 PSI, EXISTING BUILDING EXTERIOR WALLS, WINDOWS, AND DOORS BEFORE BEGINNING SPECIFIED WORK. REPAIR INTERIOR AND EXTERIOR WALL SURFACES WITH CEMENT PLASTER PRIOR TO APPLYING PAINT FINISH. REPAIR WORK INCLUDES, BUT IS NOT LIMITED TO CUT AND PATCHING, REMOVAL OF NAILS AND SCREWS FROM WALLS, REPAIR OF MAJOR IMPERFECTIONS ON

WALLS AND FINISHES IN GENERAL FULL TEAR-OFF OF ROOF WATERPROOFING SYSTEM INCLUDING MEMBRANE, INSULATION AND FLASHINGS WHERE SYSTEM REPLACEMENT IS SPECIFIED. A ROOF MOISTURE SURVEY MAY BE REQUIRED PRIOR TO

INSTALLATION OF NEW MEMBRANE CLEAN, REPAIR AND VERIFY STRUCTURAL INTEGRITY OF ROOF DECK PRIOR THE INSTALLATION OF THE WATERPROOFING SYSTEM. COMPLY WITH THE MANUFACTURER RECOMMENDATIONS FOR THE INSTALLATION OF ROOF MEMBRANE TO VALIDATE THE WARRANTY.

ELECTRICAL GENERAL NOTES

NO WIRE SHALL BE SMALLER THAN # 12 AWG THHN, 600 VOLTS NO CONDUIT SHALL BE SMALLER THAN 3/4".

ALL CONDUIT SHALL BE RIGID GALVANIZED EXCEPT OTHERWISE ALL WIRE SHALL BE COPPER, INSULATED AS NOTED.

LEAVE A #12 AWG GALVANIZED FISH WIRE IN ALL EMPTY CONDUITS.

ALL UNDERGROUND CONDUITS SHALL BE PROTECTED WITH 4" CONCRETE ENVELOPE. EXPANSION FITTINGS SHALL BE USED FOR EVERY CONDUIT CROSSING

BUILDING EXPANSION JOINTS.

CONTRACTOR SHALL BALANCE ALL LOADS PROVIDE A #12 GREEN THW BONDING JUMPER BETWEEN EACH OUTLET BOX AND RECEPTACLE GROUNDING TERMINAL, USE 3/8" LONG 10-32

GROUNDING SCREW. ALL INSTALLATIONS SHALL BE EXPOSED UNLESS OTHERWISE INDICATED.

EXPOSED CONDUITS SHALL BE SUPPORTED BY MEANS OF ONE BOLT CLAMP SPACED NOT FURTHER THAN 7'-6" APART.

AN EXPOSED WORK CONDULET SHALL BE USED FOR ALL 90 BENDS. ALL NON-GALVANIZED METAL PARTS SHALL BE GIVEN ONE COAT OF RED OXIDE AND TWO COATS OF METALLIC GRAY PRIOR TO INSTALLATION.

ALL GALVANIZED RIGID CONDUITS FOR TOGGLE SWITCHES AND RECEPTACLES LOCATED AT DOORWAYS AND LEAN - TO SHALL BE CONCEALED WITHIN ROOF SLAB, WALLS AND OVERHANGS.

CONTRACTOR SHALL PROVIDE ELECTRICAL SERVICE TO TEST ALL ELECTRICAL SYSTEM IN PRESENCE OF THE REPRESENTATIVE FROM THE MECHANICAL AND ELECTRICAL DEPARTMENT. ALL LIGHTING CIRCUITS SHALL HAVE ONE (1) PORCELAIN LIGHT SOCKET

WITH A LED TYPE BULB, EQUIVALENT TO 100W INCANDESCENT LUMENS. SWITCHES AND RECEPTACLES SHALL BE INSTALLED 4'-0" A.F.F. THE NEUTRAL WIRES SHALL BE IDENTIFIED THROUGHT THE INSTALLATION

BY THE USE OF WHITE COLOR COVERED LIVE WIRES WITHIN THE SAME CONDUIT SHALL BE COLOR CODED AS PER N.E.C. RECEPTACLES AND LIGHTING CIRCUITS SHALL BE #12 THHN WIRE AND

SHALL BE CONNECTED TO 20 AMP BREAKERS AT THE PANELBOARD. ALL OVERHANGS AND LEAN - TO'S SHALL BE PROVIDED WITH LIGHT SOCKETS.

CONTRACTOR SHALL VERIFY LENGTH OF FEEDERS IN THE FIELD BEFORE SUBMITTING BIDS ALL SWITCHES AND RECEPTACLES THAT ARE CONCEALED IN WALLS AND

OVERHANGS SHALL BE PROVIDED WITH STAINLESS STEEL COVERS. CONTRACTOR SHALL CONTACT THE DISTRICT ENGINEER OF LUMA PRIOR | 12. TO THE BEGINNING OF THE WORK AND COORDINATE WITH THEM FOR THE EXECUTION OF THE WORK CONCERNING THE SERVICE ENTRANCE AND SUBSTATION IF REQUIRED. IN ADDITION, THE CONTRACTOR SHALL OBTAIN 13. A CERTIFICATE OF INSPECTION AT THE COMPLETION OF THE WORK AND SHALL FORWARD IT TO THE PUERTO RICO INDUSTRIAL DEVELOPMENT

COMPANY ALL INSTALLATIONS SHALL BE IN ACCORDANCE WITH THE LATEST RULES AND REGULATIONS OF THE N.E.C. AND LUMA.

ALL BOXES FOR RECEPTACLES & LIGHTING SWITCHES FOR EXPOSED

INSTALLATION SHALL BE "FS" TYPE.

CONTRACTOR SHALL SUBMIT A LIST OF MATERIALS AND EQUIPMENT GIVING MANUFACTURER CATALOG NUMBERS AND COMPLETE SPECIFICATIONS AND DRAWINGS FOR APPROVAL OF P.R.I.D.C.O. PRIOR TO THE PURCHASING OF SAID MATERIALS AND/OR EQUIPMENT.

PLUMBING GENERAL NOTES:

PLUMBING SHALL BE IN STRICT ACCORDANCE WITH THE 2018 PUERTO RICO BUILDING CODE.

FURNISH AND SET IN PLACE BEFORE CONCRETE POURING ALL NECESSARY SLEEVES FOR WASTE OR SOIL, VENT, HOT, AND COLD WATER LINES, THESE SLEEVES SHALL BE AS SPECIFIED OR REQUIRED BY THE

THE PLUMBING DRAWING IS GENERALLY DIAGRAMATTIC AND INDICATIVE OF THE WORK TO BE INSTALLED. RUN ALL PIPING CONCEALED WHEREVER POSSIBLE UNLESS OTHERWISE NOTED.

SIZES SHOWN IN FIXTURE SCHEDULE ARE MINIMUM AND SHALL BE INCREASED AS NECESSARY TO COMPLY WITH CODE REQUIREMENTS OR AS SHOWN ON DRAWINGS.

BEFORE CONSTRUCTION VERIFY EXISTING ELEVATIONS AGAINST PROPOSED SLOPES. ANY DISCREPANCIES SHALL BE BROUGHT TO THE ATTENTION OF THE ARCHITECT.

CLEANOUT SHALL BE OF SAME SIZE AS THE PIPES TO WHICH THEY ARE CONNECTED UP TO 4", FOR LARGE

UNLESS OTHERWISE INDICATED, ALL DRAINAGE PIPING 3" AND SMALLER SHALL BE SLOPED 1/4" PER FT., LARGER

CLEANOUT SHALL BE NOT MORE THAN 50 FEET AP-ART IN HORIZONTAL DRAINAGE LINES OF 4" NOMINAL DIAMETER OR LESS AND NOT MORE THAN 100 FEET APART FOR LARGER PIPES.

FOR FIXTURES AND EQUIPMENT NOT LISTED IN SCHEDULE, SEE CONTRACT SPECIFICATIONS.

10. DETERMINE EXACT LOCATION OF THE PIPING TO AVOID ANY INTERFERENCE WITH PIPING AND/OR EQUIPMENT BEING INSTALLED BY ANOTHER SUB-CONTRACTOR.

SANITARY TEES (SINGLE AND DOUBLE) AND QUARTER BENDS SHALL BE ACCEPTABLE ONLY FOR CHANGES OF DIRECTION FROM HORIZONTAL TO VERTICAL

USE LONG SWEEPING FITTINGS AND/OR LONG SWEEP BENDS AT BASE OF ALL STACKS.

PROVIDE ROUGHING-IN AND INSTALL ALL PLUMBING FIXTURES AND/OR EQUIPMENT WHICH ARE SUPPLIED BY

FOR ALL UNDERGROUND SANITARY AND STORM DRAINAGE USE: PVC POLYVINYL CHLORIDE) SEWER PIPE AND FITTING: ASTM D 3034, SDR-35, FOR SOLVENT CEMENT OR ELASTOMERIC GASKET JOINTS. A. SOLVENT CEMENT: ASTM D 2564 B. GASKETS: ASTM F 477, ELASTOMERIC SEAL.

PROVIDE ALL PIPE OPENINGS THROUGH SLABS WITH SLEEVES HAVING AN INTERNAL DIAMETER AT LEAST 1" LARGER THAN THE OUTSIDE DIAMETER OF UN-INSULATED PIPES OR OF THE INSULATION FOR INSULATION SERVICES. FLOOR SLEEVES ARE TO PROJECT 2" ABOVE FINISHED FLOORS.

SLEEVES SHALL BE SCHEDULES 40 GALVANIZED STEEL PIPE.

BOTTOM OF THE WATER SERVICES LINE SHALL BE 12 INCHES ABOVE THE HIGHEST POINT OF THE SEWER LINE WHENEVER THE HORIZONTAL DISTANCE BETWEEN THEM IS LESS THAN 5 FT.

PROVIDE DOWNSPOUT NOZZLES (SIMILAR TO JAY R. SMITH FIG 1770) AT THE OVERFLOW RAIN WATER OUTLETS,

CONTRACTOR SHALL SUPPLY AND INSTALL 1/4 TURN SHUT OFF VALVES AT EVERY PLUMBING FIXTURE.

ALL PLUMBING FIXTURES, COLORS AND FINISHES, SELECTION BY ARCHITECT

HVAC GENERAL NOTES:

SUPPLY AND INSTALL ALL ELECTRICAL CONTROLS, SAFETY SWITCHES AND ACCESSORIES NOT INDICATED IN THE ELECTRICAL DRAWING AND NECESSARY FOR THE PROPER OPERATION OF THE EQUIPMENT IN ACCORDANCE WITH THE MECHANICAL EQUIPMENT RECOMMENDATIONS AND THE NATIONAL ELECTRIC CODE.

PERFORM ALL WIRING AND CONNECTION (POWER AND CONTROL) NOT INDICATED IN THE ELECTRICAL DRAWINGS AND NECESSARY FOR THE PROPER OPERATION OF THE MECHANICAL EQUIPMENT IN STRICT ACCORDANCE WITH THE NATIONAL ELECTRIC CODE

TAKE EVERY PRECAUTION IN ORDER TO MINIMIZE OR ELIMINATE THE TRANSMISSION OF NOISE OR VIBRATION FROM THE EQUIPMENT, PIPING SYSTEM OR DUCT SYSTEM TO THE CONDITIONING SPACE.

EQUIPMENT, MATERIALS AND ACCESSORIES SHALL BE SIMILAR TO THE INDICATED SPECIFICATION AND/OR MANUFACTURER MODEL OR CATALOG NUMBER.

UNLESS OTHERWISE NOTED IN DRAWINGS AND/OR SPECIFICATIONS ALL EQUIPMENT AND ACCESSORIES SHALL BE FURNISHED AND INSTALLED BY THE CONTRACTOR.

CIVIL SITE GENERAL NOTES

ALL DISTANCES AND ELEVATIONS ARE EXPRESSED IN METERS UNLESS OTHERWISE SPECIFIED. ELEVATIONS ARE REFERRED TO MEAN SEA LEVEL.

COORDINATES ARE BASED ON THE LAMBERT PROJECTION FOR PUERTO RICO AND THE US VIRGIN ISLAND AND REFERENCED TO THE NORTH AMERICAN DATUM OF 1983 (NAD83 NA2011) EPOCH 2010.00 ADJUSTED IN **METERS**

THE CONTRACTOR SHALL COORDINATE WITH THE CONSTRUCTION MANAGER BEFORE CUTTING OR TRIMMING EXISTING TREES AFFECTED BY THE CONSTRUCTION.

THE CONTRACTOR SHALL PREPARE AND SUBMIT FOR EACH PROJECT AREA, THE CONTROL OF EROSION AND SEDIMENTATION (CES) PLAN FOR APPROVAL BY THE PERTINENT AGENCY AND THE CONSTRUCTION MANAGER. THE CONTRACTOR SHALL PROVIDE AND MAINTAIN A DEWATERING SYSTEM TO KEEP SUBGRADES DRY AND CONVEY GROUND WATER AWAY FROM EXCAVATIONS. THE DEWATERING PLAN SHALL BE SUBMITTED TO THE

CONSTRUCTION MANAGER FOR APPROVAL AND COORDINATION. DEWATERING PLANS SHALL INCLUDE CONTROL OF EROSION AND SEDIMENTATION FOR EACH PROJECT PHASE AND/OR WORK AREA. THE WATER FROM THE DEWATERING SYSTEM SHALL BE FREE OF SEDIMENT AND/OR DEBRIS BEFORE ANY DISPOSAL.

THE CONTRACTOR SHALL MAINTAIN THE DEWATERING SYSTEM UNTIL DEWATERING IS NO LONGER

ELECTRICAL, COMMUNICATION, SANITARY AND POTABLE WATER SERVICE SHALL NOT BE INTERRUPTED DURING CONSTRUCTION. IF NECESSARY, A PROVISIONAL TEMPORARY SERVICE AND/OR BY-PASS SHALL BE INSTALLED TO MAINTAIN SERVICE. PROVISIONAL TEMPORARY SERVICE AND/OR BY-PASS SHALL BE SUBMITTED TO THE CONSTRUCTION MANAGER FOR APPROVAL AND COORDINATION PRIOR TO CONSTRUCTION. THE CONTRACTOR SHALL PREPARE AND SUBMIT THE MAINTENANCE OF SERVICE PLAN FOR ELECTRICAL,

SANITARY AND POTABLE WATER FOR APPROVAL OF THE CONSTRUCTION MANAGER. THE CONTRACTOR SHALL NOTIFY THE CONSTRUCTION MANAGER IF ANY ELEMENT SUSPECTED OF CONTAINING HAZARDOUS MATERIAL IS ENCOUNTERED, PRIOR TO ANY RELATED WORK ACTIVITY. THE CONTRACTOR SHALL VISIT THE PROJECT AREA TO VERIFY THE SPACE LIMITATIONS FOR CONSTRUCTION

PROCESS AND EQUIPMENT. THE CONTRACT PRICE SHALL CONSIDER THE REQUIRED CONSTRUCTION PROCESS AND/OR EQUIPMENTS. PRIOR TO COMMENCEMENT OF THE WORK, CONTRACTOR SHALL VERIFY ALL DIMENSIONS AND EXISTING CONDITIONS AT PROJECT SITE AND SHALL NOTIFY THE CONSTRUCTION MANAGER OF ANY DISCREPANCIES

BETWEEN EXISTING CONDITIONS AND CONTRACT DOCUMENTS THAT COULD AFFECT CONSTRUCTION WORK SCHEDULE AND /OR PERFORMANCE. ALL DETAILS, SECTIONS AND NOTES SHOWN ON DRAWINGS ARE INTENDED TO BE TYPICAL AND SHALL APPLY TO

SIMILAR SITUATIONS ELSEWHERE UNLESS OTHERWISE NOTED. THE CONTRACTOR SHALL REPAIR OR REPLACE EXISTING FACILITIES DAMAGED DURING CONSTRUCTION PRIOR TO SUBSTANTIAL COMPLETION

THE CONTRACTOR SHALL MAINTAIN IN OPERATION EXISTING FACILITIES UNTIL NEW FACILITIES ARE IN OPERATION.

GENERAL STRUCTURAL NOTES

STRUCTURAL BUILDING AND DESIGN CODES:

PUERTO RICO BUILDING CODE 2018 AND ITS BINDING REFERENCED STANDARDS, INCLUDING BUT NOT LIMITED TO: THE INTERNATIONAL BUILDING CODE 2018

AMERICAN INSTITUTE FOR STEEL CONSTRUCTION (AISC), STEEL CONSTRUCTION MANUAL, 15 TH EDITION AMERICAN CONCRETE INSTITUTE (ACI), BUILDING CODE REQUIREMENTS FOR STRUCTURAL CONCRETE, ACI 318-14.

AMERICAN SOCIETY OF CIVIL ENGINEERS, MINIMUM DESIGN LOADS AND ASSOCIATED CRITERIA FOR BUILDINGS AND OTHER STRUCTURES, ASCE/SEI 7-16

STRUCTURAL NOTES ON CONCRETE REPAIR:

ALL CONCRETE REPAIR WORKS SHALL BE PERFORMED FOLLOWING THE GUIDELINES OF THE INTERNATIONAL CONCRETE REPAIR INSTITUTE (ICRI). HIRING A PROFESSIONAL EXPERIENCED IN THIS TYPE OF REPAIR IS RECOMMENDED TO ENSURE A PROPER

FOR THE REPAIR OF AREAS AFFECTED BY CORROSION, ICRI NO. 03730 GUIDELINE FOR SURFACE PREPARATION FOR THE REPAIR OF DETERIORATED CONCRETE RESULTING FROM REINFORCING STEEL CORROSION SHOULD BE FOLLOWED. BEFORE COMMENCING ANY CONCRETE REPAIR WORK, THE CONTRACTOR SHALL REVIEW THE REPAIR DETAILS PRESENTED IN

ARCHITECT OR ENGINEER OF RECORD TO CLARIFY THEM. IT IS IMPORTANT TO FOLLOW THE MANUFACTURER'S RECOMMENDATIONS FOR EACH PRODUCT UTILIZED FOR THIS JOB, IN ORDER TO GUARANTEE THAT THE REPAIR WORKS ARE CARRIED OUT ADEQUATELY.

THE DRAWINGS. IN CASE OF DOUBT WITH THE REPAIR DETAILS PRESENTED, THE CONTRACTOR SHOULD CONTACT THE

<u>STRUCTURAL NOTES ON CAST-IN-PLACE CONCRETE:</u>

PORTLAND CEMENT SHALL BE TYPE II.

ALL CONCRETE SHALL BE OF REGULAR WEIGHT (145 POUNDS PER CUBIC FOOT). THE FOLLOWING CONCRETE MIX PARAMETERS SHALL BE USED UNLESS OTHERWISE NOTED:

CONCRETE STRENGTH AT 28 DAYS – 3,000 PSI MAX. WATER/CEMENT RATIO - 0.65 RECOMMENDED SLUMP – 3 INCHES MAX. AGGREGATE SIZE (ASTM C33) – 1 INCH

PROVIDE CONCRETE MIXES DESIGNED BY A QUALIFIED TESTING LABORATORY FOR REVIEW AND APPROVAL BY THE STRUCTURAL ENGINEER. CONCRETE MIX DESING SHALL BE SIGNED AND SEALED BY A PROFESSIONAL ENGINEER AUTHORIZED TO EXERCISE THE PROFESSION IN THE COMMOM WEALTH OF PUERTO RICO.

NOTE ON REINFORCING STEEL BARS:

ALL REINFORCING STEEL SHALL BE NEW STOCK DEFORMED BARS CONFORMING TO ASTM A615, GRADE 60 (FY = 60 KSI). MAINTAIN THE FOLLOWING CONCRETE COVERAGE FOR REINFORCING STEEL UNLESS NOTED OTHERWISE:

CONCRETE CAST AGAINST EARTH: 3 INCHES

CONCRETE IN CONTACT WITH THE GROUND: 2 INCHES

CONCRETE SLAB AND WALLS WITHOUT CONTACT WITH GROUND: 1 INCHES

CONCRETE BEAMS AND COLUMNS: 1 1/2 INCHES

STRUCTURAL STEEL

DESIGN, DETAIL AND ERECT STRUCTURAL STEEL ELEMENTS IN ACCORDANCE WITH THE FOLLOWING:

AISC SPECIFICATION FOR THE DESIGN, FABRICATION, AND ERECTION OF STRUCTURAL STEEL FOR BUILDINGS

AISC MANUAL OF STEEL CONSTRUCTION, ALLOWABLE STRESS DESIGN. AISC CODE OF STANDARD PRACTICE FOR STEEL BUILDINGS AND BRIDGES.

AWS STRUCTURAL WELDING CODE, D1.1.

STRUCTURAL STEEL SHALL CONFORM TO THE FOLLOWING GRADES: W SHAPES: ASTM A992 (FY = 50 KSI, FU = 65 KSI)

STEEL ANGLE, CHANNELS, PLATES: ASTM A36 BOLTS, NUTS AND WASHERS: HIGH-STRENGTH BOLTS, INCLUDING NUTS AND WASHERS: ASTM A325

STEEL PLATES FOR LANDINGS AND THREADS: 1/4" ANTI-SLIP DIAMOND TYPE STEEL PLATE A36

WELDING ELECTRODE FOR STEEL SHALL BE E70XX.

PROVIDE DESIGN, FABRICATION, AND ERECTION OF METAL DECK CONFORMING TO THE STEEL DECK INSTITUTE'S "CODE OF RECOMMENDED STANDARD PRACTICE AND BASIC DESIGN SPECIFICATIONS" FORM ROOF DECK FROM STEEL SHEETS CONFORMING TO ASTM A 611 GRADE C AND D OR A 653 OR HIGHER SPECIFICATIONS

WITH A MINIMUM YIELD STRENGTH OF 33 KSI. ATTACH SHEETS TO STEEL SUPPORT MEMBERS AS INDICATED AND IN ACCORDANCE WITH THE MANUFACTURER'S INSTRUCTIONS FOR INSTALLATION. WHEN DECK IS SCHEDULED TO BEEXPOSED, DE-SLAG, CLEAN AND TOUCH UP WELDS WITH A ZINC-RICH

LAP ROOF AND FLOOR DECK ENDS MINIMUM OF 2 INCHES. WHEN FASTENING DECK TO SUPPORT MEMBERS PROVIDE WELDING MATERIALS INSTALLATION PROCEDURES TO PREVENT BURNING OF HOLES IN DECK.

AT ENDS OF DECKS OR WHERE CHANGES OF DECK DIRECTION OCCUR, FASTEN TO SUPPORTS AT EACH FLUTE. PROVIDE ADEQUATE CLOSURES AND FASTENERS TO SIDES AT EIGHTEEN INCHES ON CENTER. WHERE PARTIAL PANELS MAY BE REQUIRED TO COMPLETE DECK INSTALLATION AT PERIMETER OF STRUCTURE, PROVIDE WELDS

IN EACH FLUTE TO STRUCTURAL MEMBERS. INSTALL DECK IN THREE CONTINUOUS SPAN LENGTHS. AT PERIMETER OF DECK, SECURE DECK TO STRUCTURAL MEMBERS WITH SAME ATTACHMENTAND SPACING SUPPORT

ATTACHMENT AS INDICATED ON PLANS. HOT DIP GALVANIZE (G90) AFTER FABRICATION ALL METAL DECK AND TOUCH UP CONNECTIONS WITH A ZINC-RICH PRIMER.

NOTES (IF APPLICABLE):

TREE REMOVAL:

REMOVE ALL TREES INDICATED BY THE DRAWINGS AND SPECIFICATIONS, AS REQUIRING REMOVAL, IN A MANNER THAT WILL NOT DAMAGE ADJACENT TREES OR STRUCTURES OR COMPACTS THE SOIL.

REMOVE TREES THAT ARE ADJACENT TO TREES OR STRUCTURES TO REMAIN, IN SECTIONS, TO LIMIT THE OPPORTUNITY OF DAMAGE TO ADJACENT CROWNS, TRUNKS, GROUND PLANE ELEMENTS AND STRUCTURES. DO NOT DROP TREES WITH A SINGLE CUT UNLESS THE TREE WILL FALL IN AN AREA NOT INCLUDED IN THE TREE AND PLANT

PROTECTION AREA. NO TREE TO BE REMOVED WITHIN 50 FEET OF THE TREE AND PLANT PROTECTION AREA SHALL BE PUSHED OVER OR UP-ROOTED USING A PIECE OF GRADING EQUIPMENT. PROTECT ADJACENT PAVING, SOIL, TREES, SHRUBS, GROUND COVER PLANTINGS AND UNDERSTORY PLANTS TO REMAIN FROM DAMAGE DURING ALL TREE REMOVAL OPERATIONS, AND FROM CONSTRUCTION OPERATIONS. PROTECTION SHALL INCLUDE THE

ROOT SYSTEM, TRUNK, LIMBS, AND CROWN FROM BREAKAGE OR SCARRING, AND THE SOIL FROM COMPACTION. REMOVE STUMPS AND IMMEDIATE ROOT PLATE FROM EXISTING TREES TO BE REMOVED. GRIND TRUNK BASES AND LARGE BUTTRESS ROOTS TO A DEPTH OF THE LARGEST BUTTRESS ROOT OR AT LEAST 18 INCHES BELOW THE TOP MOST ROOTS WHICH

EVER IS LESS AND OVER THE AREA OF THREE TIMES THE DIAMETER OF THE TRUNK (DBH). FOR TREES WHERE THE STUMP WILL FALL UNDER NEW PAVED AREAS, GRIND ROOTS TO A TOTAL DEPTH OF 18 INCHES BELOW THE EXISTING GRADE. IF THE SIDES OF THE STUMP HOLE STILL HAVE GREATER THAN APPROXIMATELY 20% WOOD VISIBLE, CONTINUE GRINDING OPERATION DEEPER AND OR WIDER UNTIL THE RESULTING HOLE HAS LESS THAN 20% WOOD. REMOVE ALL WOOD CHIPS PRODUCED BY THE GRINDING OPERATION AND BACK FILL IN 8 INCH LAYERS WITH CONTROLLED FILL OF A QUALITY ACCEPTABLE TO THE SITE ENGINEER FOR FILL MATERIAL UNDER STRUCTURES, COMPACTED TO 95% OF THE MAXIMUM DRY DENSITY STANDARD PROCTOR. THE OWNER'S REPRESENTATIVE SHALL APPROVE EACH HOLE AT THE END OF THE GRINDING

IN AREAS WHERE THE TREE LOCATION IS TO BE A PLANTING BED OR LAWN, REMOVE ALL WOODCHIPS AND BACKFILL STUMP HOLES WITH PLANTING SOIL AS DEFINED IN SPECIFICATION SECTION PLANTING SOIL, IN MAXIMUM OF 12 INCH LAYERS AND COMPACT TO 80 - 85% OF THE MAXIMUM DRY DENSITY STANDARD PROCTOR.

WITHIN SIX MONTHS OF THE ESTIMATED DATE OF SUBSTANTIAL COMPLETION, PRUNE ALL DEAD OR HAZARDOUS BRANCHES

LARGER THAN 2 INCH IN DIAMETER FROM ALL TREES TO REMAIN.

IMPLEMENT ALL PRUNING RECOMMENDATIONS FOUND IN THE ARBORIST REPORT PRUNE ANY LOW, HANGING BRANCHES AND VINES FROM EXISTING TREES AND SHRUBS THAT OVERHANG WALKS, STREETS AND DRIVES, OR PARKING AREAS AS FOLLOWS:

1. WALKS - WITHIN 8 FEET VERTICALLY OF THE PROPOSED WALK ELEVATION.

2. PARKING AREAS - WITHIN 12 FEET VERTICALLY OF THE PROPOSED PARKING SURFACE ELEVATION.

3. STREETS AND DRIVES - WITHIN 14 FEET VERTICALLY OF THE PROPOSED DRIVING SURFACE ELEVATION.

ALL PRUNING SHALL BE DONE IN ACCORDANCE WITH ANSI A300 (PART 1), ISA BMP TREE PRUNING (LATEST EDITION, AND THE "STRUCTURAL PRUNING: A GUIDE FOR THE GREEN INDUSTRY", EDWARD GILMAN, BRIAN KEMPF, NELDA MATHENY AND JIM CLARK. 2013 URBAN TREE FOUNDATION, VISALIA CA.

PERFORM OTHER PRUNING TASK AS INDICATED ON THE DRAWINGS OR REQUESTED BY THE OWNER'S REPRESENTATIVE. WHERE TREE SPECIFIC DISEASE VECTORS REQUIRE, STERILIZE ALL PRUNING TOOLS BETWEEN THE WORK IN INDIVIDUAL TREES.

ABBREVIATIONS: GENERAL DRAWING SYMBOLS:

ALUMINUM

CORRIDOR

CORROSION

ELEVATION

FLOOR DRAIN

HARDWARE

JANITOR CLOSE

HEIGHT

MASONRY

MINIMUM

MOUNTED

ROOF DRAIN

REQUIRED

SMOOTH CEMENT PLAS

UNLESS OTHERWISE NOTE

STAINLESS STEEL

STORM SEWER

STRUCTURAL

TOP OF STEEL

TELEPHONE

T.O.S.

U.O.N.

TOP OF MASONRY

DROP MANHOLE

VERIFY IN FIELD

NOT IN CONTRA

NOT APPLICABLE

MECHANICAL

CENTER TO CENTER

CONCRETE MASONRY UNIT

FINISH FLOOR ELEVATION

FINISH FLOOR LEVEL

EXISTING WALL NEW CONCRETE BLOCK WALL 6" OR 8" NEW PLYCEM BOARD WALL

CONDITION BELOW, ABOVE OR BEHIND AS INDICATED.

> DETAIL REFERENCE NUMBER DETAIL REFERENCE SYMBOL SHEET WHERE DETAIL IS DRAWN

> > ELEVATION REFERENCE NUMBER

SHEET WHERE ELEVATION IS DRAWN SECTION REFERENCE NUMBER GENERAL BUILDING SECTION - SHEET WHERE SECTION IS DRAW!

 WALL SECTION REFERENCE NUMBER WALL SECTION

SHEET WHERE INT. ELEV. IS DRAWN

INTERIOR ELVATION SYMBOL **ELEVATION REFERENCE NUMBER**

NORTH ARROW

DOOR SYMBOL

WINDOW SYMBO KEY NOTE

LEVEL SYMBOL

ROOM IDENTIFICATION

HANDICAPPED SYMBOL

REVISION SYMBO

EQUIPMENT SYMBOL

RISER SYMBOL

AIR CONDITIONING

THIS DOCUMENT REPRESENTS THE IDEAS AND EFFORTS OF CSA ARCHITECTS AND ENGINEERS. IT SHALL BE USED ONLY BY AUTHORIZED PERSONS AND SHALL NOT BE REPRODUCED OR EXHIBITED WITHOUT WRITTEN CONSENT OF

CSA ARCHITECTS AND ENGINEERS.

PUERTO RICO INDUSTRIAL DEVELOPMENT COMPANY PRIDCO

ISSUE FOR BID

FEBRUARY 21, 2024

	REV	DATE	DESCRIPTION					
C								
	DISCIPLINE INFORMATION:							
	PRIME PROFESIONAL:							
	ANNETTE ALFONSO							
	PROFESSI	ONAL OF RECO	RD:					
	ANNET	ANNETTE ALFONSO						
	STAFF DES	STAFF DESIGNER:						
	JOHANNA SALCEDO							
	Q.C. AUDIT	OR:						
	DDINICIDAL	. CAD TECHNICI	ANI-					
1	- Alinon'AL	. O. D I LOI INIOI	/ 11 1.					

PROFESSIONAL'S STATEMENT:

YO, ANNETTE ALFONSO

CERTIFICO QUE SOY EL PROFESIONAL QUE [CONFECCIONÓ, DISEÑÓ O PREPARÓ] ESTOS PLANOS TAMBIÉN, CERTIFICO QUE ENTIENDO QUE DICHOS PLANOS Y ESPECIFICACIONES CUMPLEN CON LAS DISPOSICIONES APLICABLES DEL REGLAMENTO CONJUNTO Y LAS DISPOSICIONES APLICABLES DE LOS REGLAMENTOS Y CÓDIGOS DE CONSTRUCCIÓN VIGENTES DE LAS AGENCIAS JUNTAS REGLAMENTADORAS O CORPORACIONES PÚBLICAS CON JURISDICCIÓN. CERTIFICO, ADEMÁS, QUE EN LAPREPARACIÓN DE ESTOS PLANOS Y ESPECIFICACIONES SE HA CUMPLIDO CABALMENTE CON LO DISPUESTO EN LA LEY NÚM. 14 DE 8 DE ENERO DE 2004. SEGÚN ENMENDADA, CONOCIDA COMO LA "LEY PARA LA INVERSIÓN POR LA INDUSTRIA PUERTORRIQUEÑA" Y CON LA [LEY NÚM. 319 DE 15 DE MAYO DE 1938, SEGÚN ENMENDADA; LEY NÚM. 96 DE 6 DE JULIO DE 1978, SEGÚN ENMENDADA: SEGÚN APLIQUEI, RECONOZCO QUE CUALQUIER DECLARACIÓN FALSA O FALSIFICACIÓN DE LOS HECHOS QUE SE HAYA PRODUCIDO POR DESCONOCIMIENTO O POR NEGLIGENCIA YA SEA POR MÍ, MIS AGENTES O EMPLEADOS, O POR OTRAS PERSONAS CON MI CONOCIMIENTO. ME HACEN

PRIDCO DAMAGE IMPROVEMENTS **NORTH REGION STAGE 1 BID PACKAGE N1-3**

PW: 7801 / QUEBRADILLAS

RESPONSABLE DE CUALQUIER ACCIÓN JUDICIAL Y

DISCIPLINARIA POR LA OGPE.

SHEET TITLE:

GENERAL NOTES, ABBREVIATIONS AND LEGEND

AS SHOWN


PROJECT NUMBER:

21-0258-02


BIM FILE NAME:


DELIVERY DATE PRINT DATE & TIME: 4/22/2024 3:28:21 PM

DRAWING / MODEL LOCATION:

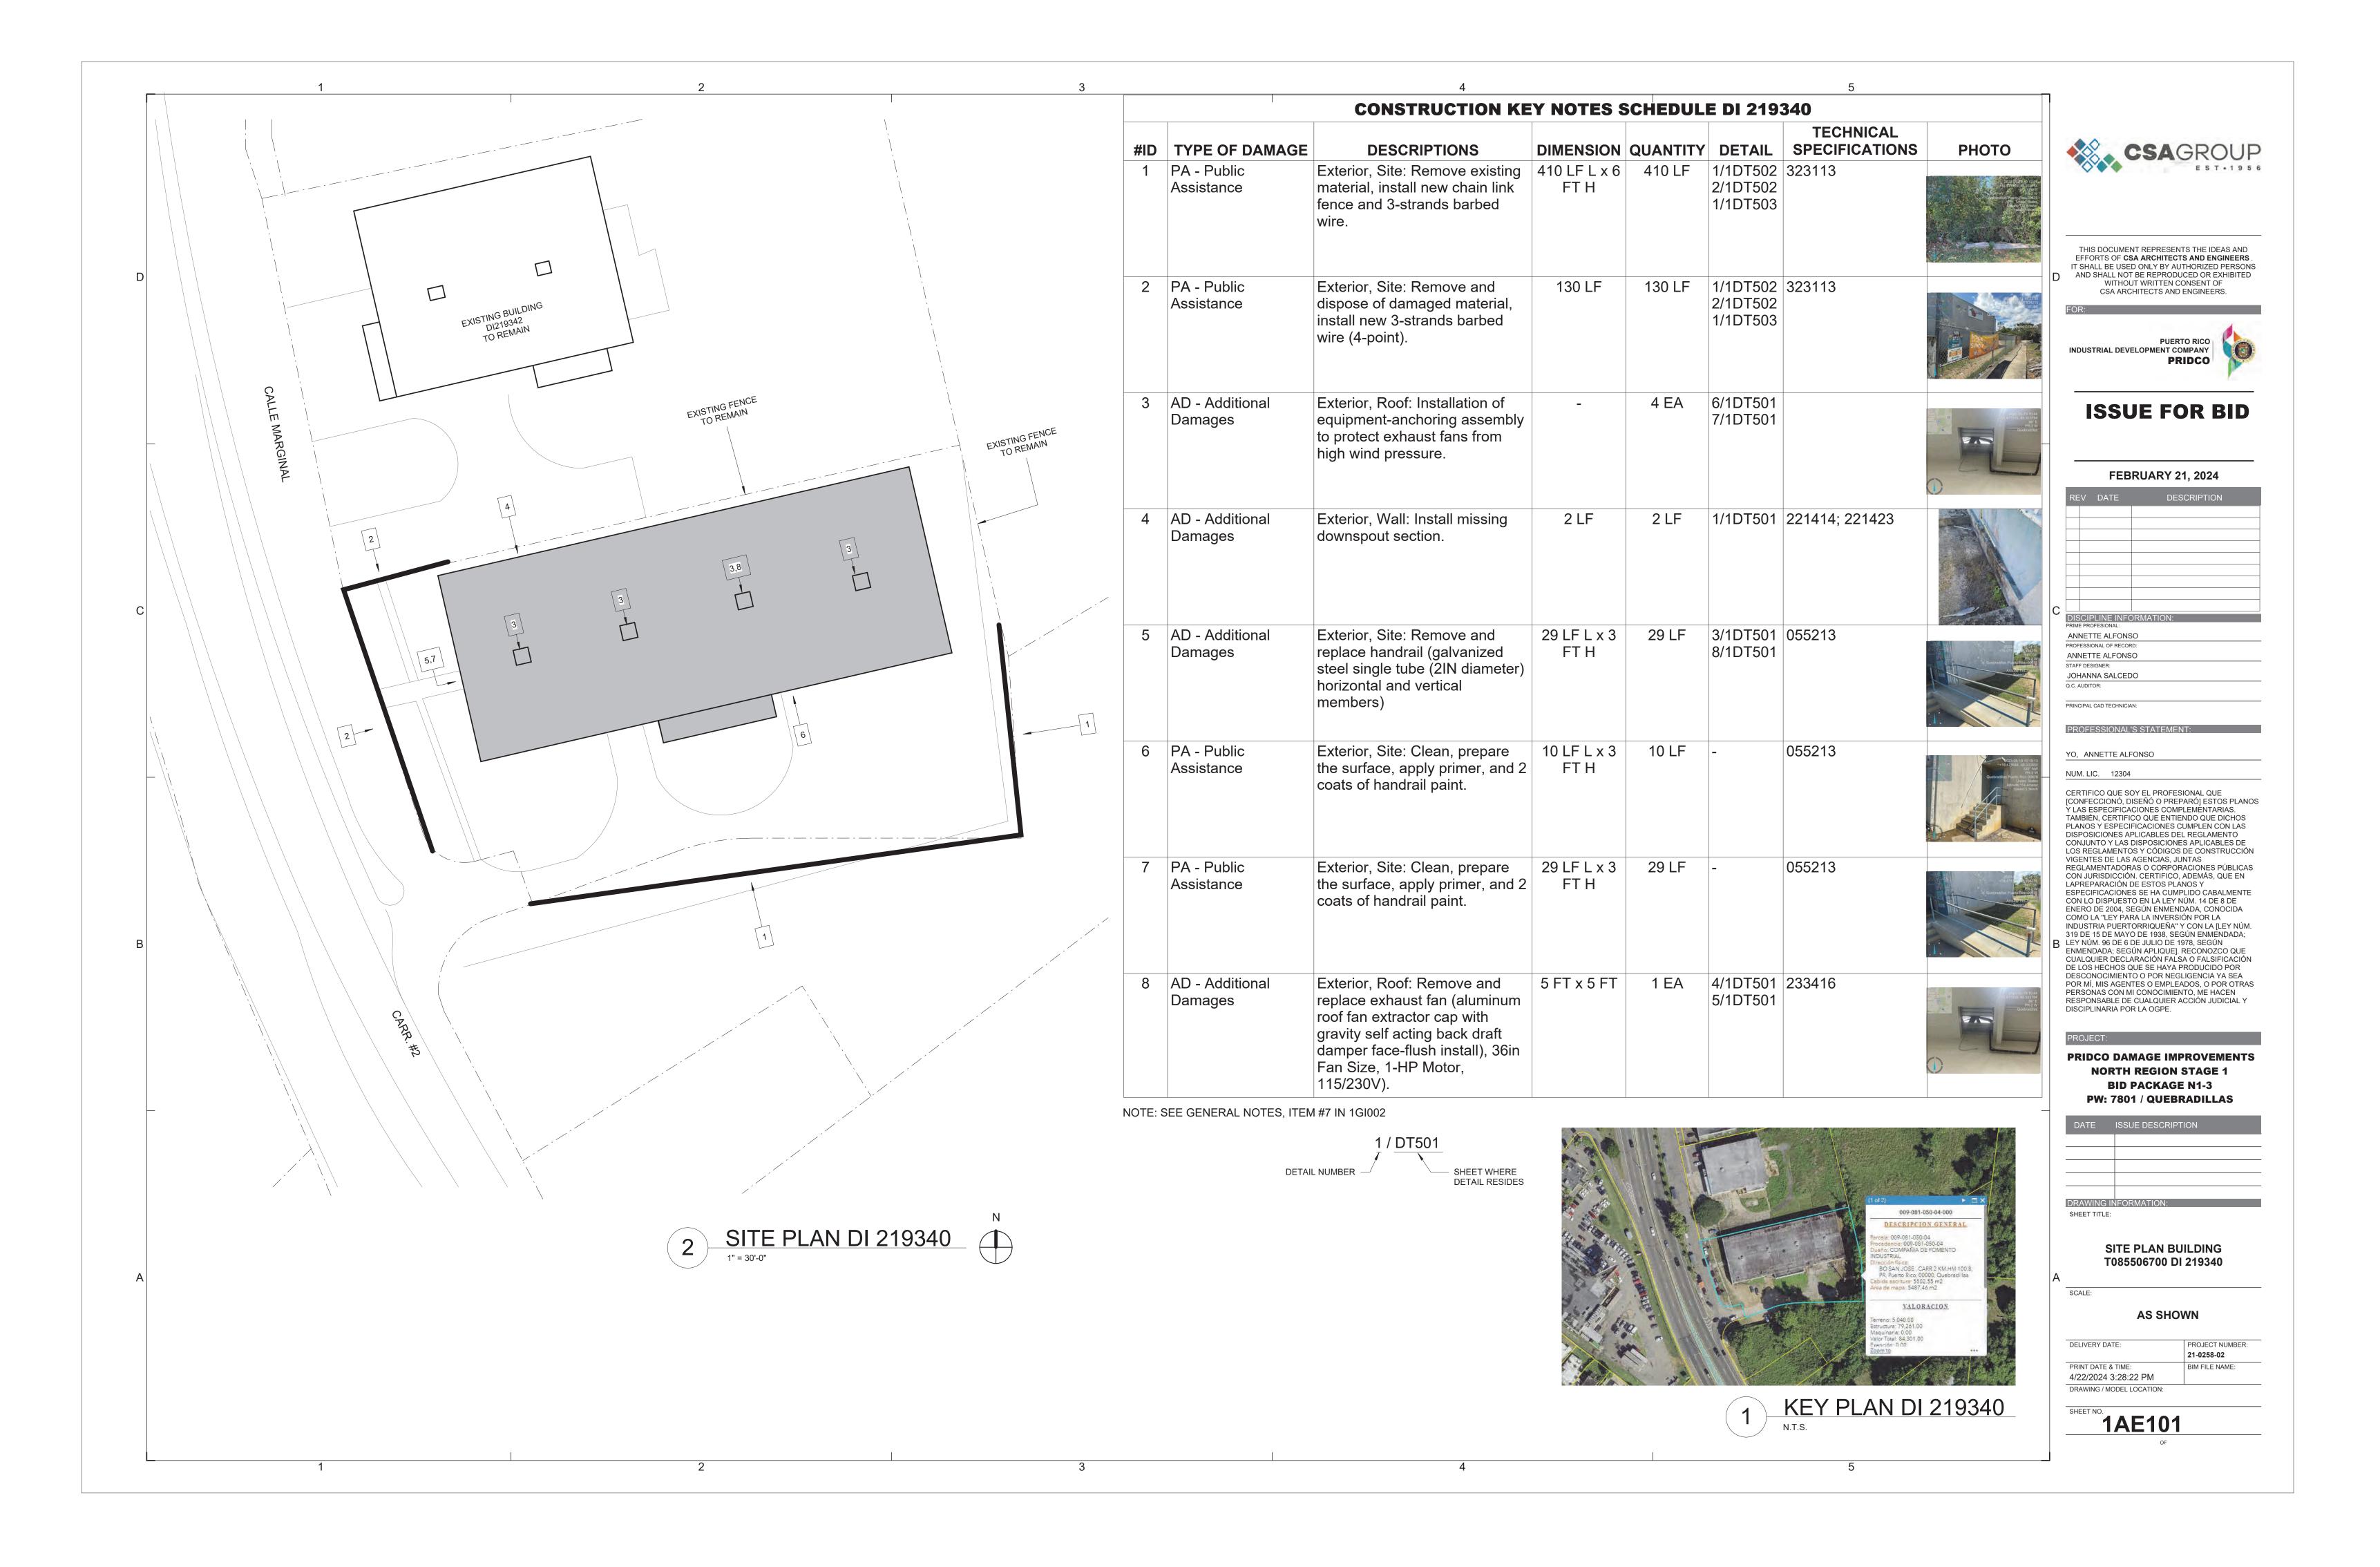

2" DIA. GUARDRAIL AT 42" TYP. 1-1/2" DIA. HANDRAIL AT 36" TYP. FAN SHALL BE PROVIDED WITH HURRICANE TIE DOWNS. HURRICANE TIE-DOWN ATTACHEMENT TO ROOF SHALL THIS DOCUMENT REPRESENTS THE IDEAS AND BE DESIGNED AND SIGNED BY A EFFORTS OF CSA ARCHITECTS AND ENGINEERS. LICENSED ENGINEER, AND IT SHALL BE USED ONLY BY AUTHORIZED PERSONS SHALL BE SUBMITTED FOR APPROVAL. SEE SPECIFICATION AND SHALL NOT BE REPRODUCED OR EXHIBITED EXHAUST FAN WITHOUT WRITTEN CONSENT OF 233416 (CENTRIFUGAL HVAC CSA ARCHITECTS AND ENGINEERS. PUERTO RICO RAMP CURB IS -INDUSTRIAL DEVELOPMENT COMPANY EQ. TO 12" SLOPE OF RAMP REQ. (MIN . 2") PRIDCO MUST BE 1:12 **ISSUE FOR BID** SEE DETAIL ON HANDRAIL ANCHORAGE IN DT501 ROOF **FEBRUARY 21, 2024** 6 EXHAUST FAN ROOF TIE-DOWN
N.T.S. V DATE DESCRIPTION TYP. BOLTED ALL AROUND @ 6" c./c. EXISTING EXHAUST FAN 2" DIA. GUARDRAIL AT 42" TYP. DISCIPLINE INFORMATION: PRIME PROFESIONAL: 1-1/2" DIA. HANDRAIL AT 36" TYF ANNETTE ALFONSO ANNETTE ALFONSO PREFABRICATED CURB AND NEW 1-1/2" DIA. GALVANIZED STAFF DESIGNER: COUNTERFLASHING BY HVAC STEEL PIPE POST WELDED TO JOHANNA SALCEDO CONTRACTOR THE BRACKET Q.C. AUDITOR: PRINCIPAL CAD TECHNICIAN: NEW (2) 1/4" MIN. Ø 3"LONG ANCHOR BOLTS DRILL EXISTING CONCRETE PROFESSIONAL'S STATEMENT: & FILL WITH EPOXY, TYP. BOLTED ALL AROUND @ 6" c./c. — YO, ANNETTE ALFONSO NUM. LIC. 12304 NEW 1/4" TH. 3" W x **5" L GALVANIZED** SEE **DETAIL #11** ON HANDRAIL CERTIFICO QUE SOY EL PROFESIONAL QUE [CONFECCIONÓ, DISEÑÓ O PREPARÓ] ESTOS PLANOS STEEL PLATE ANCHORAGE ON SHEET # 1DT501 TAMBIÉN, CERTIFICO QUE ENTIENDO QUE DICHOS PLANOS Y ESPECIFICACIONES CUMPLEN CON LAS DISPOSICIONES APLICABLES DEL REGLAMENTO CONJUNTO Y LAS DISPOSICIONES APLICABLES DE LOS REGLAMENTOS Y CÓDIGOS DE CONSTRUCCIÓN EXISTING STAIRS — EQ. TO TREAD DEPTH NOTE: STAIR HANDRAIL AT BOTTOM OF STAIR VIGENTES DE LAS AGENCIAS, JUNTAS FLASHING BY G.C. REQUIRES AN EXTENSION FOLLOWING THE REGLAMENTADORAS O CORPORACIONES PÚBLICAS SAME INCLINE AND EXTENDS THE DEPTH OF CON JURISDICCIÓN. CERTIFICO, ADEMÁS, QUE EN LAPREPARACIÓN DE ESTOS PLANOS Y ESPECIFICACIONES SE HA CUMPLIDO CABALMENTE CON LO DISPUESTO EN LA LEY NÚM. 14 DE 8 DE ENERO DE 2004, SEGÚN ENMENDADA, CONOCIDA COMO LA "LEY PARA LA INVERSIÓN POR LA EXISTING DUCTWORK INDUSTRIA PUERTORRIQUEÑA" Y CON LA [LEY NÚM. 319 DE 15 DE MAYO DE 1938, SEGÚN ENMENDADA; LEY NÚM. 96 DE 6 DE JULIO DE 1978, SEGÚN EXHAUST FAN ROOF CURB TYP. GUARDRAIL AND HANDRAIL ENMENDADA; SEGÚN APLIQUE]. RECONOZCO QUE CUALQUIER DECLARACIÓN FALSA O FALSIFICACIÓN DE LOS HECHOS QUE SE HAYA PRODUCIDO POR AT EXISTING STAIRS HANDRAIL ANCHORAGE DETAIL DETAIL DESCONOCIMIENTO O POR NEGLIGENCIA YA SEA POR MÍ, MIS AGENTES O EMPLEADOS, O POR OTRAS PERSONAS CON MI CONOCIMIENTO, ME HACEN RESPONSABLE DE CUALQUIER ACCIÓN JUDICIAL Y DISCIPLINARIA POR LA OGPE. 4" EXISTING **INSULATED METAL CURB** 3/8" GALV FORGED EYE **ELBOW** BOLT, EYE SHALL BE **PRIDCO DAMAGE IMPROVEMENTS** COUNTERFLASHING STRONG ENOUGH TO **NORTH REGION STAGE 1** DEVELOP FULL STRENGTH FOIL CLAD, MODIFIED BITUMEN FINISH PLY OF BOLT IN TENSION, **BID PACKAGE N1-3** BOLT TO BE ASTM A307 PW: 7801 / QUEBRADILLAS EXISTING CONC. SLAB LIGHTWEIGHT RANDOM FIBROUS GLASS MAT IMPREGNATED AND COATED WITH HIGH-QUALITY SBS-MODIFIED BITUMEN, ANCHOR IN TO CONCRETE WITH HLTI HDI-AND SURFACED WITH CERAMIC GRANULES P TZ DROP-IN ANCHOR OR SIMILAR QUANTITY OF ANCHORS SHAL BE DESIGN BASED ON CALCULATED TIE TENSION FIBERGLASS SCRIM/FIBERGLASS MAT COMPOSITE IMPREGNATED AND COATED WITH QUALITY STYRENE-BUT **NEW PIPE** ADIENE STYRENE (SBS) MODIFIED BITUMEN **BRACKET** SUPPORT NON-COMBUSTIBLE CANT - CONCRETE ROOF MEMBRANE SYSTEM SHEET TITLE: SAME DIAMETER AS EXISTING NEW 24"x24" SPLASH BLOCK **DETAILS AND SPECIFICATIONS** EXISTING FINISH FLOOR **AS SHOWN** DELIVERY DATE: PROJECT NUMBER: 21-0258-02 EXHAUST FAN ROOF TIE-DOWN FLASHING AT EXHAUST FAN PRINT DATE & TIME: BIM FILE NAME: 4/22/2024 3:28:23 PM **CURB DETAIL** ROOF ANCHOR TYP. DOWNSPOUT DRAWING / MODEL LOCATION: 1DT501

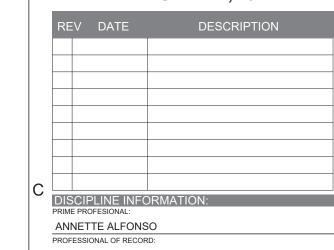

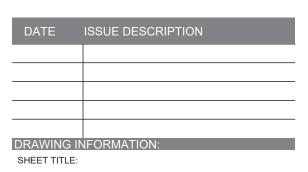


ACORN TOP

TOP RAIL

ALUM TOP
RAIL OR BRACE END

RAIL OR BRACE END

BRACE ROD
AND
TURNBUCKLE

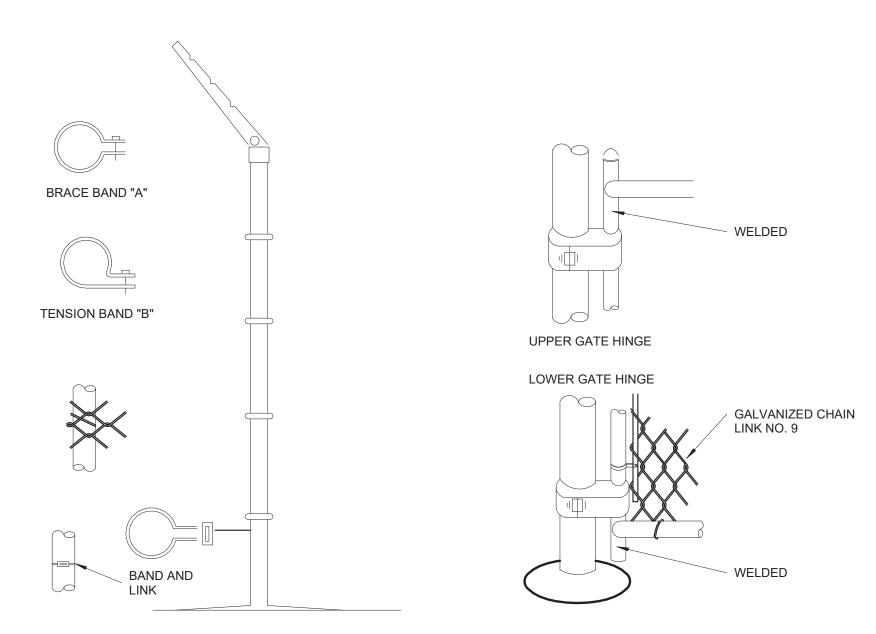


INSTALLATION DETAILS FOR CHAIN LINK FENCE & GATES

N.T.S.

NOTES:

- 1. CHAIN LINK FENCE INDUSTRIAL TYPE NO.423
- 2. LINE POSTS 2 1/2" O.D. GALV. STD.WEIGHT PIPE-3.85 LBS. PER LIN. FT.
- 3. TOP RAIL 1 5/8" O.D. GALV. STD.WEIGHT PIPE-2.27 LBS. PER LIN. FT. (GATE FRAME IDEM.)
- 4. CORNER POST 3"Ø O.D. GALV. STD. WEIGHT PIPE 6.79 LBS. PER LIN. FT.
- 5. TENSION WIRE GA. NO.7 GALVANIZED
- 6. GATE POST 4"O.D. GALV. STD. WEIGHT PIPE 9.10 LBS. PER LIN. FT.
- 7. GALVANIZED CHAIN LINK GA. 9-2"X2"-1.2 OUNCES GALVANIZED AFTER WOOVEN.
- 8. STD. WEIGHT PIPE, SCHEDULE 40A. 120
- 9. TUBULAR STEEL PIPE SHALL BE INSTALL EVERY 50'-0" PANEL SPAN (SPAN=10'-0')
 TUBULAR STEEL PIPE SHALL BE INSTAL EVERY DIRECTIONS CHANGE IN THE FENCE.
 TUBULAR STEEL PIPE SHALL BE INSTALL AT EACH FENCE END PANEL.
- 10. ALL FITTINGS EXTRA HEAVY DUTY.
- 11. MILL CERTIFICATE SHALL BE SUBMITTED.

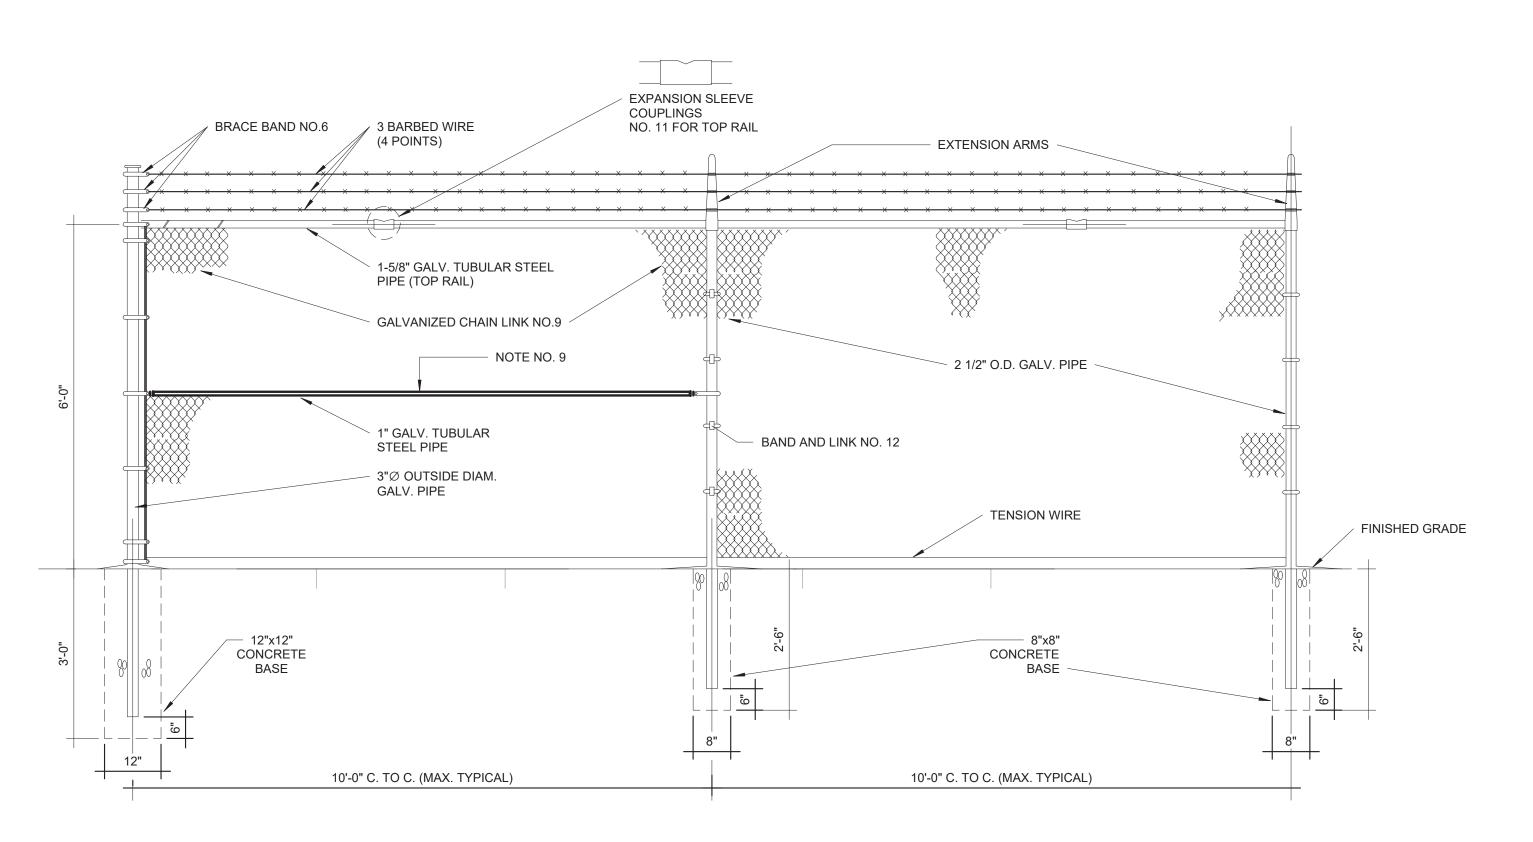

CHAIN LINK FENCE WITH BARBED WIRE PARTIAL ELEVATION

(ALONG PROPERTY LIMITS)

N.T.S.



THIS DOCUMENT REPRESENTS THE IDEAS AND EFFORTS OF **CSA ARCHITECTS AND ENGINEERS**. IT SHALL BE USED ONLY BY AUTHORIZED PERSONS AND SHALL NOT BE REPRODUCED OR EXHIBITED WITHOUT WRITTEN CONSENT OF CSA ARCHITECTS AND ENGINEERS.

PUERTO RICO
INDUSTRIAL DEVELOPMENT COMPANY
PRIDCO



FEBRUARY 21, 2024

Ш	REV	DATE	DESCRIPTION
		PLINE INFO	DRMATION:

PRIME PROFESIONAL:

ANNETTE ALFONSO

PROFESSIONAL OF RECORD:

ANNETTE ALFONSO

STAFF DESIGNER:

JOHANNA SALCEDO

Q.C. AUDITOR:

PRINCIPAL CAD TECHNICIAN:

PROFESSIONAL'S STATEMENT:

YO, ANNETTE ALFONSO

_____NUM. LIC. 12304

CERTIFICO QUE SOY EL PROFESIONAL QUE [CONFECCIONÓ, DISEÑÓ O PREPARÓ] ESTOS PLANOS VI AS ESDECIEICACIONES COMDI EMĒNI TAMBIÉN, CERTIFICO QUE ENTIENDO QUE DICHOS PLANOS Y ESPECIFICACIONES CUMPLEN CON LAS DISPOSICIONES APLICABLES DEL REGLAMENTO CONJUNTO Y LAS DISPOSICIONES APLICABLES DE LOS REGLAMENTOS Y CÓDIGOS DE CONSTRUCCIÓN VIGENTES DE LAS AGENCIAS, JUNTAS REGLAMENTADORAS O CORPORACIONES PÚBLICAS CON JURISDICCIÓN. CERTIFICO, ADEMÁS, QUE EN LAPREPARACIÓN DE ESTOS PLANOS Y ESPECIFICACIONES SE HA CUMPLIDO CABALMENTE CON LO DISPUESTO EN LA LEY NÚM. 14 DE 8 DE ENERO DE 2004, SEGÚN ENMENDADA, CONOCIDA COMO LA "LEY PARA LA INVERSIÓN POR LA INDUSTRIA PUERTORRIQUEÑA" Y CON LA [LEY NÚM. 319 DE 15 DE MAYO DE 1938, SEGÚN ENMENDADA; LEY NÚM. 96 DE 6 DE JULIO DE 1978, SEGÚN ENMENDADA; SEGÚN APLIQUE]. RECONOZCO QUE CUALQUIER DECLARACIÓN FALSA O FALSIFICACIÓN DE LOS HECHOS QUE SE HAYA PRODUCIDO POR DESCONOCIMIENTO O POR NEGLIGENCIA YA SEA POR MÍ, MIS AGENTES O EMPLEADOS, O POR OTRAS PERSONAS CON MI CONOCIMIENTO, ME HACEN RESPONSABLE DE CUALQUIER ACCIÓN JUDICIAL Y DISCIPLINARIA POR LA OGPE.

PRIDCO DAMAGE IMPROVEMENTS NORTH REGION STAGE 1 BID PACKAGE N1-3

PW: 7801 / QUEBRADILLAS

DATE ISSUE DESCRIPTION

DRAWING INFORMATION:
SHEET TITLE:

DETAILS AND SPECIFICATIONS

AS SHOWN

DELIVERY DATE:


PROJECT NUMBER:
21-0258-02

PRINT DATE & TIME:
4/22/2024 3:28:23 PM

DRAWING / MODEL LOCATION:


1DT502

3

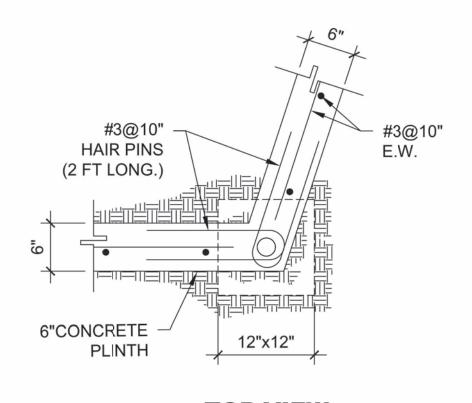


TOP VIEW

ADDITIONAL REINFORCEMENT AT FENCE POLE LOCATION (AT CORNERS)

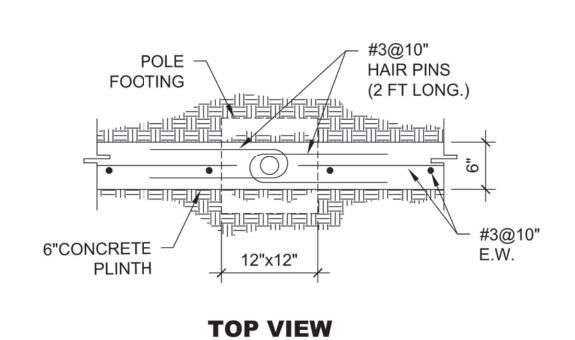


ADDITIONAL REINFORCEMENT AT FENCE POLE LOCATION

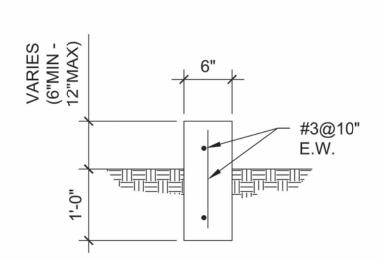

TYPICAL 6" CONCRETE
PLINTH SECTION

NOTES:

- 1. CHAIN LINK FENCE INDUSTRIAL TYPE NO.423
- 2. LINE POSTS 2 7/8" O.D. GALV. STD.WEIGHT PIPE.
- 3. TOP RAIL 1 5/8" O.D. GALV. STD.WEIGHT PIPE. PER LIN. FT. (GATE FRAME IDEM.)
- 4. CORNER POST 2 7/8" Ø O.D. GALV. STD. WEIGHT PIPE
- 5. TENSION WIRE GA. NO.7 GALVANIZED
- 6. GATE POST 4"O.D. GALV. STD. WEIGHT PIPE 9.10 LBS. PER LIN. FT.
- 7. GALVANIZED CHAIN LINK GA. 9-2"X2"-1.2 OUNCES GALVANIZED AFTER WOOVEN.
- 8. STD. WEIGHT PIPE, SCHEDULE 40A. 120 9. ALL FITTINGS EXTRA HEAVY DUTY 10. MILL CERTIFICATE SHALL BE SUBMITTED.
- 9. TUBULAR STEEL PIPE SHALL BE INSTALL EVERY 50'-0" PANEL SPAN (SPAN=10'-0')
 TUBULAR STEEL PIPE SHALL BE INSTAL EVERY DIRECTIONS CHANGE IN THE FENCE.
 TUBULAR STEEL PIPE SHALL BE INSTALL AT EACH FENCE END PANEL.
- 10. ALL FITTINGS EXTRA HEAVY DUTY.
- 11. MILL CERTIFICATE SHALL BE SUBMITTED.

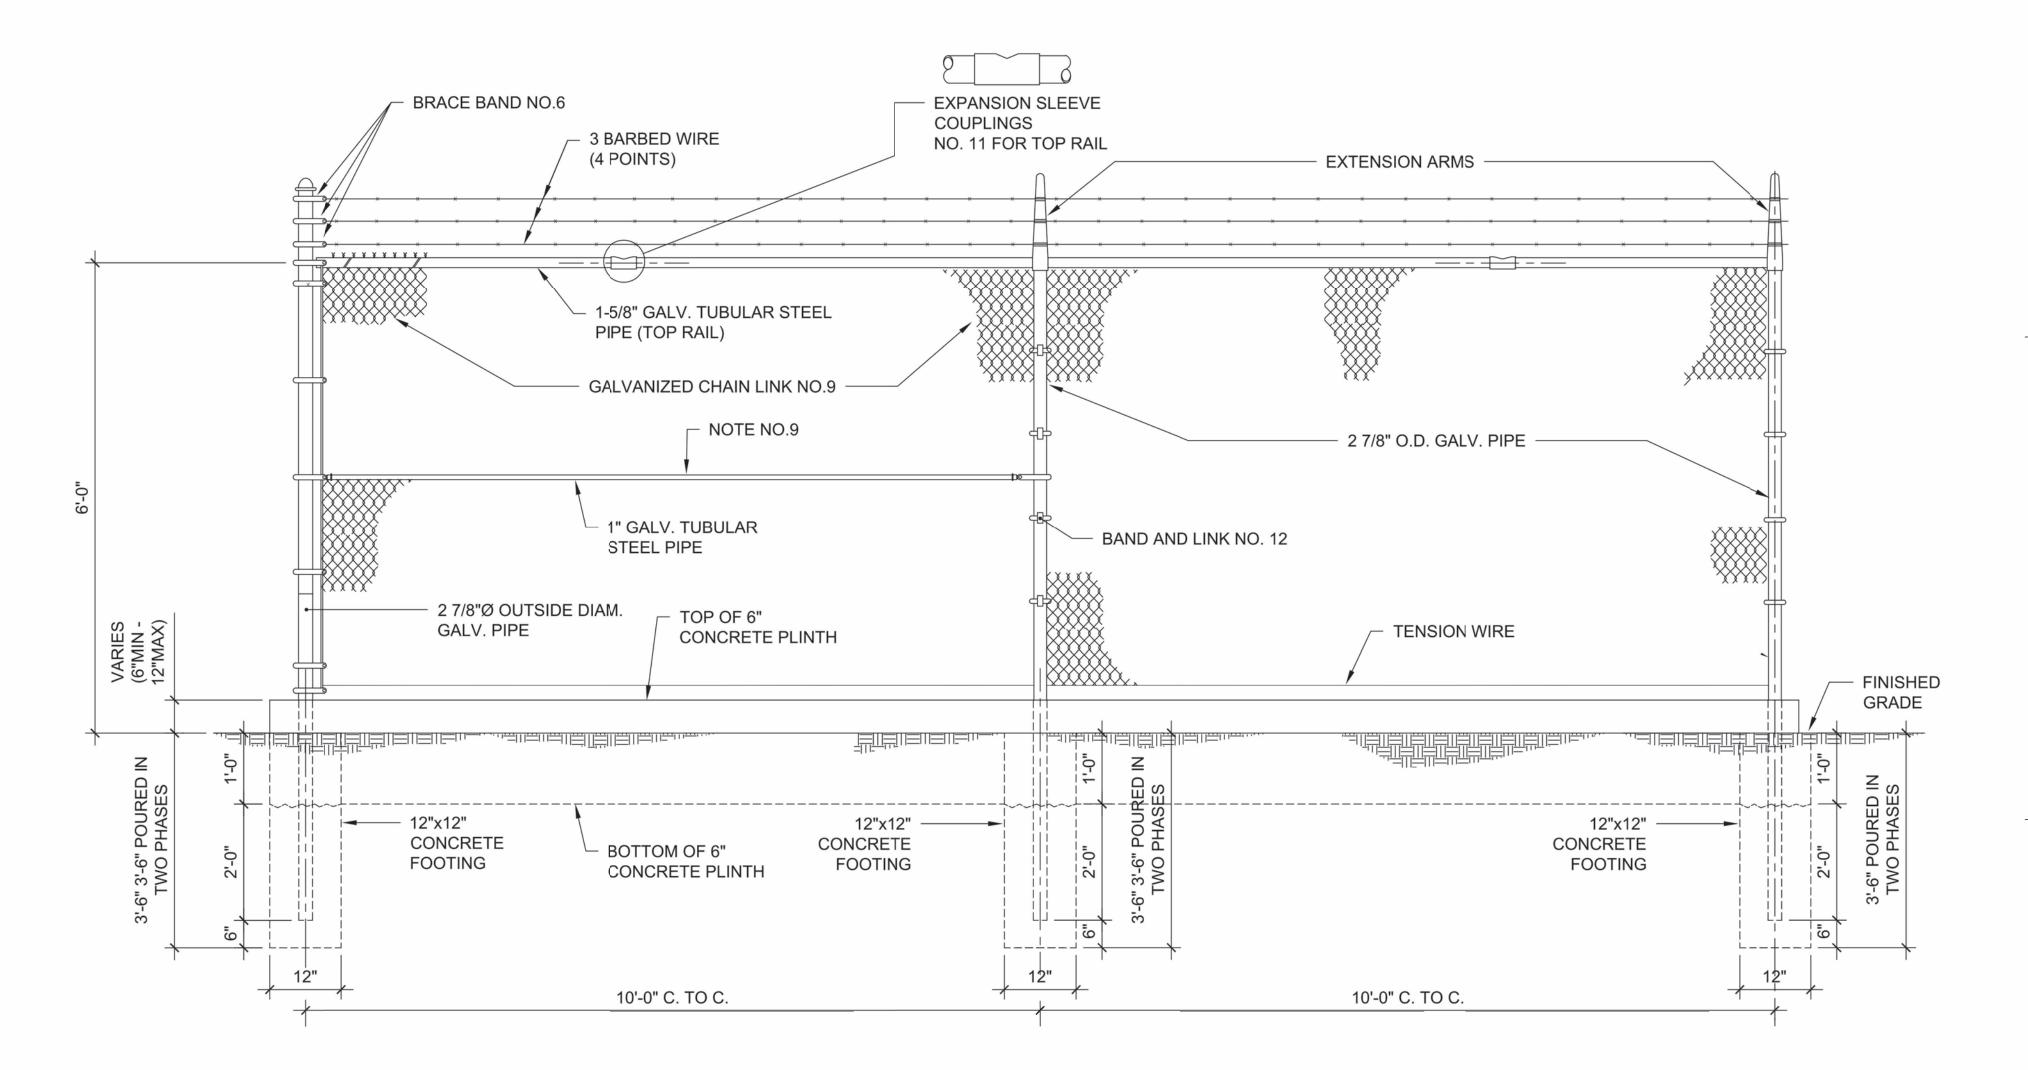

CHAIN LINK FENCE PARTIAL ELEVATION (ALONG PROPERTY LIMITS)

CHAIN LINK FENCE WITH BARBED
WIRE AND CONCRETE PLINTH



THIS DOCUMENT REPRESENTS THE IDEAS AND EFFORTS OF **CSA ARCHITECTS AND ENGINEERS**. IT SHALL BE USED ONLY BY AUTHORIZED PERSONS AND SHALL NOT BE REPRODUCED OR EXHIBITED WITHOUT WRITTEN CONSENT OF CSA ARCHITECTS AND ENGINEERS.

PUERTO RICO
INDUSTRIAL DEVELOPMENT COMPANY

PRIDCO

ISSUE FOR BID

FEBRUARY 21, 2024

	RE	V [DATE	DESCRIPTION
_				
			INE INFO	DRMATION:

PRIME PROFESIONAL:

ANNETTE ALFONSO

PROFESSIONAL OF RECORD:

ANNETTE ALFONSO

STAFF DESIGNER:

JOHANNA SALCEDO

PRINCIPAL CAD TECHNICIAN

NUM. LIC. 12304

PROFESSIONAL'S STATEMENT:
YO, ANNETTE ALFONSO

CERTIFICO QUE SOY EL PROFESIONAL QUE [CONFECCIONÓ, DISEÑÓ O PREPARÓ] ESTOS PLANOS Y LAS ESPECIFICACIONES COMPLEMENTARIAS. TAMBIÉN, CERTIFICO QUE ENTIENDO QUE DICHOS PLANOS Y ESPECIFICACIONES CUMPLEN CON LAS DISPOSICIONES APLICABLES DEL REGLAMENTO CONJUNTO Y LAS DISPOSICIONES APLICABLES DE LOS REGLAMENTOS Y CÓDIGOS DE CONSTRUCCIÓN VIGENTES DE LAS AGENCIAS, JUNTAS REGLAMENTADORAS O CORPORACIONES PÚBLICAS CON JURISDICCIÓN. CERTIFICO, ADEMÁS, QUE EN

LAPREPARACIÓN DE ESTOS PLANOS Y
ESPECIFICACIONES SE HA CUMPLIDO CABALMENTE
CON LO DISPUESTO EN LA LEY NÚM. 14 DE 8 DE
ENERO DE 2004, SEGÚN ENMENDADA, CONOCIDA
COMO LA "LEY PARA LA INVERSIÓN POR LA
INDUSTRIA PUERTORRIQUEÑA" Y CON LA [LEY NÚM.
319 DE 15 DE MAYO DE 1938, SEGÚN ENMENDADA;
LEY NÚM. 96 DE 6 DE JULIO DE 1978, SEGÚN
ENMENDADA; SEGÚN APLIQUE]. RECONOZCO QUE
CUALQUIER DECLARACIÓN FALSA O FALSIFICACIÓN
DE LOS HECHOS QUE SE HAYA PRODUCIDO POR
DESCONOCIMIENTO O POR NEGLIGENCIA YA SEA
POR MÍ, MIS AGENTES O EMPLEADOS, O POR OTRAS

PERSONAS CON MI CONOCIMIENTO, ME HACEN RESPONSABLE DE CUALQUIER ACCIÓN JUDICIAL Y DISCIPLINARIA POR LA OGPE.

PROJECT:

PRIDCO DAMAGE IMPROVEMENTS
NORTH REGION STAGE 1
BID PACKAGE N1-3
PW: 7801 / QUEBRADILLAS

DATE ISSUE DESCRIPTION

DRAWING INFORMATION:
SHEET TITLE:


DETAILS AND SPECIFICATIONS


AS SHOWN

DELIVERY DATE: PROJECT NUMBER:


PRINT DATE & TIME:
4/22/2024 3:28:26 PM

DRAWING / MODEL LOCATION:

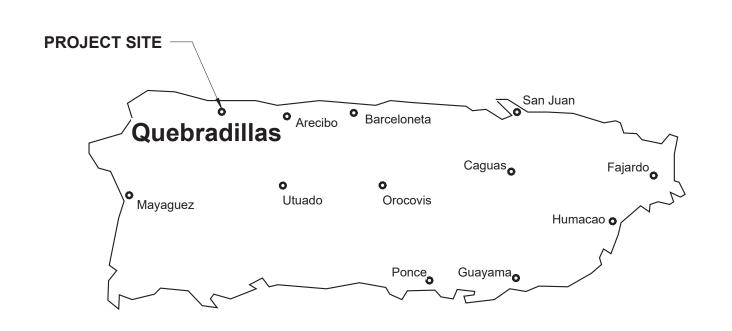

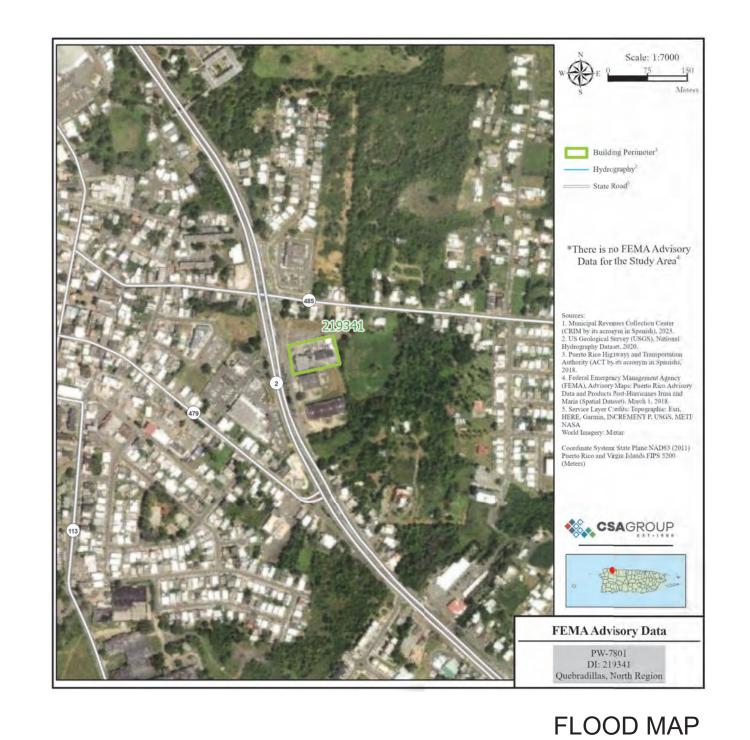



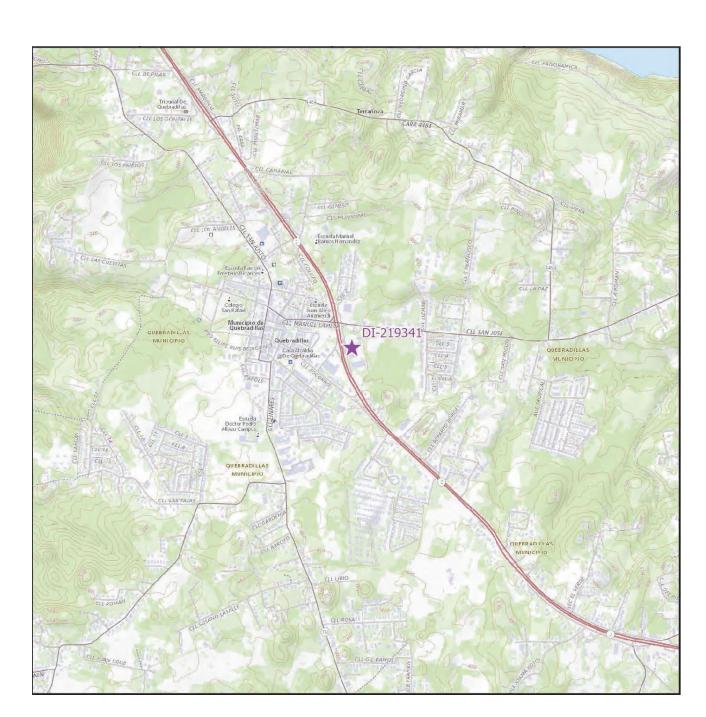

AERIAL PHOTO 18.47259, -66.93419


LOCATION MAP SCALE 1: 20,000

INDEX OF DRAWINGS - PW 7801, DI 219341						
	Sheet	Current				
Discipline	Number	Revision	Sheet Name			
00-GENERAL	2GI001		COVER SHEET - DI 219341			
00-GENERAL	2GI002		GENERAL NOTES, ABBREVIATIONS AND LEGEND			
03-ARCHITECTURAL	2AE101		SITE PLAN BUILDING T095407000 DI 219341			
05-DETAILS	2DT501		DETAILS AND SPECIFICATIONS			
05-DETAILS	2DT502		DETAILS AND SPECIFICATIONS			

PRIDCO-FEMA 4339 DR PROGRAM NORTH REGION STAGE 1 BID PACKAGE N1-3


2. PW: 7801 | DI: 219341 | Bldg: T095407000

Road PR-2, Km. 100.6, San Jose Ward. Quebradillas, Puerto Rico

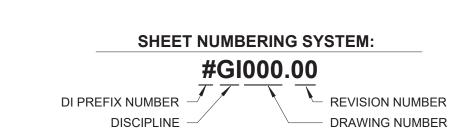





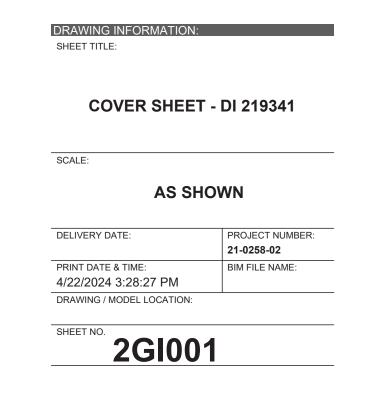

GENERAL NOTES

- PERFORM WORK IN ACCORDANCE WITH OSHA RULES AND REGULATIONS. COMPLY WITH THE REQUIREMENTS SET FORTH BY THE PR BUILDING CODE 2018, PR FIRE CODE 2018, PR MECHANICAL CODE 2018, PR PLUMBING CODE 2018, PR EXISTING BUILDING CODE 2018, ICC SUITE CODES 2018, AND WITH OTHER CODES, STANDARDS, AND REGULATIONS CALLED FOR IN SAID CODES
- COMPLY WITH APPLICABLE RULES AND REGULATIONS FOR OBTAINING NECESSARY AND REQUIRED INSPECTIONS, APPROVALS AND PERMITS NECESSARY TO PERFORM WORK AND SERVICES FOR THE PROJECT.
- EXECUTE WORK IN ACCORDANCE WITH THE BEST ACCEPTED TRADE PRACTICES, AS PER MANUFACTURER'S WRITTEN RECOMMENDATIONS, AND IN A CAREFUL AND ORDERLY MANNER WITH THE LEAST POSSIBLE NOISE, DUST, OR DISTURBANCE TO OCCUPANTS.
- IMPLEMENT SAFETY CONTROLS DURING DEMOLITION/CONSTRUCTION
- DAILY REMOVE DEBRIS RESULTING FROM DEMOLITION/CONSTRUCTION AND TRANSPORT IT OUT OF PROJECT LIMITS. PERFORM DISPOSAL OPERATION IN ACCORDANCE WITH GOVERNMENT APPROVALS AND REGULATIONS. SITE AND STRUCTURE SHALL BE LEFT BROOM CLEAN FOR
- SUBSTANTIAL COMPLETION. DO NOT SCALE DRAWINGS. VERIFY DIMENSIONS IN THE FIELD BEFORE PROCEDING WITH ANY PORTION OF THE WORK. ADVISE IN WRITING TO CONSTRUCTION MANAGER AND ARCHITECT OF DISCREPANCY BETWEEN EXISTING CONDITIONS AND DRAWINGS.
- REPORT TO CONSTRUCTION MANAGER AND ARCHITECT DISCREPANCIES IN THE CONTRACT DRAWINGS, SPECIFICATIONS OR DETAILS PRIOR TO COMMENCING THE WORK.
- COORDINATE CIVIL, MECHANICAL, ELECTRICAL, ARCHITECTURAL AND STRUCTURAL REQUIREMENTS FOR PROPER LOCATION AND PROVISIONS OF SLEEVES, INSERTS, OPENINGS AND ROUGH-IN REQUIRED
- CONDUCT DEMOLITION/CONSTRUCTION OPERATION TO INSURE MINIMUM INTERFERENCE WITH ROADS, STREETS, SIDEWALKS AND OTHER ADJACENT FACILITIES THE USE OF A BRAND NAME AND/OR MODEL NUMBER TO DENOTE
- ESTABLISH A STANDARD OF QUALITY AND SHALL NOT BE CONSTRUED AS LIMITING COMPETITION. DO NOT COMMENCE ANY DEMOLITION OF SITE ELEMENTS OR STRUCTURE UNTIL THE HAZARDOUS MATERIAL ABATEMENT IS DONE AND EPA CERTIFICATION IS OBTAINED, STATING THAT THE SITE ELEMENTS AND STRUCTURES ARE FREE OF HAZARDOUS MATERIALS. PRIOR TO

COMMENCEMENT OF THE HAZARDOUS MATERIAL ABATEMENT THE

PRODUCTS, EQUIPMENTS, MATERIALS, OR PROCESS, IS INTENDED TO

BUILDING AND SITE SHALL BE VACANT. SPECIFIED TREE PRUNING OR CUTTING OR INCIDENTAL TO OTHER REPAIR WORK MAY REQUIRE A DRNA PERMIT. THE CONTRACTOR IS RESPONSIBLE FOR OBTAINING PERMIT BEFORE PERFORMING THE WORK.

ARCHITECTURAL NOTES

- PRESSURE WASH, MINIMUM 3,000 PSI, EXISTING BUILDING EXTERIOR WALLS, WINDOWS, AND DOORS BEFORE BEGINNING SPECIFIED WORK. REPAIR INTERIOR AND EXTERIOR WALL SURFACES WITH CEMENT PLASTER PRIOR TO APPLYING PAINT FINISH. REPAIR WORK INCLUDES, BUT IS NOT LIMITED TO CUT AND PATCHING, REMOVAL OF NAILS AND SCREWS FROM WALLS, REPAIR OF MAJOR IMPERFECTIONS ON WALLS AND FINISHES IN GENERAL
- FULL TEAR-OFF OF ROOF WATERPROOFING SYSTEM INCLUDING MEMBRANE, INSULATION AND FLASHINGS WHERE SYSTEM REPLACEMENT IS SPECIFIED. A ROOF MOISTURE SURVEY MAY BE REQUIRED PRIOR TO INSTALLATION OF NEW MEMBRANE
- CLEAN, REPAIR AND VERIFY STRUCTURAL INTEGRITY OF ROOF DECK PRIOR THE INSTALLATION OF THE WATERPROOFING SYSTEM. COMPLY WITH THE MANUFACTURER RECOMMENDATIONS FOR THE INSTALLATION OF ROOF MEMBRANE TO VALIDATE THE WARRANTY.

ELECTRICAL GENERAL NOTES

- NO WIRE SHALL BE SMALLER THAN # 12 AWG THHN, 600 VOLTS NO CONDUIT SHALL BE SMALLER THAN 3/4".
- ALL CONDUIT SHALL BE RIGID GALVANIZED EXCEPT OTHERWISE
- ALL WIRE SHALL BE COPPER, INSULATED AS NOTED. LEAVE A #12 AWG GALVANIZED FISH WIRE IN ALL EMPTY CONDUITS.
- ALL UNDERGROUND CONDUITS SHALL BE PROTECTED WITH 4" CONCRETE ENVELOPE.
- EXPANSION FITTINGS SHALL BE USED FOR EVERY CONDUIT CROSSING BUILDING EXPANSION JOINTS.
- CONTRACTOR SHALL BALANCE ALL LOADS PROVIDE A #12 GREEN THW BONDING JUMPER BETWEEN EACH OUTLET BOX AND RECEPTACLE GROUNDING TERMINAL, USE 3/8" LONG 10-32
- GROUNDING SCREW. ALL INSTALLATIONS SHALL BE EXPOSED UNLESS OTHERWISE INDICATED. EXPOSED CONDUITS SHALL BE SUPPORTED BY MEANS OF ONE BOLT CLAMP SPACED NOT FURTHER THAN 7'-6" APART.
- AN EXPOSED WORK CONDULET SHALL BE USED FOR ALL 90 BENDS. ALL NON-GALVANIZED METAL PARTS SHALL BE GIVEN ONE COAT OF RED
- OXIDE AND TWO COATS OF METALLIC GRAY PRIOR TO INSTALLATION. ALL GALVANIZED RIGID CONDUITS FOR TOGGLE SWITCHES AND RECEPTACLES LOCATED AT DOORWAYS AND LEAN - TO SHALL BE
- CONCEALED WITHIN ROOF SLAB, WALLS AND OVERHANGS. CONTRACTOR SHALL PROVIDE ELECTRICAL SERVICE TO TEST ALL ELECTRICAL SYSTEM IN PRESENCE OF THE REPRESENTATIVE FROM THE
- MECHANICAL AND ELECTRICAL DEPARTMENT ALL LIGHTING CIRCUITS SHALL HAVE ONE (1) PORCELAIN LIGHT SOCKET
- WITH A LED TYPE BULB, EQUIVALENT TO 100W INCANDESCENT LUMENS. SWITCHES AND RECEPTACLES SHALL BE INSTALLED 4'-0" A.F.F. THE NEUTRAL WIRES SHALL BE IDENTIFIED THROUGHT THE INSTALLATION
- BY THE USE OF WHITE COLOR COVERED LIVE WIRES WITHIN THE SAME CONDUIT SHALL BE COLOR CODED AS PER N.E.C. RECEPTACLES AND LIGHTING CIRCUITS SHALL BE #12 THHN WIRE AND
- SHALL BE CONNECTED TO 20 AMP BREAKERS AT THE PANELBOARD. ALL OVERHANGS AND LEAN - TO'S SHALL BE PROVIDED WITH LIGHT SOCKETS.
- CONTRACTOR SHALL VERIFY LENGTH OF FEEDERS IN THE FIELD BEFORE SUBMITTING BIDS
- ALL SWITCHES AND RECEPTACLES THAT ARE CONCEALED IN WALLS AND OVERHANGS SHALL BE PROVIDED WITH STAINLESS STEEL COVERS. CONTRACTOR SHALL CONTACT THE DISTRICT ENGINEER OF LUMA PRIOR TO THE BEGINNING OF THE WORK AND COORDINATE WITH THEM FOR THE EXECUTION OF THE WORK CONCERNING THE SERVICE ENTRANCE AND SUBSTATION IF REQUIRED. IN ADDITION, THE CONTRACTOR SHALL OBTAIN A CERTIFICATE OF INSPECTION AT THE COMPLETION OF THE WORK AND SHALL FORWARD IT TO THE PUERTO RICO INDUSTRIAL DEVELOPMENT
- COMPANY ALL INSTALLATIONS SHALL BE IN ACCORDANCE WITH THE LATEST RULES AND REGULATIONS OF THE N.E.C. AND LUMA.
- ALL BOXES FOR RECEPTACLES & LIGHTING SWITCHES FOR EXPOSED INSTALLATION SHALL BE "FS" TYPE.
- CONTRACTOR SHALL SUBMIT A LIST OF MATERIALS AND EQUIPMENT GIVING MANUFACTURER CATALOG NUMBERS AND COMPLETE SPECIFICATIONS AND DRAWINGS FOR APPROVAL OF P.R.I.D.C.O. PRIOR TO THE PURCHASING OF SAID MATERIALS AND/OR EQUIPMENT.

- PLUMBING SHALL BE IN STRICT ACCORDANCE WITH THE 2018 PUERTO RICO BUILDING CODE.
- FURNISH AND SET IN PLACE BEFORE CONCRETE POURING ALL NECESSARY SLEEVES FOR WASTE OR SOIL, VENT, HOT, AND COLD WATER LINES, THESE SLEEVES SHALL BE AS SPECIFIED OR REQUIRED BY THE
- THE PLUMBING DRAWING IS GENERALLY DIAGRAMATTIC AND INDICATIVE OF THE WORK TO BE INSTALLED. RUN ALL PIPING CONCEALED WHEREVER POSSIBLE UNLESS OTHERWISE NOTED.
- SIZES SHOWN IN FIXTURE SCHEDULE ARE MINIMUM AND SHALL BE INCREASED AS NECESSARY TO COMPLY WITH CODE REQUIREMENTS OR AS SHOWN ON DRAWINGS.
- BEFORE CONSTRUCTION VERIFY EXISTING ELEVATIONS AGAINST PROPOSED SLOPES. ANY DISCREPANCIES SHALL BE BROUGHT TO THE ATTENTION OF THE ARCHITECT.
- CLEANOUT SHALL BE OF SAME SIZE AS THE PIPES TO WHICH THEY ARE CONNECTED UP TO 4", FOR LARGE
- UNLESS OTHERWISE INDICATED, ALL DRAINAGE PIPING 3" AND SMALLER SHALL BE SLOPED 1/4" PER FT., LARGER
- CLEANOUT SHALL BE NOT MORE THAN 50 FEET AP-ART IN HORIZONTAL DRAINAGE LINES OF 4" NOMINAL DIAMETER OR LESS AND NOT MORE THAN 100 FEET APART FOR LARGER PIPES.
- FOR FIXTURES AND EQUIPMENT NOT LISTED IN SCHEDULE, SEE CONTRACT SPECIFICATIONS.
- DETERMINE EXACT LOCATION OF THE PIPING TO AVOID ANY INTERFERENCE WITH PIPING AND/OR EQUIPMENT BEING INSTALLED BY ANOTHER SUB-CONTRACTOR.
- SANITARY TEES (SINGLE AND DOUBLE) AND QUARTER BENDS SHALL BE ACCEPTABLE ONLY FOR CHANGES OF DIRECTION FROM HORIZONTAL TO VERTICAL
- USE LONG SWEEPING FITTINGS AND/OR LONG SWEEP BENDS AT BASE OF ALL STACKS.

SERVICES. FLOOR SLEEVES ARE TO PROJECT 2" ABOVE FINISHED FLOORS.

- PROVIDE ROUGHING-IN AND INSTALL ALL PLUMBING FIXTURES AND/OR EQUIPMENT WHICH ARE SUPPLIED BY
- FOR ALL UNDERGROUND SANITARY AND STORM DRAINAGE USE: PVC POLYVINYL CHLORIDE) SEWER PIPE AND FITTING: ASTM D 3034, SDR-35, FOR SOLVENT CEMENT OR ELASTOMERIC GASKET JOINTS. A. SOLVENT CEMENT: ASTM D 2564 B. GASKETS: ASTM F 477, ELASTOMERIC SEAL.
- PROVIDE ALL PIPE OPENINGS THROUGH SLABS WITH SLEEVES HAVING AN INTERNAL DIAMETER AT LEAST 1" LARGER THAN THE OUTSIDE DIAMETER OF UN-INSULATED PIPES OR OF THE INSULATION FOR INSULATION
- SLEEVES SHALL BE SCHEDULES 40 GALVANIZED STEEL PIPE.
- BOTTOM OF THE WATER SERVICES LINE SHALL BE 12 INCHES ABOVE THE HIGHEST POINT OF THE SEWER LINE WHENEVER THE HORIZONTAL DISTANCE BETWEEN THEM IS LESS THAN 5 FT.
- PROVIDE DOWNSPOUT NOZZLES (SIMILAR TO JAY R. SMITH FIG 1770) AT THE OVERFLOW RAIN WATER OUTLETS,
- CONTRACTOR SHALL SUPPLY AND INSTALL 1/4 TURN SHUT OFF VALVES AT EVERY PLUMBING FIXTURE.
- ALL PLUMBING FIXTURES, COLORS AND FINISHES, SELECTION BY ARCHITECT.

HVAC GENERAL NOTES:

- SUPPLY AND INSTALL ALL ELECTRICAL CONTROLS, SAFETY SWITCHES AND ACCESSORIES NOT INDICATED IN THE ELECTRICAL DRAWING AND NECESSARY FOR THE PROPER OPERATION OF THE EQUIPMENT IN ACCORDANCE WITH THE MECHANICAL EQUIPMENT RECOMMENDATIONS AND THE NATIONAL ELECTRIC CODE.
- PERFORM ALL WIRING AND CONNECTION (POWER AND CONTROL) NOT INDICATED IN THE ELECTRICAL DRAWINGS AND NECESSARY FOR THE PROPER OPERATION OF THE MECHANICAL EQUIPMENT IN STRICT ACCORDANCE WITH THE NATIONAL ELECTRIC CODE
- TAKE EVERY PRECAUTION IN ORDER TO MINIMIZE OR ELIMINATE THE TRANSMISSION OF NOISE OR VIBRATION FROM THE EQUIPMENT, PIPING SYSTEM OR DUCT SYSTEM TO THE CONDITIONING SPACE.
- EQUIPMENT, MATERIALS AND ACCESSORIES SHALL BE SIMILAR TO THE INDICATED SPECIFICATION AND/OR MANUFACTURER MODEL OR CATALOG NUMBER.
- UNLESS OTHERWISE NOTED IN DRAWINGS AND/OR SPECIFICATIONS ALL EQUIPMENT AND ACCESSORIES SHALL BE FURNISHED AND INSTALLED BY THE CONTRACTOR.

CIVIL SITE GENERAL NOTES

- ALL DISTANCES AND ELEVATIONS ARE EXPRESSED IN METERS UNLESS OTHERWISE SPECIFIED. ELEVATIONS ARE REFERRED TO MEAN SEA LEVEL.
- COORDINATES ARE BASED ON THE LAMBERT PROJECTION FOR PUERTO RICO AND THE US VIRGIN ISLAND AND REFERENCED TO THE NORTH AMERICAN DATUM OF 1983 (NAD83 NA2011) EPOCH 2010.00 ADJUSTED IN
- THE CONTRACTOR SHALL COORDINATE WITH THE CONSTRUCTION MANAGER BEFORE CUTTING OR TRIMMING EXISTING TREES AFFECTED BY THE CONSTRUCTION.
- THE CONTRACTOR SHALL PREPARE AND SUBMIT FOR EACH PROJECT AREA. THE CONTROL OF EROSION AND SEDIMENTATION (CES) PLAN FOR APPROVAL BY THE PERTINENT AGENCY AND THE CONSTRUCTION MANAGER. THE CONTRACTOR SHALL PROVIDE AND MAINTAIN A DEWATERING SYSTEM TO KEEP SUBGRADES DRY AND CONVEY GROUND WATER AWAY FROM EXCAVATIONS. THE DEWATERING PLAN SHALL BE SUBMITTED TO THE CONSTRUCTION MANAGER FOR APPROVAL AND COORDINATION.
- DEWATERING PLANS SHALL INCLUDE CONTROL OF EROSION AND SEDIMENTATION FOR EACH PROJECT PHASE AND/OR WORK AREA. THE WATER FROM THE DEWATERING SYSTEM SHALL BE FREE OF SEDIMENT AND/OR DEBRIS BEFORE ANY DISPOSAL
- THE CONTRACTOR SHALL MAINTAIN THE DEWATERING SYSTEM UNTIL DEWATERING IS NO LONGER ELECTRICAL, COMMUNICATION, SANITARY AND POTABLE WATER SERVICE SHALL NOT BE INTERRUPTED
- DURING CONSTRUCTION. IF NECESSARY, A PROVISIONAL TEMPORARY SERVICE AND/OR BY-PASS SHALL BE INSTALLED TO MAINTAIN SERVICE. PROVISIONAL TEMPORARY SERVICE AND/OR BY-PASS SHALL BE SUBMITTED TO THE CONSTRUCTION MANAGER FOR APPROVAL AND COORDINATION PRIOR TO CONSTRUCTION. THE CONTRACTOR SHALL PREPARE AND SUBMIT THE MAINTENANCE OF SERVICE PLAN FOR ELECTRICAL,
- SANITARY AND POTABLE WATER FOR APPROVAL OF THE CONSTRUCTION MANAGER. THE CONTRACTOR SHALL NOTIFY THE CONSTRUCTION MANAGER IF ANY ELEMENT SUSPECTED OF CONTAINING HAZARDOUS MATERIAL IS ENCOUNTERED, PRIOR TO ANY RELATED WORK ACTIVITY. THE CONTRACTOR SHALL VISIT THE PROJECT AREA TO VERIFY THE SPACE LIMITATIONS FOR CONSTRUCTION
- PROCESS AND EQUIPMENT. THE CONTRACT PRICE SHALL CONSIDER THE REQUIRED CONSTRUCTION PROCESS AND/OR EQUIPMENTS. PRIOR TO COMMENCEMENT OF THE WORK, CONTRACTOR SHALL VERIFY ALL DIMENSIONS AND EXISTING CONDITIONS AT PROJECT SITE AND SHALL NOTIFY THE CONSTRUCTION MANAGER OF ANY DISCREPANCIES
- BETWEEN EXISTING CONDITIONS AND CONTRACT DOCUMENTS THAT COULD AFFECT CONSTRUCTION WORK SCHEDULE AND /OR PERFORMANCE. ALL DETAILS, SECTIONS AND NOTES SHOWN ON DRAWINGS ARE INTENDED TO BE TYPICAL AND SHALL APPLY TO
- SIMILAR SITUATIONS ELSEWHERE UNLESS OTHERWISE NOTED. THE CONTRACTOR SHALL REPAIR OR REPLACE EXISTING FACILITIES DAMAGED DURING CONSTRUCTION PRIOR TO SUBSTANTIAL COMPLETION
- THE CONTRACTOR SHALL MAINTAIN IN OPERATION EXISTING FACILITIES UNTIL NEW FACILITIES ARE IN OPERATION.

STRUCTURAL BUILDING AND DESIGN CODES:

- PUERTO RICO BUILDING CODE 2018 AND ITS BINDING REFERENCED STANDARDS, INCLUDING BUT NOT LIMITED TO:
 - THE INTERNATIONAL BUILDING CODE 2018 AMERICAN INSTITUTE FOR STEEL CONSTRUCTION (AISC), STEEL CONSTRUCTION MANUAL, 15 TH EDITION AMERICAN CONCRETE INSTITUTE (ACI), BUILDING CODE REQUIREMENTS FOR STRUCTURAL CONCRETE, ACI 318-14
- AMERICAN SOCIETY OF CIVIL ENGINEERS, MINIMUM DESIGN LOADS AND ASSOCIATED CRITERIA FOR BUILDINGS AND OTHER STRUCTURES, ASCE/SEI 7-16

STRUCTURAL NOTES ON CONCRETE REPAIR:

- ALL CONCRETE REPAIR WORKS SHALL BE PERFORMED FOLLOWING THE GUIDELINES OF THE INTERNATIONAL CONCRETE REPAIR INSTITUTE (ICRI). HIRING A PROFESSIONAL EXPERIENCED IN THIS TYPE OF REPAIR IS RECOMMENDED TO ENSURE A PROPER
- FOR THE REPAIR OF AREAS AFFECTED BY CORROSION, ICRI NO. 03730 GUIDELINE FOR SURFACE PREPARATION FOR THE REPAIR OF DETERIORATED CONCRETE RESULTING FROM REINFORCING STEEL CORROSION SHOULD BE FOLLOWED. BEFORE COMMENCING ANY CONCRETE REPAIR WORK, THE CONTRACTOR SHALL REVIEW THE REPAIR DETAILS PRESENTED IN THE DRAWINGS. IN CASE OF DOUBT WITH THE REPAIR DETAILS PRESENTED, THE CONTRACTOR SHOULD CONTACT THE
- ARCHITECT OR ENGINEER OF RECORD TO CLARIFY THEM. IT IS IMPORTANT TO FOLLOW THE MANUFACTURER'S RECOMMENDATIONS FOR EACH PRODUCT UTILIZED FOR THIS JOB, IN ORDER TO GUARANTEE THAT THE REPAIR WORKS ARE CARRIED OUT ADEQUATELY.

STRUCTURAL NOTES ON CAST-IN-PLACE CONCRETE:

PORTLAND CEMENT SHALL BE TYPE II. ALL CONCRETE SHALL BE OF REGULAR WEIGHT (145 POUNDS PER CUBIC FOOT).

THE FOLLOWING CONCRETE MIX PARAMETERS SHALL BE USED UNLESS OTHERWISE NOTED:

- CONCRETE STRENGTH AT 28 DAYS 3,000 PSI MAX. WATER/CEMENT RATIO - 0.65 RECOMMENDED SLUMP – 3 INCHES
- MAX. AGGREGATE SIZE (ASTM C33) 1 INCH PROVIDE CONCRETE MIXES DESIGNED BY A QUALIFIED TESTING LABORATORY FOR REVIEW AND APPROVAL BY THE STRUCTURAL ENGINEER. CONCRETE MIX DESING SHALL BE SIGNED AND SEALED BY A PROFESSIONAL ENGINEER AUTHORIZED TO

NOTE ON REINFORCING STEEL BARS:

- ALL REINFORCING STEEL SHALL BE NEW STOCK DEFORMED BARS CONFORMING TO ASTM A615, GRADE 60 (FY = 60 KSI). MAINTAIN THE FOLLOWING CONCRETE COVERAGE FOR REINFORCING STEEL UNLESS NOTED OTHERWISE:
- CONCRETE CAST AGAINST EARTH: 3 INCHES
- CONCRETE IN CONTACT WITH THE GROUND: 2 INCHES
- CONCRETE SLAB AND WALLS WITHOUT CONTACT WITH GROUND: 1 INCHES
- CONCRETE BEAMS AND COLUMNS: 1 1/2 INCHES

EXERCISE THE PROFESSION IN THE COMMOM WEALTH OF PUERTO RICO.

STRUCTURAL STEEL

- DESIGN, DETAIL AND ERECT STRUCTURAL STEEL ELEMENTS IN ACCORDANCE WITH THE FOLLOWING:
- AISC SPECIFICATION FOR THE DESIGN, FABRICATION, AND ERECTION OF STRUCTURAL STEEL FOR BUILDINGS.
- AISC MANUAL OF STEEL CONSTRUCTION, ALLOWABLE STRESS DESIGN. AISC CODE OF STANDARD PRACTICE FOR STEEL BUILDINGS AND BRIDGES.
- AWS STRUCTURAL WELDING CODE, D1.1.
- STRUCTURAL STEEL SHALL CONFORM TO THE FOLLOWING GRADES: W SHAPES: ASTM A992 (FY = 50 KSI, FU = 65 KSI)
- STEEL ANGLE, CHANNELS, PLATES: ASTM A36
- BOLTS, NUTS AND WASHERS: HIGH-STRENGTH BOLTS, INCLUDING NUTS AND WASHERS: ASTM A325 STEEL PLATES FOR LANDINGS AND THREADS: 1/4" ANTI-SLIP DIAMOND TYPE STEEL PLATE A36
- WELDING ELECTRODE FOR STEEL SHALL BE E70XX.

- PROVIDE DESIGN, FABRICATION, AND ERECTION OF METAL DECK CONFORMING TO THE STEEL DECK INSTITUTE'S "CODE OF RECOMMENDED STANDARD PRACTICE AND BASIC DESIGN SPECIFICATIONS"
- FORM ROOF DECK FROM STEEL SHEETS CONFORMING TO ASTM A 611 GRADE C AND D OR A 653 OR HIGHER SPECIFICATIONS WITH A MINIMUM YIELD STRENGTH OF 33 KSI. ATTACH SHEETS TO STEEL SUPPORT MEMBERS AS INDICATED AND IN ACCORDANCE WITH THE MANUFACTURER'S INSTRUCTIONS FOR INSTALLATION. WHEN DECK IS SCHEDULED TO BEEXPOSED, DE-SLAG, CLEAN AND TOUCH UP WELDS WITH A ZINC-RICH
- LAP ROOF AND FLOOR DECK ENDS MINIMUM OF 2 INCHES. WHEN FASTENING DECK TO SUPPORT MEMBERS PROVIDE WELDING MATERIALS INSTALLATION PROCEDURES TO PREVENT BURNING OF HOLES IN DECK.
- AT ENDS OF DECKS OR WHERE CHANGES OF DECK DIRECTION OCCUR, FASTEN TO SUPPORTS AT EACH FLUTE. PROVIDE ADEQUATE CLOSURES AND FASTENERS TO SIDES AT EIGHTEEN INCHES ON CENTER. WHERE PARTIAL PANELS MAY BE REQUIRED TO COMPLETE DECK INSTALLATION AT PERIMETER OF STRUCTURE, PROVIDE WELDS IN EACH FLUTE TO STRUCTURAL MEMBERS. INSTALL DECK IN THREE CONTINUOUS SPAN LENGTHS. AT PERIMETER OF DECK, SECURE DECK TO STRUCTURAL MEMBERS WITH SAME ATTACHMENTAND SPACING SUPPORT
- ATTACHMENT AS INDICATED ON PLANS. HOT DIP GALVANIZE (G90) AFTER FABRICATION ALL METAL DECK AND TOUCH UP CONNECTIONS WITH A ZINC-RICH PRIMER.

NOTES (IF APPLICABLE):

TREE REMOVAL:

- REMOVE ALL TREES INDICATED BY THE DRAWINGS AND SPECIFICATIONS, AS REQUIRING REMOVAL, IN A MANNER THAT WILL NOT DAMAGE ADJACENT TREES OR STRUCTURES OR COMPACTS THE SOIL.
- REMOVE TREES THAT ARE ADJACENT TO TREES OR STRUCTURES TO REMAIN, IN SECTIONS, TO LIMIT THE OPPORTUNITY OF DAMAGE TO ADJACENT CROWNS, TRUNKS, GROUND PLANE ELEMENTS AND STRUCTURES. DO NOT DROP TREES WITH A SINGLE CUT UNLESS THE TREE WILL FALL IN AN AREA NOT INCLUDED IN THE TREE AND PLANT
- PROTECTION AREA. NO TREE TO BE REMOVED WITHIN 50 FEET OF THE TREE AND PLANT PROTECTION AREA SHALL BE PUSHED OVER OR UP-ROOTED USING A PIECE OF GRADING EQUIPMENT. PROTECT ADJACENT PAVING, SOIL, TREES, SHRUBS, GROUND COVER PLANTINGS AND UNDERSTORY PLANTS TO REMAIN FROM
- DAMAGE DURING ALL TREE REMOVAL OPERATIONS, AND FROM CONSTRUCTION OPERATIONS. PROTECTION SHALL INCLUDE THE ROOT SYSTEM, TRUNK, LIMBS, AND CROWN FROM BREAKAGE OR SCARRING, AND THE SOIL FROM COMPACTION. REMOVE STUMPS AND IMMEDIATE ROOT PLATE FROM EXISTING TREES TO BE REMOVED. GRIND TRUNK BASES AND LARGE BUTTRESS ROOTS TO A DEPTH OF THE LARGEST BUTTRESS ROOT OR AT LEAST 18 INCHES BELOW THE TOP MOST ROOTS WHICH EVER IS LESS AND OVER THE AREA OF THREE TIMES THE DIAMETER OF THE TRUNK (DBH). FOR TREES WHERE THE STUMP WILL FALL UNDER NEW PAVED AREAS, GRIND ROOTS TO A TOTAL DEPTH OF 18 INCHES BELOW THE EXISTING GRADE. IF THE SIDES OF THE STUMP HOLE STILL HAVE GREATER THAN APPROXIMATELY 20% WOOD VISIBLE, CONTINUE GRINDING OPERATION DEEPER AND OR WIDER UNTIL THE RESULTING HOLE HAS LESS THAN 20% WOOD. REMOVE ALL

WOOD CHIPS PRODUCED BY THE GRINDING OPERATION AND BACK FILL IN 8 INCH LAYERS WITH CONTROLLED FILL OF A QUALITY

ACCEPTABLE TO THE SITE ENGINEER FOR FILL MATERIAL UNDER STRUCTURES, COMPACTED TO 95% OF THE MAXIMUM DRY

DENSITY STANDARD PROCTOR. THE OWNER'S REPRESENTATIVE SHALL APPROVE EACH HOLE AT THE END OF THE GRINDING


OPERATION IN AREAS WHERE THE TREE LOCATION IS TO BE A PLANTING BED OR LAWN, REMOVE ALL WOODCHIPS AND BACKFILL STUMP HOLES WITH PLANTING SOIL AS DEFINED IN SPECIFICATION SECTION PLANTING SOIL, IN MAXIMUM OF 12 INCH LAYERS AND COMPACT TO 80 - 85% OF THE MAXIMUM DRY DENSITY STANDARD PROCTOR.

- WITHIN SIX MONTHS OF THE ESTIMATED DATE OF SUBSTANTIAL COMPLETION, PRUNE ALL DEAD OR HAZARDOUS BRANCHES LARGER THAN 2 INCH IN DIAMETER FROM ALL TREES TO REMAIN.
- IMPLEMENT ALL PRUNING RECOMMENDATIONS FOUND IN THE ARBORIST REPORT PRUNE ANY LOW, HANGING BRANCHES AND VINES FROM EXISTING TREES AND SHRUBS THAT OVERHANG WALKS, STREETS AND DRIVES, OR PARKING AREAS AS FOLLOWS:
 - 1. WALKS WITHIN 8 FEET VERTICALLY OF THE PROPOSED WALK ELEVATION.
 - 2. PARKING AREAS WITHIN 12 FEET VERTICALLY OF THE PROPOSED PARKING SURFACE ELEVATION.
 - 3. STREETS AND DRIVES WITHIN 14 FEET VERTICALLY OF THE PROPOSED DRIVING SURFACE ELEVATION.
- ALL PRUNING SHALL BE DONE IN ACCORDANCE WITH ANSI A300 (PART 1), ISA BMP TREE PRUNING (LATEST EDITION, AND THE "STRUCTURAL PRUNING: A GUIDE FOR THE GREEN INDUSTRY", EDWARD GILMAN, BRIAN KEMPF, NELDA MATHENY AND JIM CLARK, 2013 URBAN TREE FOUNDATION, VISALIA CA.
- PERFORM OTHER PRUNING TASK AS INDICATED ON THE DRAWINGS OR REQUESTED BY THE OWNER'S REPRESENTATIVE. WHERE TREE SPECIFIC DISEASE VECTORS REQUIRE, STERILIZE ALL PRUNING TOOLS BETWEEN THE WORK IN INDIVIDUAL TREES.

GENERAL DRAWING SYMBOLS:

EXISTING WALL NEW CONCRETE BLOCK WALL 6" OR 8" NEW PLYCEM BOARD WALL

BEHIND AS INDICATED.

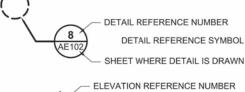

SHEET WHERE ELEVATION IS DRAWN SECTION REFERENCE NUMBER GENERAL BUILDING SECTION

SHEET WHERE SECTION IS DRAW!

- WALL SECTION REFERENCE NUMBER



INTERIOR ELVATION SYMBOL **ELEVATION REFERENCE NUMBER**

NORTH ARROW

WALL SECTION

WINDOW SYMBOL KEY NOTE





HANDICAPPED SYMBOL

EQUIPMENT SYMBOL

ABBREVIATIONS:

T.O.S.

AIR CONDITIONING ALUMINUM CENTER TO CENTER CONCRETE MASONRY UNIT CORRIDOR CORROSION ELEVATION FLOOR DRAIN FINISH FLOOR ELEVATIONS FINISH FLOOR LEVEL HARDWARE HEIGHT

> JANITOR CLOSE MASONRY **MECHANICAL** MINIMUM NOT IN CONTRAC NOT APPLICABLE **ROOF DRAIN** REQUIRED SMOOTH CEMENT PLASTE

> > UNLESS OTHERWISE NOTE

DROP MANHOLE

VERIFY IN FIELD

STAINLESS STEEL STORM SEWER TOP OF MASONRY TOP OF STEEL **TELEPHONE**

THIS DOCUMENT REPRESENTS THE IDEAS AND EFFORTS OF CSA ARCHITECTS AND ENGINEERS.

IT SHALL BE USED ONLY BY AUTHORIZED PERSONS

AND SHALL NOT BE REPRODUCED OR EXHIBITED

WITHOUT WRITTEN CONSENT OF

CSA ARCHITECTS AND ENGINEERS.



ISSUE FOR BID

PRIDCO

FEBRUARY 21, 2024

	REV	DATE	DESCRIPTION				
С							
C	DISCIPLINE INFORMATION:						
	PRIME PROFESIONAL:						
	ANNETTE ALFONSO						
	PROFESS	IONAL OF RECOR	RD:				
	ANNET	TE ALFONS	0				
	STAFF DESIGNER:						
	JOHAN	INA SALCED	00				
	Q.C. AUDI	ΓOR:					

PROFESSIONAL'S STATEMENT:

YO, ANNETTE ALFONSO CERTIFICO QUE SOY EL PROFESIONAL QUE ICONFECCIONÓ, DISEÑÓ O PREPARÓI ESTOS PLANOS

TAMBIÉN, CERTIFICO QUE ENTIENDO QUE DICHOS PLANOS Y ESPECIFICACIONES CUMPLEN CON LAS DISPOSICIONES APLICABLES DEL REGLAMENTO CONJUNTO Y LAS DISPOSICIONES APLICABLES DE LOS REGLAMENTOS Y CÓDIGOS DE CONSTRUCCIÓN VIGENTES DE LAS AGENCIAS. JUNTAS REGLAMENTADORAS O CORPORACIONES PÚBLICAS CON JURISDICCIÓN. CERTIFICO, ADEMÁS, QUE EN LAPREPARACIÓN DE ESTOS PLANOS Y ESPECIFICACIONES SE HA CUMPLIDO CABALMENTE CON LO DISPUESTO EN LA LEY NÚM. 14 DE 8 DE ENERO DE 2004, SEGÚN ENMENDADA, CONOCIDA COMO LA "LEY PARA LA INVERSIÓN POR LA INDUSTRIA PUERTORRIQUEÑA" Y CON LA [LEY NÚM. 319 DE 15 DE MAYO DE 1938, SEGÚN ENMENDADA; LEY NÚM. 96 DE 6 DE JULIO DE 1978, SEGÚN ENMENDADA: SEGÚN APLIQUEI, RECONOZCO QUE CUALQUIER DECLARACIÓN FALSA O FALSIFICACIÓN DE LOS HECHOS QUE SE HAYA PRODUCIDO POR DESCONOCIMIENTO O POR NEGLIGENCIA YA SEA POR MÍ, MIS AGENTES O EMPLEADOS, O POR OTRAS

PRIDCO DAMAGE IMPROVEMENTS **NORTH REGION STAGE 1 BID PACKAGE N1-3**

PW: 7801 / QUEBRADILLAS

PERSONAS CON MI CONOCIMIENTO. ME HACEN

DISCIPLINARIA POR LA OGPE.

RESPONSABLE DE CUALQUIER ACCIÓN JUDICIAL Y

SHEET TITLE:

GENERAL NOTES, ABBREVIATIONS AND LEGEND

AS SHOWN


PROJECT NUMBER:

21-0258-02

BIM FILE NAME:

DELIVERY DATE PRINT DATE & TIME: 4/22/2024 3:28:28 PM

DRAWING / MODEL LOCATION:

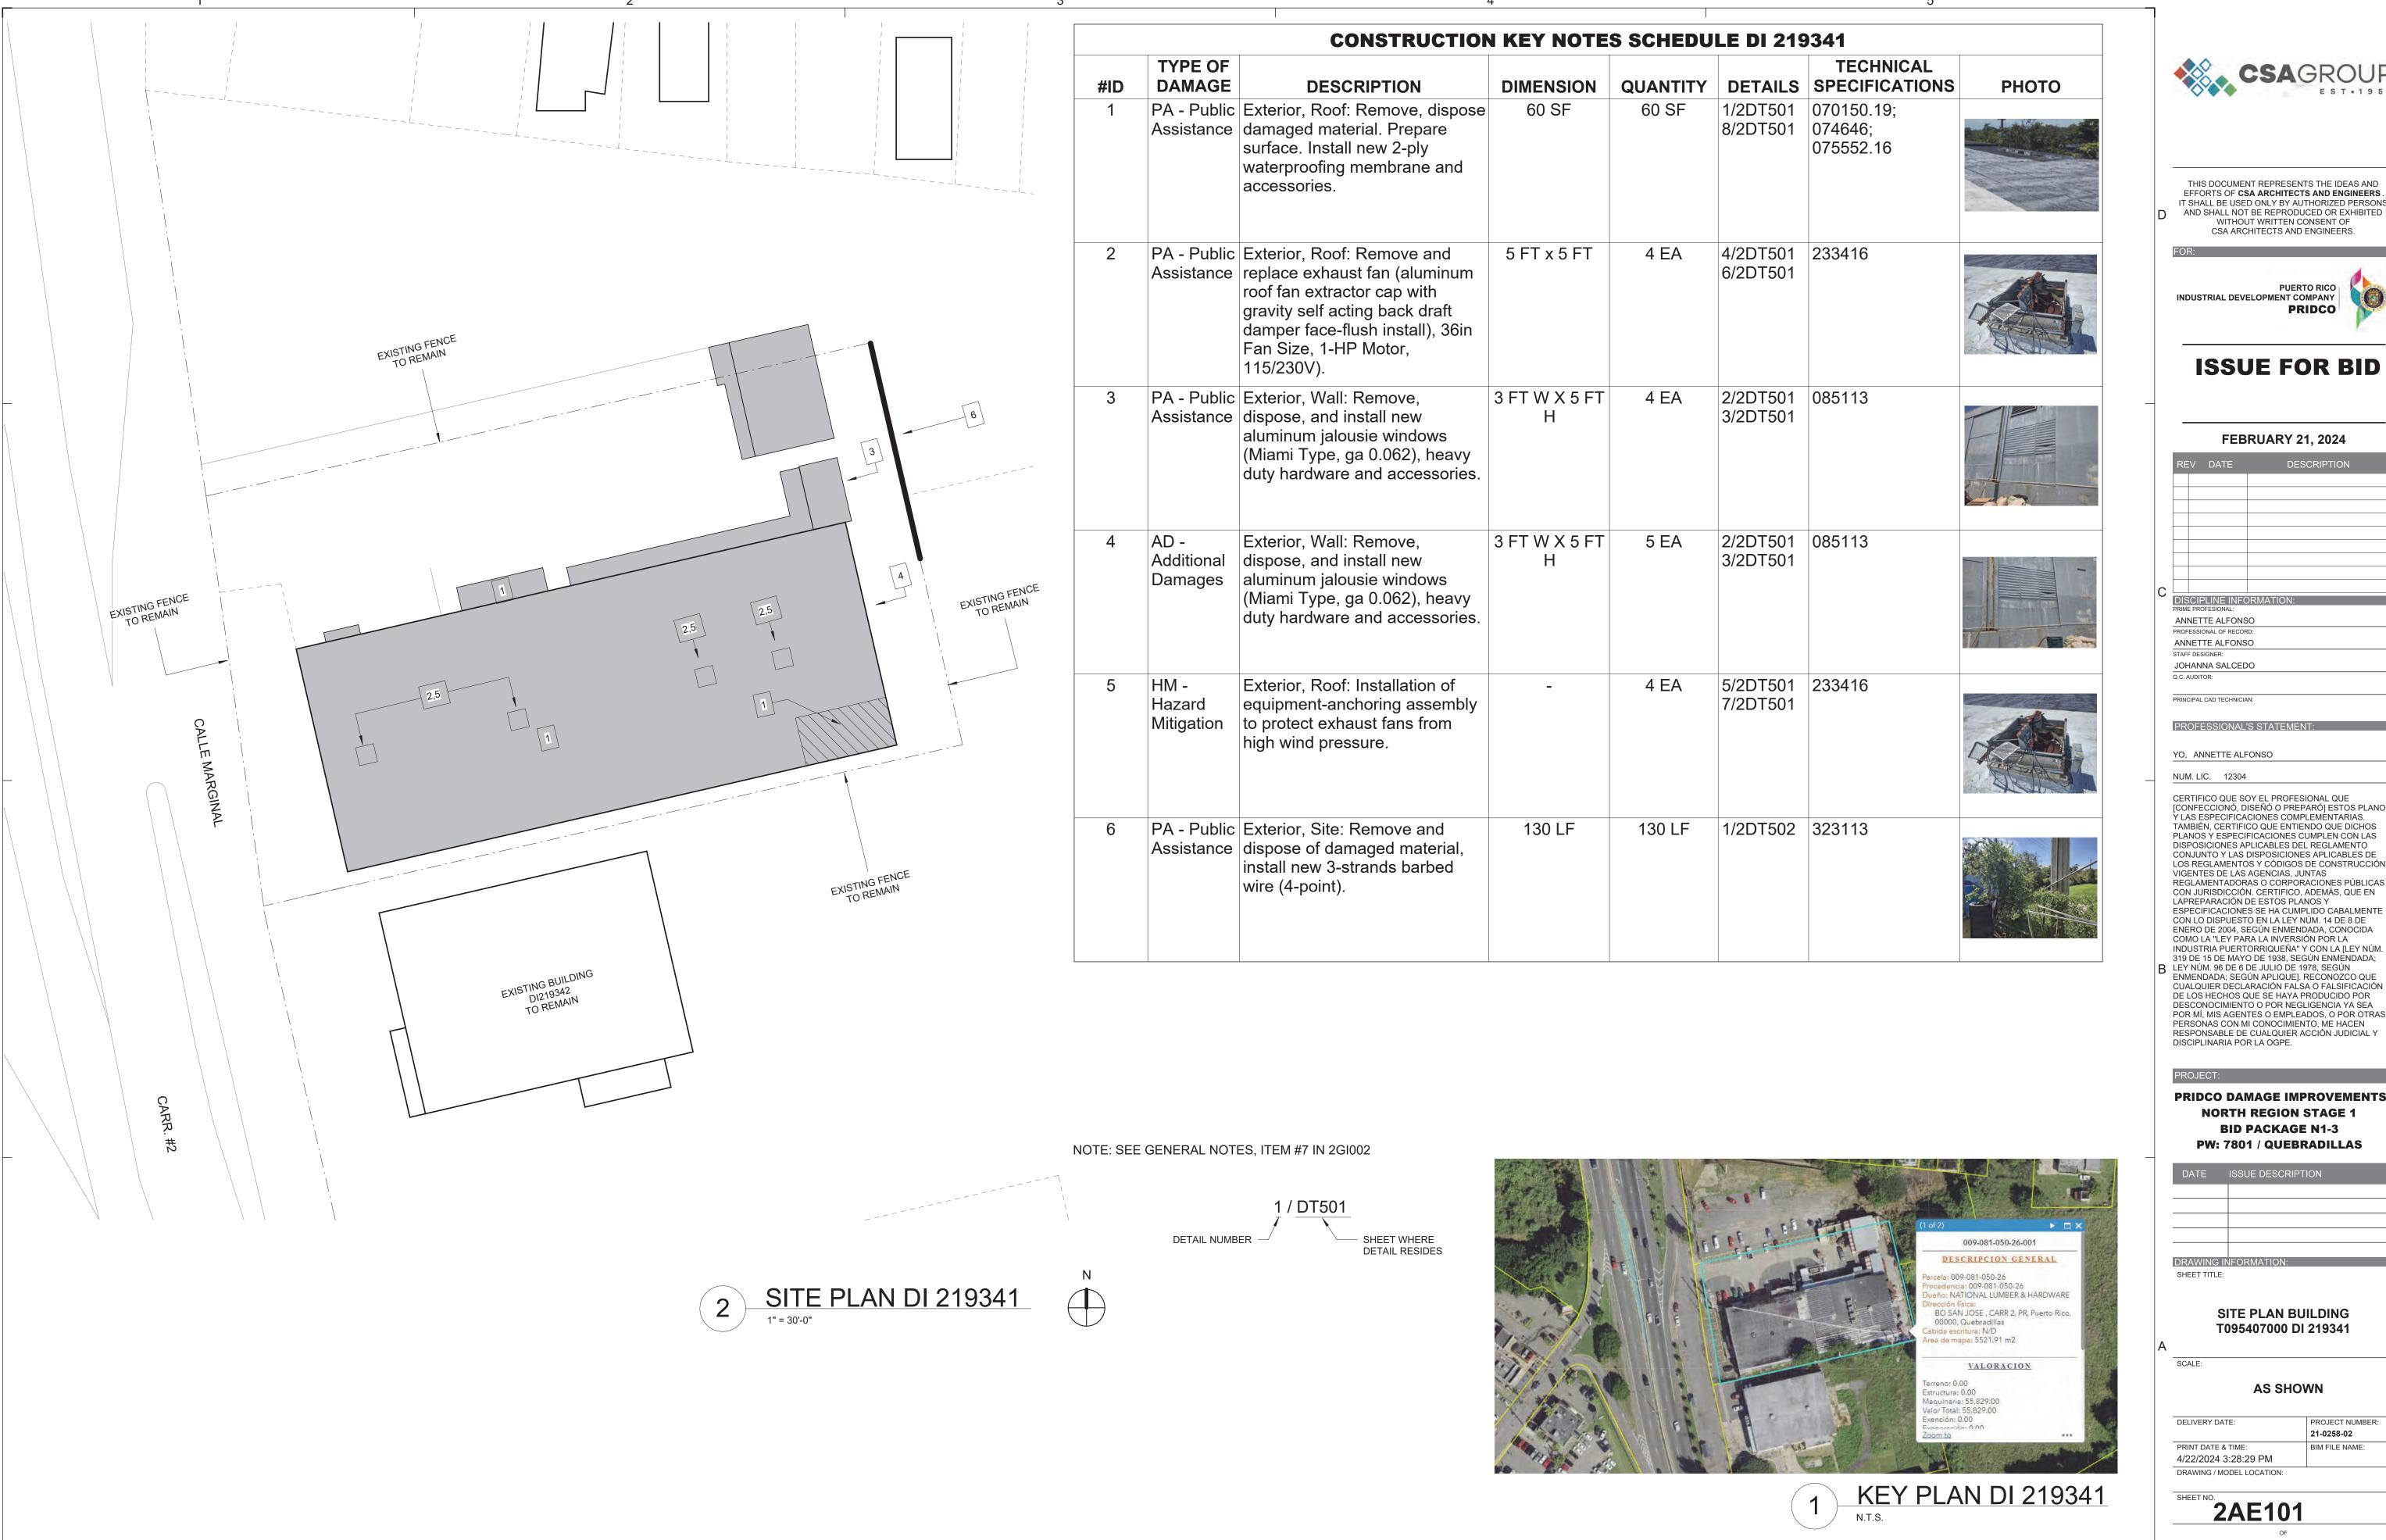



THIS DOCUMENT REPRESENTS THE IDEAS AND EFFORTS OF CSA ARCHITECTS AND ENGINEERS. IT SHALL BE USED ONLY BY AUTHORIZED PERSONS AND SHALL NOT BE REPRODUCED OR EXHIBITED
WITHOUT WRITTEN CONSENT OF

PUERTO RICO
INDUSTRIAL DEVELOPMENT COMPANY



FEBRUARY 21, 2024

	RE	V	DATE	DESCRIPTION
С				
	DIS	CIP	LINE INFO	ORMATION:
	PRIME	PRO	FESIONAL:	
	INA	VET1	TE ALFONS	80
	PROF	ESSIO	NAL OF RECOF	RD:
	ANN	VETT	E ALFONS	6O

CERTIFICO QUE SOY EL PROFESIONAL QUE [CONFECCIONÓ, DISEÑÓ O PREPARÓ] ESTOS PLANOS TAMBIÉN, CERTIFICO QUE ENTIENDO QUE DICHOS PLANOS Y ESPECIFICACIONES CUMPLEN CON LAS DISPOSICIONES APLICABLES DEL REGLAMENTO CONJUNTO Y LAS DISPOSICIONES APLICABLES DE LOS REGLAMENTOS Y CÓDIGOS DE CONSTRUCCIÓN VIGENTES DE LAS AGENCIAS, JUNTAS REGLAMENTADORAS O CORPORACIONES PÚBLICAS CON JURISDICCIÓN. CERTIFICO, ADEMÁS, QUE EN LAPREPARACIÓN DE ESTOS PLANOS Y ESPECIFICACIONES SE HA CUMPLIDO CABALMENTE CON LO DISPUESTO EN LA LEY NÚM. 14 DE 8 DE ENERO DE 2004, SEGÚN ENMENDADA, CONOCIDA COMO LA "LEY PARA LA INVERSIÓN POR LA INDUSTRIA PUERTORRIQUEÑA" Y CON LA [LEY NÚM. 319 DE 15 DE MAYO DE 1938, SEGÚN ENMENDADA; LEY NÚM. 96 DE 6 DE JULIO DE 1978, SEGÚN ENMENDADA; SEGÚN APLIQUE]. RECONOZCO QUE CUALQUIER DECLARACIÓN FALSA O FALSIFICACIÓN DE LOS HECHOS QUE SE HAYA PRODUCIDO POR DESCONOCIMIENTO O POR NEGLIGENCIA YA SEA POR MÍ, MIS AGENTES O EMPLEADOS, O POR OTRAS


PRIDCO DAMAGE IMPROVEMENTS **NORTH REGION STAGE 1 BID PACKAGE N1-3**

\neg			
	DATE	ISSUE DESCRIPTION	
	DRAMING	INICODMATIONI	

SITE PLAN BUILDING T095407000 DI 219341

AS SHOWN

21-0258-02 BIM FILE NAME:

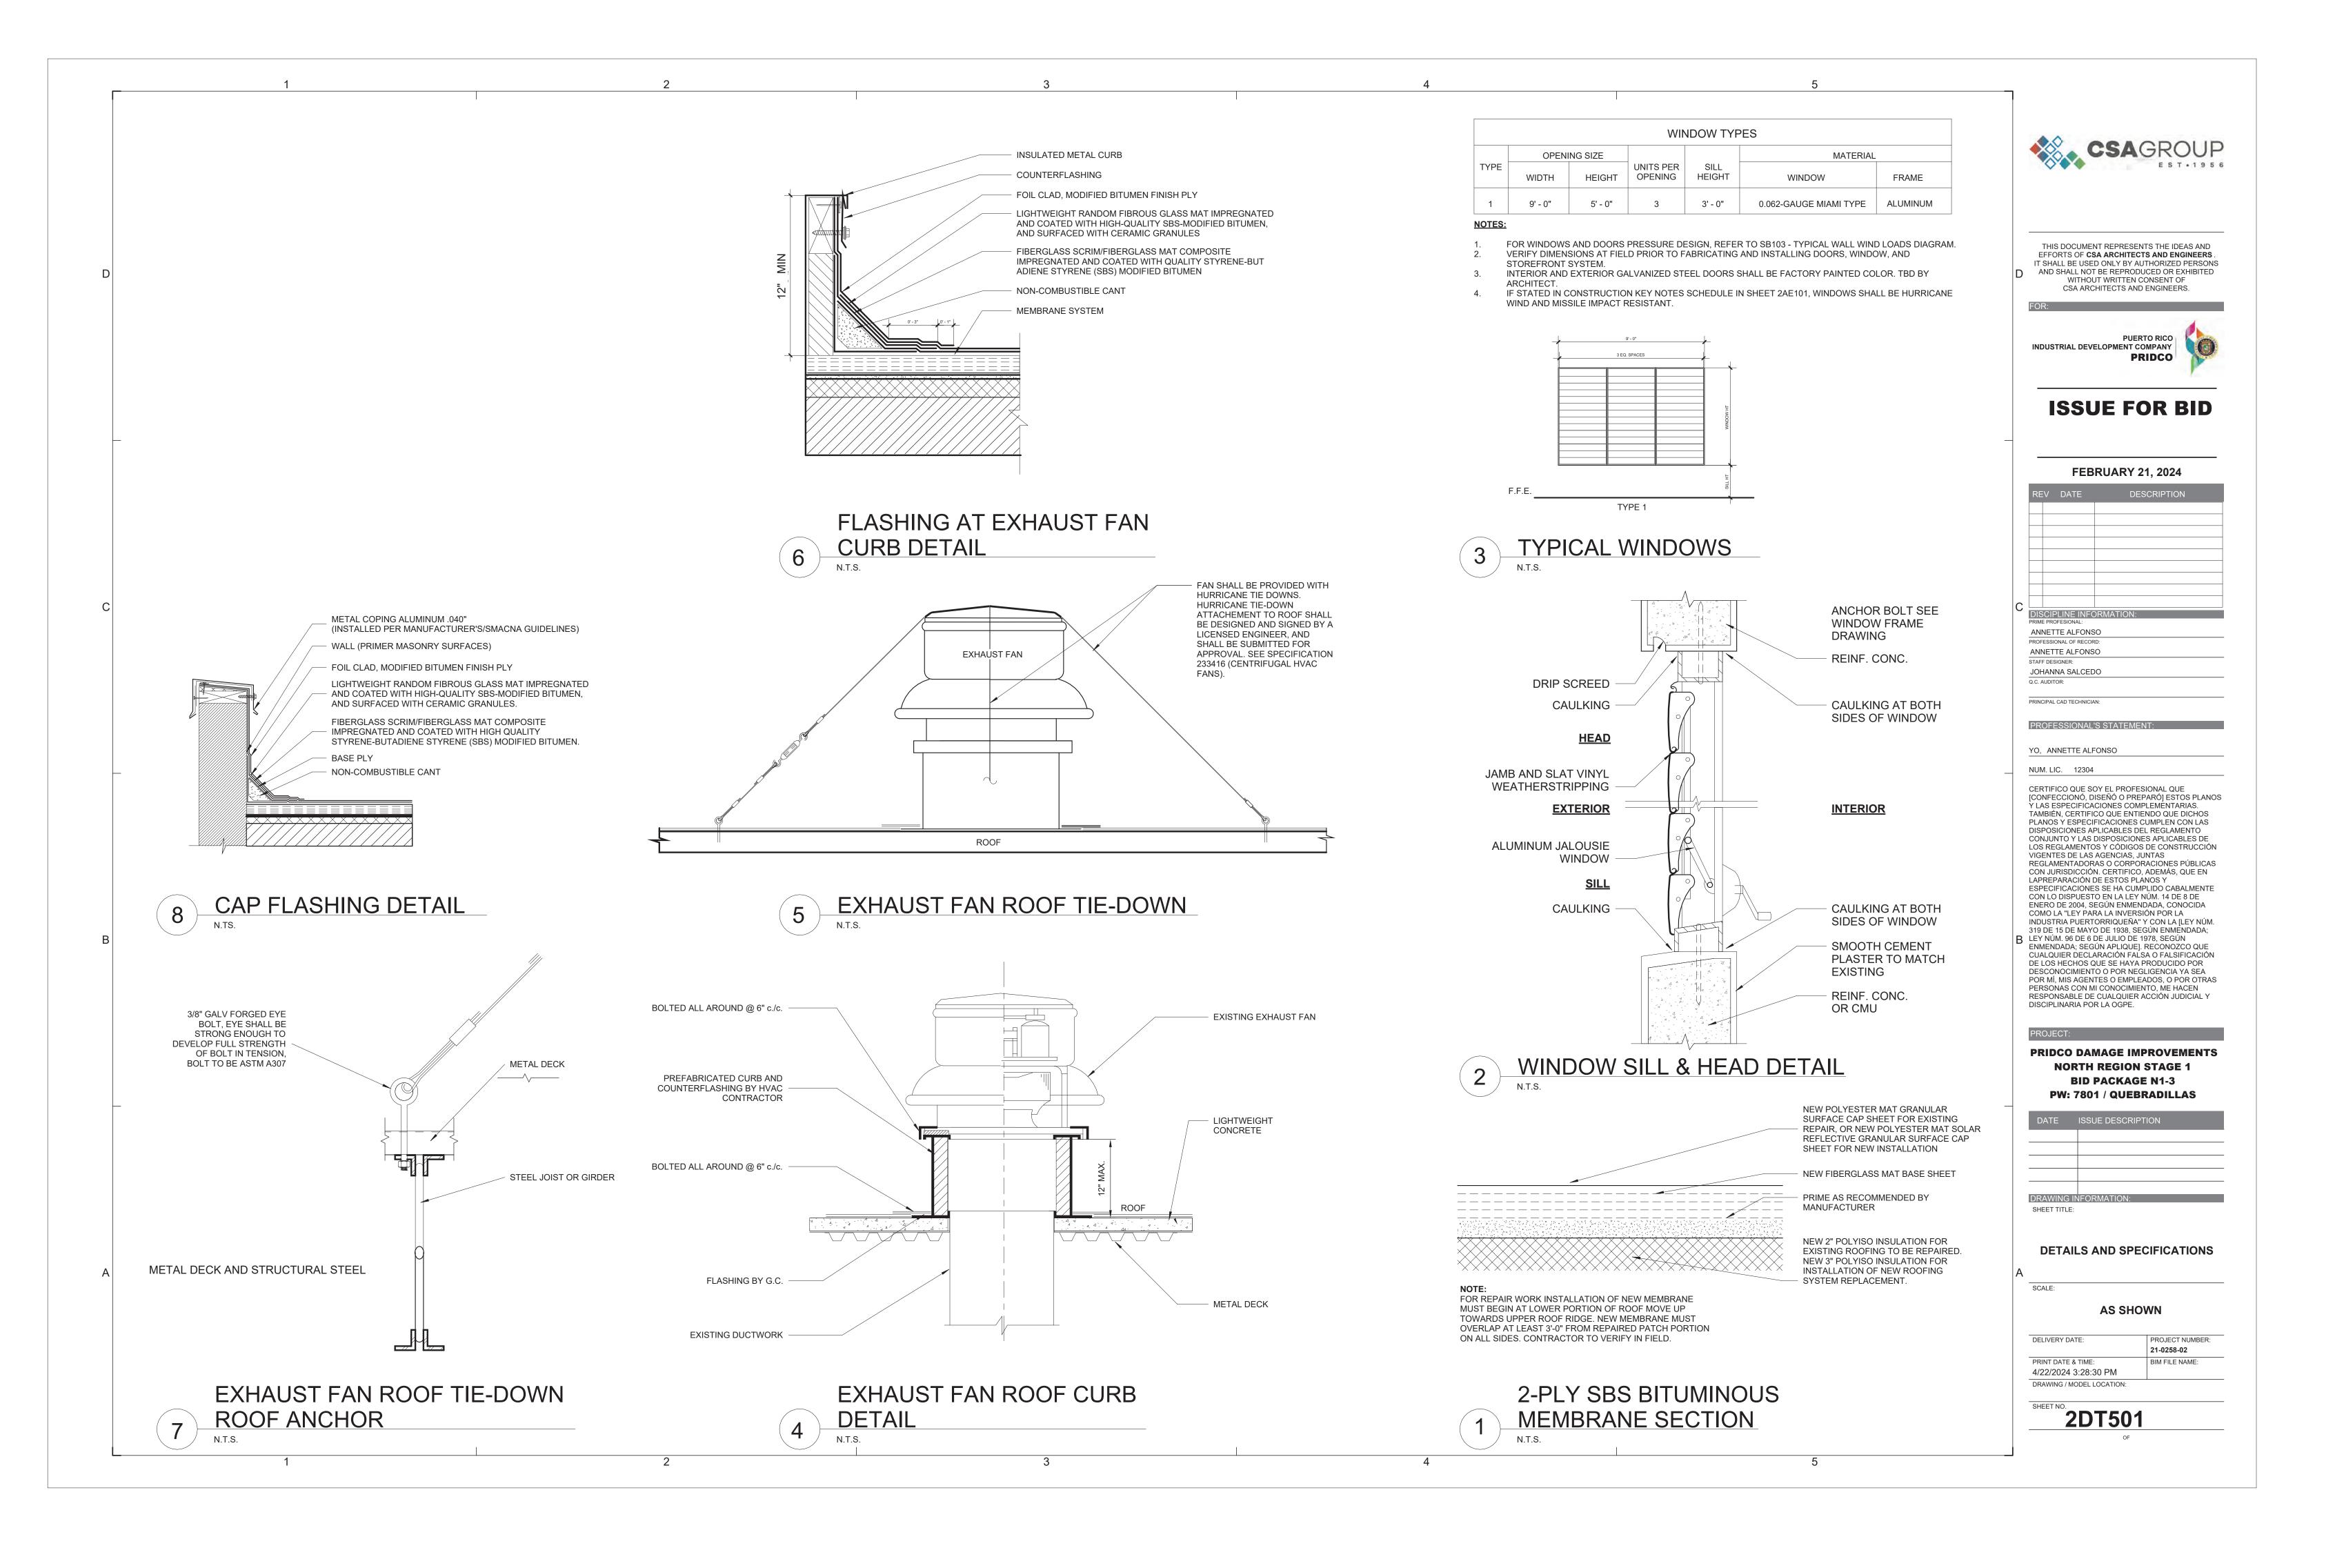


* * * * * * * * * * *

RAIL OR BRACE END

BRACE -

TENSION BAR

FINISHED GRADE LINE

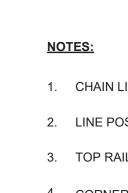

1. CHAIN LINK FENCE - INDUSTRIAL TYPE NO.423

2. LINE POSTS 2 1/2" O.D. GALV. - STD.WEIGHT PIPE-3.85 LBS. PER LIN. FT.

3. TOP RAIL 1 5/8" O.D. GALV. - STD.WEIGHT PIPE-2.27 LBS. PER LIN. FT. (GATE FRAME IDEM.)

4. CORNER POST 3"Ø O.D. GALV. - STD. WEIGHT PIPE - 6.79 LBS. PER LIN. FT.

5. TENSION WIRE GA. NO.7 GALVANIZED

6. GATE POST 4"O.D. GALV. - STD. WEIGHT PIPE - 9.10 LBS. PER LIN. FT.


7. GALVANIZED CHAIN LINK GA. 9-2"X2"-1.2 OUNCES GALVANIZED AFTER WOOVEN.

8. STD. WEIGHT PIPE, SCHEDULE 40A. 120

9. TUBULAR STEEL PIPE SHALL BE INSTALLED EVERY 50'- 0" PANEL SPAN (SPAN = 10'- 0")
 • TUBULAR STEEL PIPE SHALL BE INSTALLED EVERY DIRECTIONS CHANGE IN THE FENCE
 • TUBULAR STEEL PIPE SHALL BE INSTALLED AT EACH FENCE END PANEL.

10. ALL FITTINGS - EXTRA HEAVY DUTY

11. MILL CERTIFICATE SHALL BE SUBMITTED.

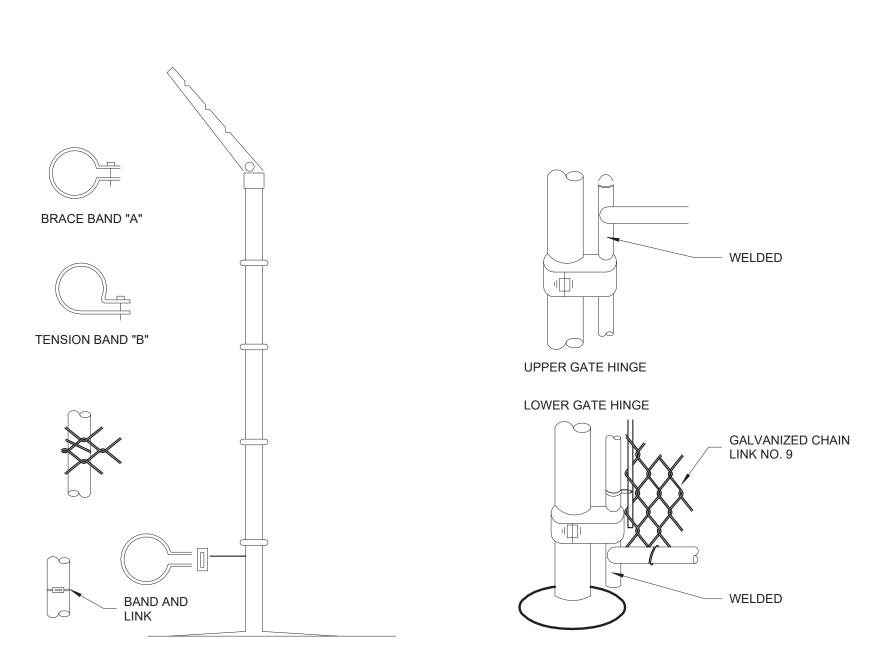

INSTALLATION DETAILS FOR CHAIN LINK FENCE & GATES


ALUM TOP

BRACE ROD

TURNBUCKLE

AND

RAIL OR POSTS TIES

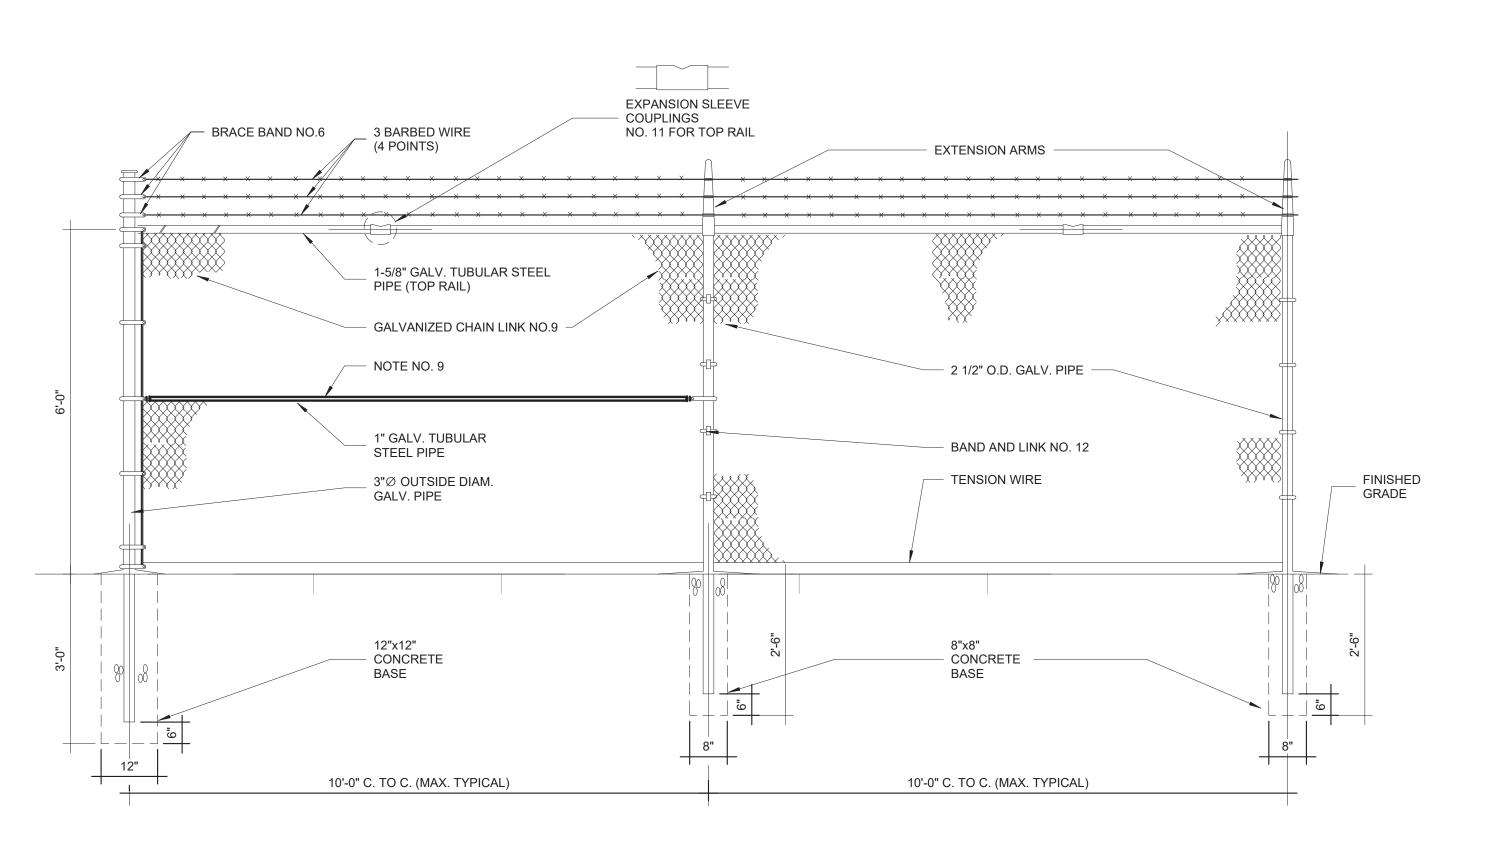

CHAIN LINK FENCE PARTIAL ELEVATION (ALONG PROPERTY LIMITS)





THIS DOCUMENT REPRESENTS THE IDEAS AND EFFORTS OF **CSA ARCHITECTS AND ENGINEERS**. IT SHALL BE USED ONLY BY AUTHORIZED PERSONS AND SHALL NOT BE REPRODUCED OR EXHIBITED WITHOUT WRITTEN CONSENT OF CSA ARCHITECTS AND ENGINEERS.

PUERTO RICO
INDUSTRIAL DEVELOPMENT COMPANY
PRIDCO



FEBRUARY 21, 2024

	REV	DATE	DESCRIPTION
С			
-			ORMATION:
	PRIME PR	OFESIONAL:	

PRIME PROFESIONAL:

ANNETTE ALFONSO

PROFESSIONAL OF RECORD:

ANNETTE ALFONSO
STAFF DESIGNER:
JOHANNA SALCEDO

PRINCIPAL CAD TECHNICIAN:

PROFESSIONAL'S STATEMENT:

YO, ANNETTE ALFONSO

_____NUM. LIC. 12304

CERTIFICO QUE SOY EL PROFESIONAL QUE [CONFECCIONÓ, DISEÑÓ O PREPARÓ] ESTOS PLANOS VIAS ESPECIFICACIONES COMPLEMENT TAMBIÉN, CERTIFICO QUE ENTIENDO QUE DICHOS PLANOS Y ESPECIFICACIONES CUMPLEN CON LAS DISPOSICIONES APLICABLES DEL REGLAMENTO CONJUNTO Y LAS DISPOSICIONES APLICABLES DE LOS REGLAMENTOS Y CÓDIGOS DE CONSTRUCCIÓN VIGENTES DE LAS AGENCIAS, JUNTAS REGLAMENTADORAS O CORPORACIONES PÚBLICAS CON JURISDICCIÓN. CERTIFICO, ADEMÁS, QUE EN LAPREPARACIÓN DE ESTOS PLANOS Y ESPECIFICACIONES SE HA CUMPLIDO CABALMENTE CON LO DISPUESTO EN LA LEY NÚM. 14 DE 8 DE ENERO DE 2004, SEGÚN ENMENDADA, CONOCIDA COMO LA "LEY PARA LA INVERSIÓN POR LA INDUSTRIA PUERTORRIQUEÑA" Y CON LA [LEY NÚM. 319 DE 15 DE MAYO DE 1938, SEGÚN ENMENDADA; B LEY NÚM. 96 DE 6 DE JULIO DE 1978, SEGÚN ENMENDADA; SEGÚN APLIQUE]. RECONOZCO QUE CUALQUIER DECLARACIÓN FALSA O FALSIFICACIÓN DE LOS HECHOS QUE SE HAYA PRODUCIDO POR DESCONOCIMIENTO O POR NEGLIGENCIA YA SEA POR MÍ, MIS AGENTES O EMPLEADOS, O POR OTRAS PERSONAS CON MI CONOCIMIENTO, ME HACEN RESPONSABLE DE CUALQUIER ACCIÓN JUDICIAL Y DISCIPLINARIA POR LA OGPE.

PRIDCO DAMAGE IMPROVEMENTS NORTH REGION STAGE 1 BID PACKAGE N1-3 PW: 7801 / QUEBRADILLAS

DAT	E ISS	SUE DESCRIP	TION	
DRAV	<u>/ING INFO</u>	RMATION:		
SHEET	TITLE:			

DETAILS AND SPECIFICATIONS

AS SHOWN

DELIVERY DATE:

PROJECT NUMBER:
21-0258-02

PRINT DATE & TIME:
4/22/2024 3:28:31 PM


PROJECT NUMBER:
21-0258-02

BIM FILE NAME:

2DT502


DRAWING / MODEL LOCATION:

3 4

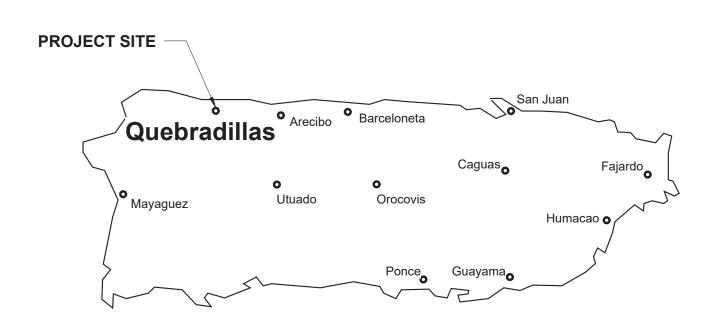





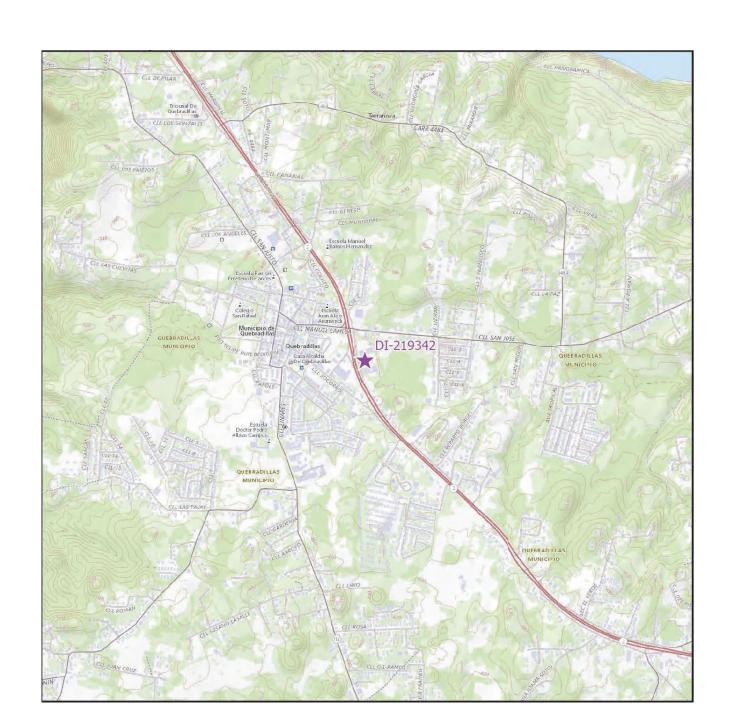

FLOOD MAP


AERIAL PHOTO 18.47226, -66.93412 LOCATION MAP SCALE 1: 20,000

INDEX OF DRAWINGS - PW 7801, DI 219342					
	Sheet	Current			
Discipline	Number	Revision	Sheet Name		
00-GENERAL	3GI001		COVER SHEET - DI 219342		
00-GENERAL	3GI002		GENERAL NOTES, ABBREVIATIONS AND LEGEND		
03-ARCHITECTURAL	3AE101		SITE PLAN BUILDING T102907000 DI 219342		
05-DETAILS	3DT501		DETAILS AND SPECIFICATIONS		
05-DETAILS	3DT502		DETAILS AND SPECIFICATIONS		

PRIDCO-FEMA 4339 DR PROGRAM NORTH REGION STAGE 1 BID PACKAGE N1-3

3. PW: 7801 | DI: 219342 | Bldg: T102907000

Road PR-2, Km. 100.7, San Jose Ward Quebradillas, Puerto Rico

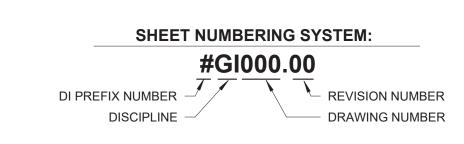





COVER SHEET	- DI 219342
SCALE:	
AS SH	OWN
DELIVERY DATE:	PROJECT NUMBER 21-0258-02
PRINT DATE & TIME: 4/22/2024 3:28:32 PM	BIM FILE NAME:
DRAWING / MODEL LOCATION:	

CALLED FOR IN SAID CODES COMPLY WITH APPLICABLE RULES AND REGULATIONS FOR OBTAINING NECESSARY AND REQUIRED INSPECTIONS, APPROVALS AND PERMITS NECESSARY TO PERFORM WORK AND SERVICES FOR THE PROJECT.

EXECUTE WORK IN ACCORDANCE WITH THE BEST ACCEPTED TRADE PRACTICES, AS PER MANUFACTURER'S WRITTEN RECOMMENDATIONS, AND IN A CAREFUL AND ORDERLY MANNER WITH THE LEAST POSSIBLE NOISE, DUST, OR DISTURBANCE TO OCCUPANTS

IMPLEMENT SAFETY CONTROLS DURING DEMOLITION/CONSTRUCTION DAILY REMOVE DEBRIS RESULTING FROM DEMOLITION/CONSTRUCTION

AND TRANSPORT IT OUT OF PROJECT LIMITS. PERFORM DISPOSAL OPERATION IN ACCORDANCE WITH GOVERNMENT APPROVALS AND REGULATIONS. SITE AND STRUCTURE SHALL BE LEFT BROOM CLEAN FOR SUBSTANTIAL COMPLETION. DO NOT SCALE DRAWINGS. VERIFY DIMENSIONS IN THE FIELD BEFORE

PROCEDING WITH ANY PORTION OF THE WORK. ADVISE IN WRITING TO CONSTRUCTION MANAGER AND ARCHITECT OF DISCREPANCY BETWEEN **EXISTING CONDITIONS AND DRAWINGS** REPORT TO CONSTRUCTION MANAGER AND ARCHITECT DISCREPANCIES

IN THE CONTRACT DRAWINGS, SPECIFICATIONS OR DETAILS PRIOR TO COMMENCING THE WORK. COORDINATE CIVIL, MECHANICAL, ELECTRICAL, ARCHITECTURAL AND

STRUCTURAL REQUIREMENTS FOR PROPER LOCATION AND PROVISIONS OF SLEEVES, INSERTS, OPENINGS AND ROUGH-IN REQUIRED CONDUCT DEMOLITION/CONSTRUCTION OPERATION TO INSURE MINIMUM INTERFERENCE WITH ROADS, STREETS, SIDEWALKS AND OTHER

ADJACENT FACILITIES THE USE OF A BRAND NAME AND/OR MODEL NUMBER TO DENOTE PRODUCTS, EQUIPMENTS, MATERIALS, OR PROCESS, IS INTENDED TO ESTABLISH A STANDARD OF QUALITY AND SHALL NOT BE CONSTRUED AS LIMITING COMPETITION.

DO NOT COMMENCE ANY DEMOLITION OF SITE ELEMENTS OR STRUCTURE UNTIL THE HAZARDOUS MATERIAL ABATEMENT IS DONE AND EPA CERTIFICATION IS OBTAINED, STATING THAT THE SITE ELEMENTS AND STRUCTURES ARE FREE OF HAZARDOUS MATERIALS. PRIOR TO COMMENCEMENT OF THE HAZARDOUS MATERIAL ABATEMENT THE BUILDING AND SITE SHALL BE VACANT.

SPECIFIED TREE PRUNING OR CUTTING OR INCIDENTAL TO OTHER REPAIR WORK MAY REQUIRE A DRNA PERMIT. THE CONTRACTOR IS RESPONSIBLE FOR OBTAINING PERMIT BEFORE PERFORMING THE WORK.

PRESSURE WASH, MINIMUM 3,000 PSI, EXISTING BUILDING EXTERIOR

WALLS, WINDOWS, AND DOORS BEFORE BEGINNING SPECIFIED WORK. REPAIR INTERIOR AND EXTERIOR WALL SURFACES WITH CEMENT PLASTER PRIOR TO APPLYING PAINT FINISH. REPAIR WORK INCLUDES, BUT IS NOT LIMITED TO CUT AND PATCHING, REMOVAL OF NAILS AND SCREWS FROM WALLS, REPAIR OF MAJOR IMPERFECTIONS ON

WALLS AND FINISHES IN GENERAL FULL TEAR-OFF OF ROOF WATERPROOFING SYSTEM INCLUDING MEMBRANE, INSULATION AND FLASHINGS WHERE SYSTEM REPLACEMENT IS SPECIFIED. A ROOF MOISTURE SURVEY MAY BE REQUIRED PRIOR TO INSTALLATION OF NEW MEMBRANE

CLEAN, REPAIR AND VERIFY STRUCTURAL INTEGRITY OF ROOF DECK PRIOR THE INSTALLATION OF THE WATERPROOFING SYSTEM. COMPLY WITH THE MANUFACTURER RECOMMENDATIONS FOR THE INSTALLATION OF ROOF MEMBRANE TO VALIDATE THE WARRANTY.

ELECTRICAL GENERAL NOTES

INDICATED

NO WIRE SHALL BE SMALLER THAN # 12 AWG THHN, 600 VOLTS. NO CONDUIT SHALL BE SMALLER THAN 3/4" ALL CONDUIT SHALL BE RIGID GALVANIZED EXCEPT OTHERWISE

ALL WIRE SHALL BE COPPER, INSULATED AS NOTED.

LEAVE A #12 AWG GALVANIZED FISH WIRE IN ALL EMPTY CONDUITS. ALL UNDERGROUND CONDUITS SHALL BE PROTECTED WITH 4" CONCRETE ENVELOPE

EXPANSION FITTINGS SHALL BE USED FOR EVERY CONDUIT CROSSING BUILDING EXPANSION JOINTS.

CONTRACTOR SHALL BALANCE ALL LOADS PROVIDE A #12 GREEN THW BONDING JUMPER BETWEEN EACH OUTLET BOX AND RECEPTACLE GROUNDING TERMINAL, USE 3/8" LONG 10-32

GROUNDING SCREW ALL INSTALLATIONS SHALL BE EXPOSED UNLESS OTHERWISE INDICATED. EXPOSED CONDUITS SHALL BE SUPPORTED BY MEANS OF ONE BOLT CLAMP SPACED NOT FURTHER THAN 7'-6" APART.

AN EXPOSED WORK CONDULET SHALL BE USED FOR ALL 90 BENDS. ALL NON-GALVANIZED METAL PARTS SHALL BE GIVEN ONE COAT OF RED OXIDE AND TWO COATS OF METALLIC GRAY PRIOR TO INSTALLATION.

ALL GALVANIZED RIGID CONDUITS FOR TOGGLE SWITCHES AND RECEPTACLES LOCATED AT DOORWAYS AND LEAN - TO SHALL BE CONCEALED WITHIN ROOF SLAB, WALLS AND OVERHANGS. CONTRACTOR SHALL PROVIDE ELECTRICAL SERVICE TO TEST ALL

ELECTRICAL SYSTEM IN PRESENCE OF THE REPRESENTATIVE FROM THE MECHANICAL AND ELECTRICAL DEPARTMENT ALL LIGHTING CIRCUITS SHALL HAVE ONE (1) PORCELAIN LIGHT SOCKET

WITH A LED TYPE BULB, EQUIVALENT TO 100W INCANDESCENT LUMENS. SWITCHES AND RECEPTACLES SHALL BE INSTALLED 4'-0" A.F.F. THE NEUTRAL WIRES SHALL BE IDENTIFIED THROUGHT THE INSTALLATION

BY THE USE OF WHITE COLOR COVERED LIVE WIRES WITHIN THE SAME CONDUIT SHALL BE COLOR CODED AS PER N.E.C. RECEPTACLES AND LIGHTING CIRCUITS SHALL BE #12 THHN WIRE AND

SHALL BE CONNECTED TO 20 AMP BREAKERS AT THE PANELBOARD. ALL OVERHANGS AND LEAN - TO'S SHALL BE PROVIDED WITH LIGHT SOCKETS

CONTRACTOR SHALL VERIFY LENGTH OF FEEDERS IN THE FIELD BEFORE SUBMITTING BIDS ALL SWITCHES AND RECEPTACLES THAT ARE CONCEALED IN WALLS AND

OVERHANGS SHALL BE PROVIDED WITH STAINLESS STEEL COVERS. CONTRACTOR SHALL CONTACT THE DISTRICT ENGINEER OF LUMA PRIOR | 12. TO THE BEGINNING OF THE WORK AND COORDINATE WITH THEM FOR THE EXECUTION OF THE WORK CONCERNING THE SERVICE ENTRANCE AND SUBSTATION IF REQUIRED. IN ADDITION, THE CONTRACTOR SHALL OBTAIN | 13. A CERTIFICATE OF INSPECTION AT THE COMPLETION OF THE WORK AND SHALL FORWARD IT TO THE PUERTO RICO INDUSTRIAL DEVELOPMENT

ALL INSTALLATIONS SHALL BE IN ACCORDANCE WITH THE LATEST RULES AND REGULATIONS OF THE N.E.C. AND LUMA

ALL BOXES FOR RECEPTACLES & LIGHTING SWITCHES FOR EXPOSED

INSTALLATION SHALL BE "FS" TYPE.

CONTRACTOR SHALL SUBMIT A LIST OF MATERIALS AND EQUIPMENT GIVING MANUFACTURER CATALOG NUMBERS AND COMPLETE SPECIFICATIONS AND DRAWINGS FOR APPROVAL OF P.R.I.D.C.O. PRIOR TO THE PURCHASING OF SAID MATERIALS AND/OR EQUIPMENT.

PLUMBING GENERAL NOTES:

PLUMBING SHALL BE IN STRICT ACCORDANCE WITH THE 2018 PUERTO RICO BUILDING CODE.

FURNISH AND SET IN PLACE BEFORE CONCRETE POURING ALL NECESSARY SLEEVES FOR WASTE OR SOIL, VENT, HOT, AND COLD WATER LINES, THESE SLEEVES SHALL BE AS SPECIFIED OR REQUIRED BY THE

THE PLUMBING DRAWING IS GENERALLY DIAGRAMATTIC AND INDICATIVE OF THE WORK TO BE INSTALLED. RUN ALL PIPING CONCEALED WHEREVER POSSIBLE UNLESS OTHERWISE NOTED.

SIZES SHOWN IN FIXTURE SCHEDULE ARE MINIMUM AND SHALL BE INCREASED AS NECESSARY TO COMPLY WITH CODE REQUIREMENTS OR AS SHOWN ON DRAWINGS.

BEFORE CONSTRUCTION VERIFY EXISTING ELEVATIONS AGAINST PROPOSED SLOPES. ANY DISCREPANCIES SHALL BE BROUGHT TO THE ATTENTION OF THE ARCHITECT.

CLEANOUT SHALL BE OF SAME SIZE AS THE PIPES TO WHICH THEY ARE CONNECTED UP TO 4", FOR LARGE

UNLESS OTHERWISE INDICATED, ALL DRAINAGE PIPING 3" AND SMALLER SHALL BE SLOPED 1/4" PER FT., LARGER

CLEANOUT SHALL BE NOT MORE THAN 50 FEET AP-ART IN HORIZONTAL DRAINAGE LINES OF 4" NOMINAL DIAMETER OR LESS AND NOT MORE THAN 100 FEET APART FOR LARGER PIPES.

FOR FIXTURES AND EQUIPMENT NOT LISTED IN SCHEDULE, SEE CONTRACT SPECIFICATIONS.

DETERMINE EXACT LOCATION OF THE PIPING TO AVOID ANY INTERFERENCE WITH PIPING AND/OR EQUIPMENT BEING INSTALLED BY ANOTHER SUB-CONTRACTOR.

SANITARY TEES (SINGLE AND DOUBLE) AND QUARTER BENDS SHALL BE ACCEPTABLE ONLY FOR CHANGES OF DIRECTION FROM HORIZONTAL TO VERTICAL

USE LONG SWEEPING FITTINGS AND/OR LONG SWEEP BENDS AT BASE OF ALL STACKS.

PROVIDE ROUGHING-IN AND INSTALL ALL PLUMBING FIXTURES AND/OR EQUIPMENT WHICH ARE SUPPLIED BY

FOR ALL UNDERGROUND SANITARY AND STORM DRAINAGE USE: PVC POLYVINYL CHLORIDE) SEWER PIPE AND FITTING: ASTM D 3034, SDR-35, FOR SOLVENT CEMENT OR ELASTOMERIC GASKET JOINTS. A. SOLVENT CEMENT: ASTM D 2564 B. GASKETS: ASTM F 477, ELASTOMERIC SEAL.

PROVIDE ALL PIPE OPENINGS THROUGH SLABS WITH SLEEVES HAVING AN INTERNAL DIAMETER AT LEAST 1" LARGER THAN THE OUTSIDE DIAMETER OF UN-INSULATED PIPES OR OF THE INSULATION FOR INSULATION SERVICES. FLOOR SLEEVES ARE TO PROJECT 2" ABOVE FINISHED FLOORS.

SLEEVES SHALL BE SCHEDULES 40 GALVANIZED STEEL PIPE.

BOTTOM OF THE WATER SERVICES LINE SHALL BE 12 INCHES ABOVE THE HIGHEST POINT OF THE SEWER LINE WHENEVER THE HORIZONTAL DISTANCE BETWEEN THEM IS LESS THAN 5 FT.

PROVIDE DOWNSPOUT NOZZLES (SIMILAR TO JAY R. SMITH FIG 1770) AT THE OVERFLOW RAIN WATER OUTLETS,

CONTRACTOR SHALL SUPPLY AND INSTALL 1/4 TURN SHUT OFF VALVES AT EVERY PLUMBING FIXTURE.

ALL PLUMBING FIXTURES, COLORS AND FINISHES, SELECTION BY ARCHITECT

HVAC GENERAL NOTES:

SUPPLY AND INSTALL ALL ELECTRICAL CONTROLS, SAFETY SWITCHES AND ACCESSORIES NOT INDICATED IN THE ELECTRICAL DRAWING AND NECESSARY FOR THE PROPER OPERATION OF THE EQUIPMENT IN ACCORDANCE WITH THE MECHANICAL EQUIPMENT RECOMMENDATIONS AND THE NATIONAL ELECTRIC CODE.

PERFORM ALL WIRING AND CONNECTION (POWER AND CONTROL) NOT INDICATED IN THE ELECTRICAL DRAWINGS AND NECESSARY FOR THE PROPER OPERATION OF THE MECHANICAL EQUIPMENT IN STRICT ACCORDANCE WITH THE NATIONAL ELECTRIC CODE

TAKE EVERY PRECAUTION IN ORDER TO MINIMIZE OR ELIMINATE THE TRANSMISSION OF NOISE OR VIBRATION FROM THE EQUIPMENT, PIPING SYSTEM OR DUCT SYSTEM TO THE CONDITIONING SPACE.

EQUIPMENT, MATERIALS AND ACCESSORIES SHALL BE SIMILAR TO THE INDICATED SPECIFICATION AND/OR MANUFACTURER MODEL OR CATALOG NUMBER.

UNLESS OTHERWISE NOTED IN DRAWINGS AND/OR SPECIFICATIONS ALL EQUIPMENT AND ACCESSORIES SHALL BE FURNISHED AND INSTALLED BY THE CONTRACTOR.

CIVIL SITE GENERAL NOTES

ALL DISTANCES AND ELEVATIONS ARE EXPRESSED IN METERS UNLESS OTHERWISE SPECIFIED. ELEVATIONS ARE REFERRED TO MEAN SEA LEVEL.

COORDINATES ARE BASED ON THE LAMBERT PROJECTION FOR PUERTO RICO AND THE US VIRGIN ISLAND AND REFERENCED TO THE NORTH AMERICAN DATUM OF 1983 (NAD83 NA2011) EPOCH 2010.00 ADJUSTED IN

THE CONTRACTOR SHALL COORDINATE WITH THE CONSTRUCTION MANAGER BEFORE CUTTING OR

TRIMMING EXISTING TREES AFFECTED BY THE CONSTRUCTION. THE CONTRACTOR SHALL PREPARE AND SUBMIT FOR EACH PROJECT AREA, THE CONTROL OF EROSION AND SEDIMENTATION (CES) PLAN FOR APPROVAL BY THE PERTINENT AGENCY AND THE CONSTRUCTION MANAGER.

THE CONTRACTOR SHALL PROVIDE AND MAINTAIN A DEWATERING SYSTEM TO KEEP SUBGRADES DRY AND CONVEY GROUND WATER AWAY FROM EXCAVATIONS. THE DEWATERING PLAN SHALL BE SUBMITTED TO THE CONSTRUCTION MANAGER FOR APPROVAL AND COORDINATION. DEWATERING PLANS SHALL INCLUDE CONTROL OF EROSION AND SEDIMENTATION FOR EACH PROJECT

PHASE AND/OR WORK AREA. THE WATER FROM THE DEWATERING SYSTEM SHALL BE FREE OF SEDIMENT AND/OR DEBRIS BEFORE ANY DISPOSAL. THE CONTRACTOR SHALL MAINTAIN THE DEWATERING SYSTEM UNTIL DEWATERING IS NO LONGER

ELECTRICAL, COMMUNICATION, SANITARY AND POTABLE WATER SERVICE SHALL NOT BE INTERRUPTED DURING CONSTRUCTION. IF NECESSARY, A PROVISIONAL TEMPORARY SERVICE AND/OR BY-PASS SHALL BE INSTALLED TO MAINTAIN SERVICE. PROVISIONAL TEMPORARY SERVICE AND/OR BY-PASS SHALL BE SUBMITTED TO THE CONSTRUCTION MANAGER FOR APPROVAL AND COORDINATION PRIOR TO CONSTRUCTION.

THE CONTRACTOR SHALL PREPARE AND SUBMIT THE MAINTENANCE OF SERVICE PLAN FOR ELECTRICAL

SANITARY AND POTABLE WATER FOR APPROVAL OF THE CONSTRUCTION MANAGER. THE CONTRACTOR SHALL NOTIFY THE CONSTRUCTION MANAGER IF ANY ELEMENT SUSPECTED OF CONTAINING HAZARDOUS MATERIAL IS ENCOUNTERED, PRIOR TO ANY RELATED WORK ACTIVITY. THE CONTRACTOR SHALL VISIT THE PROJECT AREA TO VERIFY THE SPACE LIMITATIONS FOR CONSTRUCTION

PROCESS AND EQUIPMENT. THE CONTRACT PRICE SHALL CONSIDER THE REQUIRED CONSTRUCTION PROCESS AND/OR EQUIPMENTS. PRIOR TO COMMENCEMENT OF THE WORK, CONTRACTOR SHALL VERIFY ALL DIMENSIONS AND EXISTING CONDITIONS AT PROJECT SITE AND SHALL NOTIFY THE CONSTRUCTION MANAGER OF ANY DISCREPANCIES BETWEEN EXISTING CONDITIONS AND CONTRACT DOCUMENTS THAT COULD AFFECT CONSTRUCTION WORK

SCHEDULE AND /OR PERFORMANCE ALL DETAILS, SECTIONS AND NOTES SHOWN ON DRAWINGS ARE INTENDED TO BE TYPICAL AND SHALL APPLY TO

SIMILAR SITUATIONS ELSEWHERE UNLESS OTHERWISE NOTED. THE CONTRACTOR SHALL REPAIR OR REPLACE EXISTING FACILITIES DAMAGED DURING CONSTRUCTION PRIOR TO SUBSTANTIAL COMPLETION

THE CONTRACTOR SHALL MAINTAIN IN OPERATION EXISTING FACILITIES UNTIL NEW FACILITIES ARE IN OPERATION.

GENERAL STRUCTURAL NOTES

STRUCTURAL BUILDING AND DESIGN CODES:

PUERTO RICO BUILDING CODE 2018 AND ITS BINDING REFERENCED STANDARDS, INCLUDING BUT NOT LIMITED TO THE INTERNATIONAL BUILDING CODE 2018

AMERICAN INSTITUTE FOR STEEL CONSTRUCTION (AISC), STEEL CONSTRUCTION MANUAL, 15 TH EDITION AMERICAN CONCRETE INSTITUTE (ACI), BUILDING CODE REQUIREMENTS FOR STRUCTURAL CONCRETE, ACI 318-14.

AMERICAN SOCIETY OF CIVIL ENGINEERS, MINIMUM DESIGN LOADS AND ASSOCIATED CRITERIA FOR BUILDINGS AND OTHER STRUCTURES, ASCE/SEI 7-16

STRUCTURAL NOTES ON CONCRETE REPAIR:

ALL CONCRETE REPAIR WORKS SHALL BE PERFORMED FOLLOWING THE GUIDELINES OF THE INTERNATIONAL CONCRETE REPAIR INSTITUTE (ICRI). HIRING A PROFESSIONAL EXPERIENCED IN THIS TYPE OF REPAIR IS RECOMMENDED TO ENSURE A PROPER

FOR THE REPAIR OF AREAS AFFECTED BY CORROSION, ICRI NO. 03730 GUIDELINE FOR SURFACE PREPARATION FOR THE REPAIR OF DETERIORATED CONCRETE RESULTING FROM REINFORCING STEEL CORROSION SHOULD BE FOLLOWED. BEFORE COMMENCING ANY CONCRETE REPAIR WORK, THE CONTRACTOR SHALL REVIEW THE REPAIR DETAILS PRESENTED IN THE DRAWINGS. IN CASE OF DOUBT WITH THE REPAIR DETAILS PRESENTED, THE CONTRACTOR SHOULD CONTACT THE

ARCHITECT OR ENGINEER OF RECORD TO CLARIFY THEM. IT IS IMPORTANT TO FOLLOW THE MANUFACTURER'S RECOMMENDATIONS FOR EACH PRODUCT UTILIZED FOR THIS JOB, IN ORDER TO GUARANTEE THAT THE REPAIR WORKS ARE CARRIED OUT ADEQUATELY.

<u>STRUCTURAL NOTES ON CAST-IN-PLACE CONCRETE:</u>

PORTLAND CEMENT SHALL BE TYPE II. ALL CONCRETE SHALL BE OF REGULAR WEIGHT (145 POUNDS PER CUBIC FOOT). THE FOLLOWING CONCRETE MIX PARAMETERS SHALL BE USED UNLESS OTHERWISE NOTED:

CONCRETE STRENGTH AT 28 DAYS – 3,000 PSI MAX. WATER/CEMENT RATIO - 0.65 RECOMMENDED SLUMP – 3 INCHES MAX. AGGREGATE SIZE (ASTM C33) – 1 INCH

PROVIDE CONCRETE MIXES DESIGNED BY A QUALIFIED TESTING LABORATORY FOR REVIEW AND APPROVAL BY THE STRUCTURAL ENGINEER. CONCRETE MIX DESING SHALL BE SIGNED AND SEALED BY A PROFESSIONAL ENGINEER AUTHORIZED TO EXERCISE THE PROFESSION IN THE COMMOM WEALTH OF PUERTO RICO.

NOTE ON REINFORCING STEEL BARS:

ALL REINFORCING STEEL SHALL BE NEW STOCK DEFORMED BARS CONFORMING TO ASTM A615, GRADE 60 (FY = 60 KSI).

MAINTAIN THE FOLLOWING CONCRETE COVERAGE FOR REINFORCING STEEL UNLESS NOTED OTHERWISE: CONCRETE CAST AGAINST EARTH: 3 INCHES

CONCRETE IN CONTACT WITH THE GROUND: 2 INCHES

CONCRETE SLAB AND WALLS WITHOUT CONTACT WITH GROUND: 1 INCHES

CONCRETE BEAMS AND COLUMNS: 1 1/2 INCHES

STRUCTURAL STEEL

DESIGN, DETAIL AND ERECT STRUCTURAL STEEL ELEMENTS IN ACCORDANCE WITH THE FOLLOWING:

AISC SPECIFICATION FOR THE DESIGN, FABRICATION, AND ERECTION OF STRUCTURAL STEEL FOR BUILDINGS

AISC MANUAL OF STEEL CONSTRUCTION, ALLOWABLE STRESS DESIGN. AISC CODE OF STANDARD PRACTICE FOR STEEL BUILDINGS AND BRIDGES.

AWS STRUCTURAL WELDING CODE, D1.1.

STRUCTURAL STEEL SHALL CONFORM TO THE FOLLOWING GRADES: W SHAPES: ASTM A992 (FY = 50 KSI, FU = 65 KSI)

STEEL ANGLE, CHANNELS, PLATES: ASTM A36

BOLTS, NUTS AND WASHERS: HIGH-STRENGTH BOLTS, INCLUDING NUTS AND WASHERS: ASTM A325 STEEL PLATES FOR LANDINGS AND THREADS: 1/4" ANTI-SLIP DIAMOND TYPE STEEL PLATE A36

WELDING ELECTRODE FOR STEEL SHALL BE E70XX.

PROVIDE DESIGN, FABRICATION, AND ERECTION OF METAL DECK CONFORMING TO THE STEEL DECK INSTITUTE'S "CODE OF FORM ROOF DECK FROM STEEL SHEETS CONFORMING TO ASTM A 611 GRADE C AND D OR A 653 OR HIGHER SPECIFICATIONS

WITH A MINIMUM YIELD STRENGTH OF 33 KSI. ATTACH SHEETS TO STEEL SUPPORT MEMBERS AS INDICATED AND IN ACCORDANCE WITH THE MANUFACTURER'S INSTRUCTIONS FOR INSTALLATION. WHEN DECK IS SCHEDULED TO BEEXPOSED, DE-SLAG, CLEAN AND TOUCH UP WELDS WITH A ZINC-RICH

LAP ROOF AND FLOOR DECK ENDS MINIMUM OF 2 INCHES. WHEN FASTENING DECK TO SUPPORT MEMBERS PROVIDE WELDING MATERIALS INSTALLATION PROCEDURES TO PREVENT BURNING OF HOLES IN DECK.

AT ENDS OF DECKS OR WHERE CHANGES OF DECK DIRECTION OCCUR, FASTEN TO SUPPORTS AT EACH FLUTE. PROVIDE ADEQUATE CLOSURES AND FASTENERS TO SIDES AT EIGHTEEN INCHES ON CENTER. WHERE PARTIAL PANELS MAY BE REQUIRED TO COMPLETE DECK INSTALLATION AT PERIMETER OF STRUCTURE, PROVIDE WELDS

IN EACH FLUTE TO STRUCTURAL MEMBERS. INSTALL DECK IN THREE CONTINUOUS SPAN LENGTHS. AT PERIMETER OF DECK, SECURE DECK TO STRUCTURAL MEMBERS WITH SAME ATTACHMENTAND SPACING SUPPORT ATTACHMENT AS INDICATED ON PLANS. HOT DIP GALVANIZE (G90) AFTER FABRICATION ALL METAL DECK AND TOUCH UP CONNECTIONS WITH A ZINC-RICH PRIMER.

NOTES (IF APPLICABLE):

TREE REMOVAL:

REMOVE ALL TREES INDICATED BY THE DRAWINGS AND SPECIFICATIONS, AS REQUIRING REMOVAL, IN A MANNER THAT WILL NOT DAMAGE ADJACENT TREES OR STRUCTURES OR COMPACTS THE SOIL. REMOVE TREES THAT ARE ADJACENT TO TREES OR STRUCTURES TO REMAIN, IN SECTIONS, TO LIMIT THE OPPORTUNITY OF

DAMAGE TO ADJACENT CROWNS, TRUNKS, GROUND PLANE ELEMENTS AND STRUCTURES. DO NOT DROP TREES WITH A SINGLE CUT UNLESS THE TREE WILL FALL IN AN AREA NOT INCLUDED IN THE TREE AND PLANT PROTECTION AREA. NO TREE TO BE REMOVED WITHIN 50 FEET OF THE TREE AND PLANT PROTECTION AREA SHALL BE PUSHED

REMOVE STUMPS AND IMMEDIATE ROOT PLATE FROM EXISTING TREES TO BE REMOVED. GRIND TRUNK BASES AND LARGE

OVER OR UP-ROOTED USING A PIECE OF GRADING EQUIPMENT. PROTECT ADJACENT PAVING, SOIL, TREES, SHRUBS, GROUND COVER PLANTINGS AND UNDERSTORY PLANTS TO REMAIN FROM DAMAGE DURING ALL TREE REMOVAL OPERATIONS, AND FROM CONSTRUCTION OPERATIONS. PROTECTION SHALL INCLUDE THE ROOT SYSTEM, TRUNK, LIMBS, AND CROWN FROM BREAKAGE OR SCARRING, AND THE SOIL FROM COMPACTION.

BUTTRESS ROOTS TO A DEPTH OF THE LARGEST BUTTRESS ROOT OR AT LEAST 18 INCHES BELOW THE TOP MOST ROOTS WHICH EVER IS LESS AND OVER THE AREA OF THREE TIMES THE DIAMETER OF THE TRUNK (DBH). FOR TREES WHERE THE STUMP WILL FALL UNDER NEW PAVED AREAS, GRIND ROOTS TO A TOTAL DEPTH OF 18 INCHES BELOW THE EXISTING GRADE. IF THE SIDES OF THE STUMP HOLE STILL HAVE GREATER THAN APPROXIMATELY 20% WOOD VISIBLE, CONTINUE GRINDING OPERATION DEEPER AND OR WIDER UNTIL THE RESULTING HOLE HAS LESS THAN 20% WOOD. REMOVE ALL WOOD CHIPS PRODUCED BY THE GRINDING OPERATION AND BACK FILL IN 8 INCH LAYERS WITH CONTROLLED FILL OF A QUALITY ACCEPTABLE TO THE SITE ENGINEER FOR FILL MATERIAL UNDER STRUCTURES, COMPACTED TO 95% OF THE MAXIMUM DRY DENSITY STANDARD PROCTOR. THE OWNER'S REPRESENTATIVE SHALL APPROVE EACH HOLE AT THE END OF THE GRINDING

IN AREAS WHERE THE TREE LOCATION IS TO BE A PLANTING BED OR LAWN, REMOVE ALL WOODCHIPS AND BACKFILL STUMP HOLES WITH PLANTING SOIL AS DEFINED IN SPECIFICATION SECTION PLANTING SOIL, IN MAXIMUM OF 12 INCH LAYERS AND COMPACT TO 80 - 85% OF THE MAXIMUM DRY DENSITY STANDARD PROCTOR.

WITHIN SIX MONTHS OF THE ESTIMATED DATE OF SUBSTANTIAL COMPLETION, PRUNE ALL DEAD OR HAZARDOUS BRANCHES LARGER THAN 2 INCH IN DIAMETER FROM ALL TREES TO REMAIN.

IMPLEMENT ALL PRUNING RECOMMENDATIONS FOUND IN THE ARBORIST REPORT PRUNE ANY LOW, HANGING BRANCHES AND VINES FROM EXISTING TREES AND SHRUBS THAT OVERHANG WALKS, STREETS AND DRIVES, OR PARKING AREAS AS FOLLOWS:

1. WALKS - WITHIN 8 FEET VERTICALLY OF THE PROPOSED WALK ELEVATION.

2. PARKING AREAS - WITHIN 12 FEET VERTICALLY OF THE PROPOSED PARKING SURFACE ELEVATION.

3. STREETS AND DRIVES - WITHIN 14 FEET VERTICALLY OF THE PROPOSED DRIVING SURFACE ELEVATION.

ALL PRUNING SHALL BE DONE IN ACCORDANCE WITH ANSI A300 (PART 1), ISA BMP TREE PRUNING (LATEST EDITION, AND THE "STRUCTURAL PRUNING: A GUIDE FOR THE GREEN INDUSTRY", EDWARD GILMAN, BRIAN KEMPF, NELDA MATHENY AND JIM CLARK, 2013 URBAN TREE FOUNDATION, VISALIA CA.

PERFORM OTHER PRUNING TASK AS INDICATED ON THE DRAWINGS OR REQUESTED BY THE OWNER'S REPRESENTATIVE. WHERE TREE SPECIFIC DISEASE VECTORS REQUIRE, STERILIZE ALL PRUNING TOOLS BETWEEN THE WORK IN INDIVIDUAL TREES.

GENERAL DRAWING SYMBOLS:

EXISTING WALL NEW CONCRETE BLOCK WALL 6" OR 8" NEW PLYCEM BOARD WALL

BEHIND AS INDICATED. DETAIL REFERENCE NUMBER

DETAIL REFERENCE SYMBOL - SHEET WHERE DETAIL IS DRAWN ELEVATION REFERENCE NUMBER

SHEET WHERE ELEVATION IS DRAWN

- SHEET WHERE WALL SECTION IS DRAWN

- SECTION REFERENCE NUMBER

GENERAL BUILDING SECTION - SHEET WHERE SECTION IS DRAWN - WALL SECTION REFERENCE NUMBER WALL SECTION

SHEET WHERE INT. ELEV. IS DRAWN INTERIOR ELVATION SYMBOL - ELEVATION REFERENCE NUMBER

NORTH ARROW

WINDOW SYMBO

KEY NOTE **EQUIPMENT SYMBO** LEVEL SYMBOL

RISER SYMBOL ROOM IDENTIFICATION

HANDICAPPED SYMBOL



ABBREVIATIONS:

F.F.L.

T.O.S.

AIR CONDITIONING ALUMINUM CENTER TO CENTER CONCRETE MASONRY UNIT CORRIDOR CORROSION ELEVATION FLOOR DRAIN FINISH FLOOR ELEVATIONS FINISH FLOOR LEVEL FINISH(ED) HARDWARE JANITOR CLOSE

MECHANICAL MINIMUM MOUNTED NOT IN CONTRA ROOF DRAIN REQUIRED SMOOTH CEMENT PLAST STAINLESS STEEL STORM SEWER

DROP MANHOLE

VERIFY IN FIELD

STRUCTURAL TOP OF MASONRY TOP OF STEEL TELEPHONE

FEBRUARY 21, 2024 UNLESS OTHERWISE NOTE



THIS DOCUMENT REPRESENTS THE IDEAS AND EFFORTS OF CSA ARCHITECTS AND ENGINEERS. IT SHALL BE USED ONLY BY AUTHORIZED PERSONS AND SHALL NOT BE REPRODUCED OR EXHIBITED WITHOUT WRITTEN CONSENT OF

CSA ARCHITECTS AND ENGINEERS.

PUERTO RICO INDUSTRIAL DEVELOPMENT COMPANY PRIDCO

ISSUE FOR BID

1							
С							
_	DISCIPLINE INFORMATION:						
	PRIME PROFESIONAL: ANNETTE ALFONSO						
	PROFESSIONAL OF RECORD:						
	ANNETTE ALFONSO						
	STAFF DES	IGNER:					
	JOHANI	NA SALCED	00				
	Q.C. AUDIT	OR:					
	PRINCIPAL	CAD TECHNICIA	·N·				

PROFESSIONAL'S STATEMENT: YO, ANNETTE ALFONSO CERTIFICO QUE SOY EL PROFESIONAL QUE ICONFECCIONÓ, DISEÑÓ O PREPARÓI ESTOS PLANOS

TAMBIÉN, CERTIFICO QUE ENTIENDO QUE DICHOS PLANOS Y ESPECIFICACIONES CUMPLEN CON LAS DISPOSICIONES APLICABLES DEL REGLAMENTO CONJUNTO Y LAS DISPOSICIONES APLICABLES DE LOS REGLAMENTOS Y CÓDIGOS DE CONSTRUCCIÓN VIGENTES DE LAS AGENCIAS. JUNTAS REGLAMENTADORAS O CORPORACIONES PÚBLICAS CON JURISDICCIÓN. CERTIFICO, ADEMÁS, QUE EN LAPREPARACIÓN DE ESTOS PLANOS Y ESPECIFICACIONES SE HA CUMPLIDO CABALMENTE CON LO DISPUESTO EN LA LEY NÚM. 14 DE 8 DE ENERO DE 2004, SEGÚN ENMENDADA, CONOCIDA COMO LA "LEY PARA LA INVERSIÓN POR LA INDUSTRIA PUERTORRIQUEÑA" Y CON LA [LEY NÚM. 319 DE 15 DE MAYO DE 1938, SEGÚN ENMENDADA; LEY NÚM. 96 DE 6 DE JULIO DE 1978, SEGÚN ENMENDADA: SEGÚN APLIQUEI, RECONOZCO QUE CUALQUIER DECLARACIÓN FALSA O FALSIFICACIÓN DE LOS HECHOS QUE SE HAYA PRODUCIDO POR DESCONOCIMIENTO O POR NEGLIGENCIA YA SEA POR MÍ, MIS AGENTES O EMPLEADOS, O POR OTRAS PERSONAS CON MI CONOCIMIENTO. ME HACEN RESPONSABLE DE CUALQUIER ACCIÓN JUDICIAL Y DISCIPLINARIA POR LA OGPE.

PRIDCO DAMAGE IMPROVEMENTS **NORTH REGION STAGE 1 BID PACKAGE N1-3** PW: 7801 / QUEBRADILLAS

SHEET TITLE:


GENERAL NOTES, ABBREVIATIONS AND LEGEND

AS SHOWN

DELIVERY DATE PROJECT NUMBER: 21-0258-02 PRINT DATE & TIME: BIM FILE NAME: 4/22/2024 3:28:33 PM

DRAWING / MODEL LOCATION:

CONSTRUCTION KEY NOTES SCHEDULE DI 219342 TYPE OF TECHNICAL DAMAGE **DESCRIPTION** DIMENSION QUANTITY DETAIL SPECIFICATIONS PHOTO. # ID 20 SF 092400 PA - Public Exterior, Wall: Assistance Remove loose cement plaster and prepare surface to THIS DOCUMENT REPRESENTS THE IDEAS AND EFFORTS OF **CSA ARCHITECTS AND ENGINEERS**. receive new IT SHALL BE USED ONLY BY AUTHORIZED PERSONS AND SHALL NOT BE REPRODUCED OR EXHIBITED cement plaster to WITHOUT WRITTEN CONSENT OF CSA ARCHITECTS AND ENGINEERS. match existing and prime and paint. PA - Public Exterior, Site: 100 LF L x 6 1/3DT502 323113 100 LF PUERTO RICO
INDUSTRIAL DEVELOPMENT COMPANY Assistance Remove and FT H PRIDCO dispose existing damaged material, install new chain **ISSUE FOR BID** link fence (Galv. Ga. No. 9, Post- 2 1/2" diam. galv., 3-strands barbed FEBRUARY 21, 2024 wire (4-point)) EV DATE DESCRIPTION 5 FT x 5 FT AD -Exterior, Roof: 1 EA 1/3DT501 233416 3 Additional 4/3DT501 Remove and Damages replace exhaust fan (aluminum roof fan extractor cap with gravity self acting back draft DISCIPLINE INFORMATION: damper face-flush ANNETTE ALFONSO install), 36in Fan ANNETTE ALFONSO Size, 1-HP Motor, JOHANNA SALCEDO 115/230V). Q.C. AUDITOR: 2/3DT501 AD -Exterior, Roof: 2 EA 233416 PRINCIPAL CAD TECHNICIAN: Installation of 3/3DT501 Additional PROFESSIONAL'S STATEMENT: equipment-anchori Damages YO, ANNETTE ALFONSO ng assembly to protect exhaust NUM. LIC. 12304 fans from high CERTIFICO QUE SOY EL PROFESIONAL QUE [CONFECCIONÓ, DISEÑÓ O PREPARÓ] ESTOS PLANOS wind pressure. TAMBIÉN, CERTIFICO QUE ENTIENDO QUE DICHOS PLANOS Y ESPECIFICACIONES CUMPLEN CON LAS AD -6 EA 085113 Exterior, Wall: DISPOSICIONES APLICABLES DEL REGLAMENTO Remove damaged CONJUNTO Y LAS DISPOSICIONES APLICABLES DE Additional LOS REGLAMENTOS Y CÓDIGOS DE CONSTRUCCIÓN VIGENTES DE LAS AGENCIAS, JUNTAS Damages material and install REGLAMENTADORAS O CORPORACIONES PÚBLICAS CON JURISDICCIÓN. CERTIFICO, ADEMÁS, QUE EN new aluminum LAPREPARACIÓN DE ESTOS PLANOS Y ESPECIFICACIONES SE HA CUMPLIDO CABALMENTE jalousie window CON LO DISPUESTO EN LA LEY NÚM. 14 DE 8 DE ENERO DE 2004, SEGÚN ENMENDADA, CONOCIDA operator. COMO LA "LEY PARA LA INVERSIÓN POR LA INDUSTRIA PUERTORRIQUEÑA" Y CON LA [LEY NÚM. 319 DE 15 DE MAYO DE 1938, SEGÚN ENMENDADA; B LEY NÚM. 96 DE 6 DE JULIO DE 1978, SEGÚN 4 FT L x 4 FT | 0.30 CYD AD -030130 Interior, Wall: ENMENDADA; SEGÚN APLIQUE]. RECONOZCO QUE CUALQUIER DECLARACIÓN FALSA O FALSIFICACIÓN Additional Repair Mortar DE LOS HECHOS QUE SE HAYA PRODUCIDO POR DESCONOCIMIENTO O POR NEGLIGENCIA YA SEA System Shrinkage Damages POR MÍ, MIS AGENTES O EMPLEADOS, O POR OTRAS PERSONAS CON MI CONOCIMIENTO, ME HACEN Compensated RESPONSABLE DE CUALQUIER ACCIÓN JUDICIAL Y DISCIPLINARIA POR LA OGPE. Repair Mortar PRIDCO DAMAGE IMPROVEMENTS **NORTH REGION STAGE 1** NOTE: SEE GENERAL NOTES, ITEM #7 IN 3GI002 **BID PACKAGE N1-3** PW: 7801 / QUEBRADILLAS 2 SITE PLAN DI 219342 1 / DT501 DETAIL NUMBER SHEET WHERE **DETAIL RESIDES** 009-081-050-27-001 DESCRIPCION GENERAL SHEET TITLE: ela: 009-081-050-27 ño: WHOLESALE ELECTRIC CARIBE INC BO SAN JOSE , CARR 2, PR, Puerto Rico, SITE PLAN BUILDING 00000, Quebradillas T102907000 DI 219342 de mapa: 6437.29 m2 VALORACION **AS SHOWN** DELIVERY DATE: PROJECT NUMBER: 21-0258-02 PRINT DATE & TIME: BIM FILE NAME: 4/22/2024 3:28:34 PM DRAWING / MODEL LOCATION: **KEY PLAN DI 219342** 3AE101

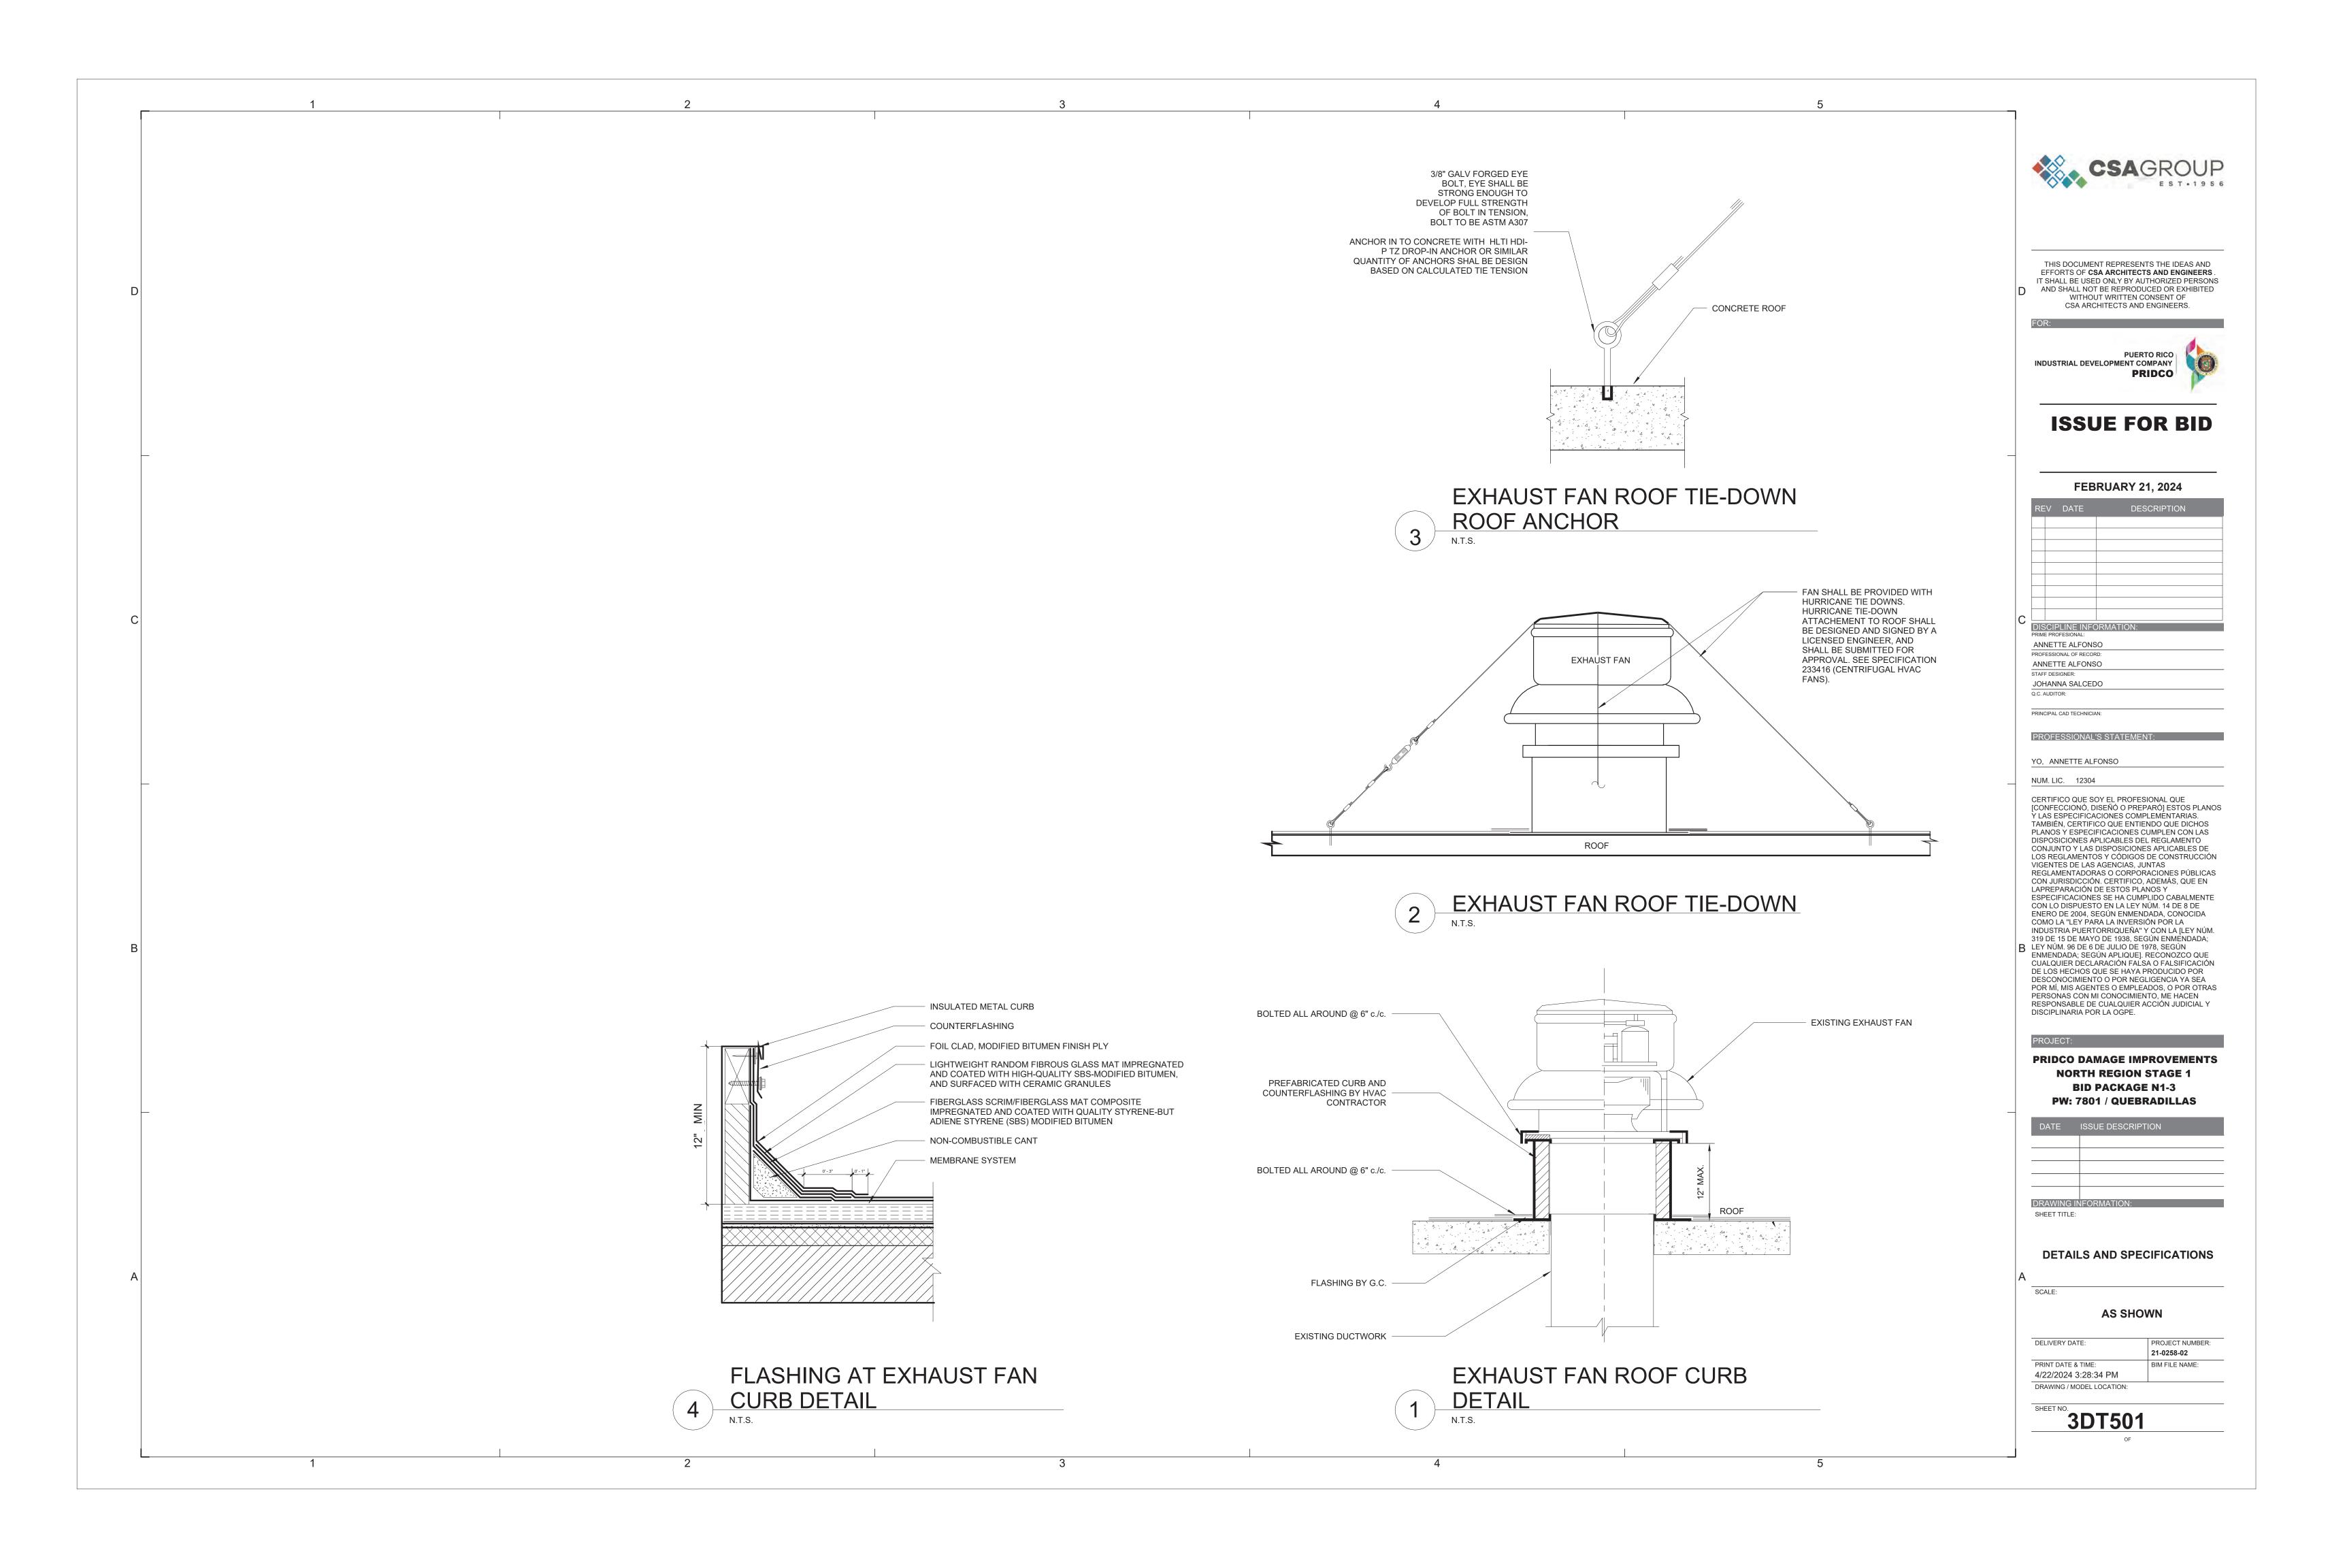

ACORN TOP


TOP RAIL

ALUM TOP
RAIL OR
POSTS TIES

BRACE END

BRACE ROD
AND
TURNBUCKLE


TENSION BAR

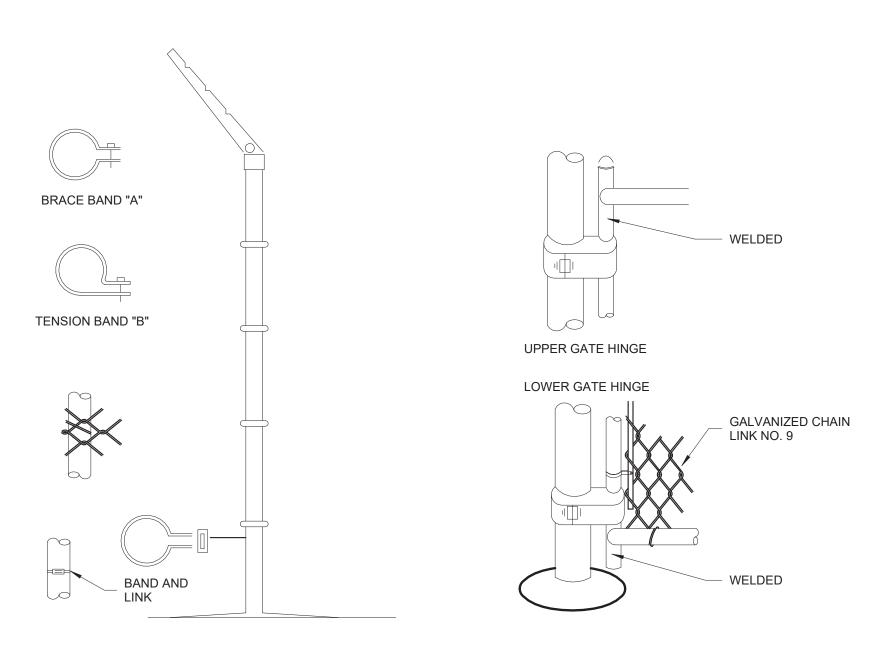

INSTALLATION DETAILS FOR CHAIN LINK FENCE & GATES

NOTES:

- 1. CHAIN LINK FENCE INDUSTRIAL TYPE NO.423
- 2. LINE POSTS 2 1/2" O.D. GALV. STD.WEIGHT PIPE-3.85 LBS. PER LIN. FT.
- 3. TOP RAIL 1 5/8" O.D. GALV. STD.WEIGHT PIPE-2.27 LBS. PER LIN. FT. (GATE FRAME IDEM.)
- 4. CORNER POST 3"∅ O.D. GALV. STD. WEIGHT PIPE 6.79 LBS. PER LIN. FT.
- 5. TENSION WIRE GA. NO.7 GALVANIZED
- 6. GATE POST 4"O.D. GALV. STD. WEIGHT PIPE 9.10 LBS. PER LIN. FT.
- 7. GALVANIZED CHAIN LINK GA. 9-2"X2"-1.2 OUNCES GALVANIZED AFTER WOOVEN.
- 8. STD. WEIGHT PIPE, SCHEDULE 40A. 120
- 9. TUBULAR STEEL PIPE SHALL BE INSTALLED EVERY 50'- 0" PANEL SPAN (SPAN = 10'- 0")
 TUBULAR STEEL PIPE SHALL BE INSTALLED EVERY DIRECTIONS CHANGE IN THE FENCE
 TUBULAR STEEL PIPE SHALL BE INSTALLED AT EACH FENCE END PANEL.
- 10. ALL FITTINGS EXTRA HEAVY DUTY
- 11. MILL CERTIFICATE SHALL BE SUBMITTED.

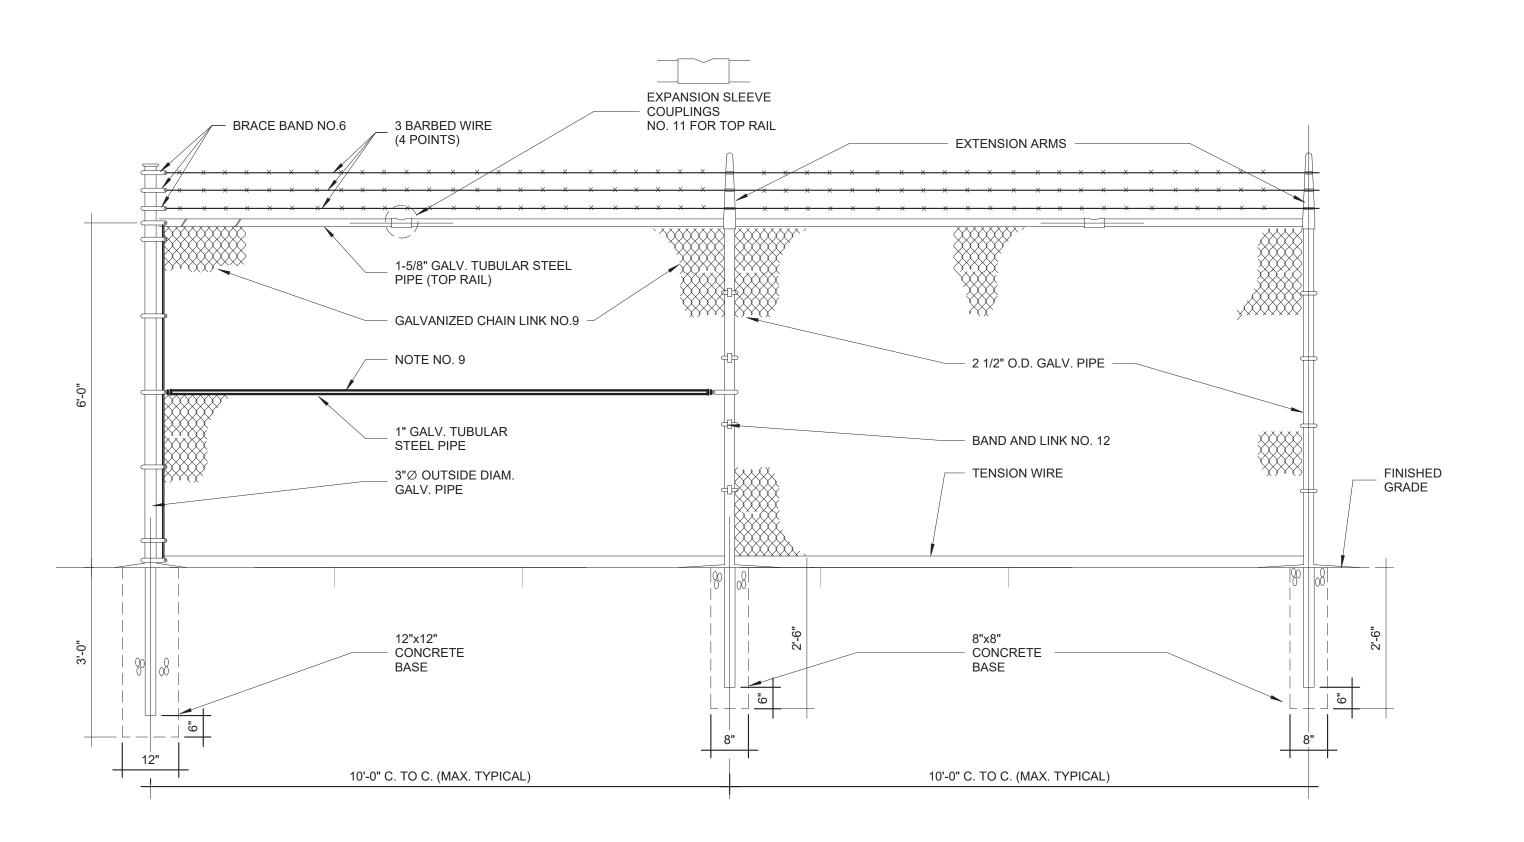

CHAIN LINK FENCE PARTIAL ELEVATION (ALONG PROPERTY LIMITS)





THIS DOCUMENT REPRESENTS THE IDEAS AND EFFORTS OF **CSA ARCHITECTS AND ENGINEERS**. IT SHALL BE USED ONLY BY AUTHORIZED PERSONS AND SHALL NOT BE REPRODUCED OR EXHIBITED WITHOUT WRITTEN CONSENT OF CSA ARCHITECTS AND ENGINEERS.

PUERTO RICO
INDUSTRIAL DEVELOPMENT COMPANY
PRIDCO

ISSUE FOR BID

FEBRUARY 21, 2024

F	REV	DATE	DESCRIPTION
	_		
-	-		
	+		
С			
	ISCI	PLINE INFO	RMATION:

DISCIPLINE INFORMATIO PRIME PROFESIONAL:

ANNETTE ALFONSO
PROFESSIONAL OF RECORD:
ANNETTE ALFONSO
STAFF DESIGNER:
JOHANNA SALCEDO

PRINCIPAL CAD TECHNICIAN:

PROFESSIONAL'S STATEMENT:

YO, ANNETTE ALFONSO

____NUM. LIC. 12304

CERTIFICO QUE SOY EL PROFESIONAL QUE [CONFECCIONÓ, DISEÑÓ O PREPARÓ] ESTOS PLANOS VI AS ESDECIEICACIONES COMDI EMĒNI TAMBIÉN, CERTIFICO QUE ENTIENDO QUE DICHOS PLANOS Y ESPECIFICACIONES CUMPLEN CON LAS DISPOSICIONES APLICABLES DEL REGLAMENTO CONJUNTO Y LAS DISPOSICIONES APLICABLES DE LOS REGLAMENTOS Y CÓDIGOS DE CONSTRUCCIÓN VIGENTES DE LAS AGENCIAS, JUNTAS REGLAMENTADORAS O CORPORACIONES PÚBLICAS CON JURISDICCIÓN. CERTIFICO, ADEMÁS, QUE EN LAPREPARACIÓN DE ESTOS PLANOS Y ESPECIFICACIONES SE HA CUMPLIDO CABALMENTE CON LO DISPUESTO EN LA LEY NÚM. 14 DE 8 DE ENERO DE 2004, SEGÚN ENMENDADA, CONOCIDA COMO LA "LEY PARA LA INVERSIÓN POR LA INDUSTRIA PUERTORRIQUEÑA" Y CON LA [LEY NÚM. 319 DE 15 DE MAYO DE 1938, SEGÚN ENMENDADA; B LEY NÚM. 96 DE 6 DE JULIO DE 1978, SEGÚN ENMENDADA; SEGÚN APLIQUE]. RECONOZCO QUE CUALQUIER DECLARACIÓN FALSA O FALSIFICACIÓN DE LOS HECHOS QUE SE HAYA PRODUCIDO POR DESCONOCIMIENTO O POR NEGLIGENCIA YA SEA POR MÍ, MIS AGENTES O EMPLEADOS, O POR OTRAS PERSONAS CON MI CONOCIMIENTO, ME HACEN RESPONSABLE DE CUALQUIER ACCIÓN JUDICIAL Y DISCIPLINARIA POR LA OGPE.

PRIDCO DAMAGE IMPROVEMENTS NORTH REGION STAGE 1

BID PACKAGE N1-3 PW: 7801 / QUEBRADILLAS

DATE	ISSUE DESCRIPTION
DRAWING IN	FORMATION:
SHEET TITLE:	

DETAILS AND SPECIFICATIONS

AC CHC


AS SHOWN

ELIVERY DATE: PROJECT NUMBER:

21-0258-02

PRINT DATE & TIME: BIM FILE NAME: 4/22/2024 3:28:35 PM


DRAWING / MODEL LOCATION:

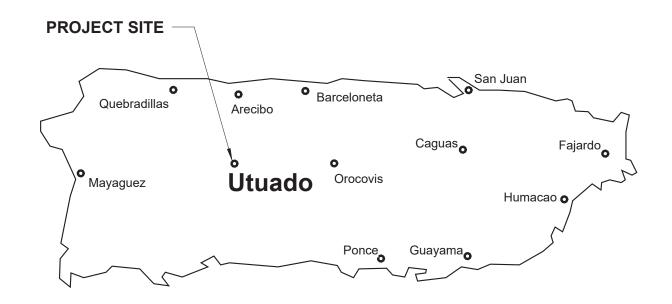



INDEX OF DRAWINGS - PW 8067, DI 219458

COVER SHEET - DI 219458

DETAILS AND SPECIFICATIONS
DETAILS AND SPECIFICATIONS
DETAILS AND SPECIFICATIONS

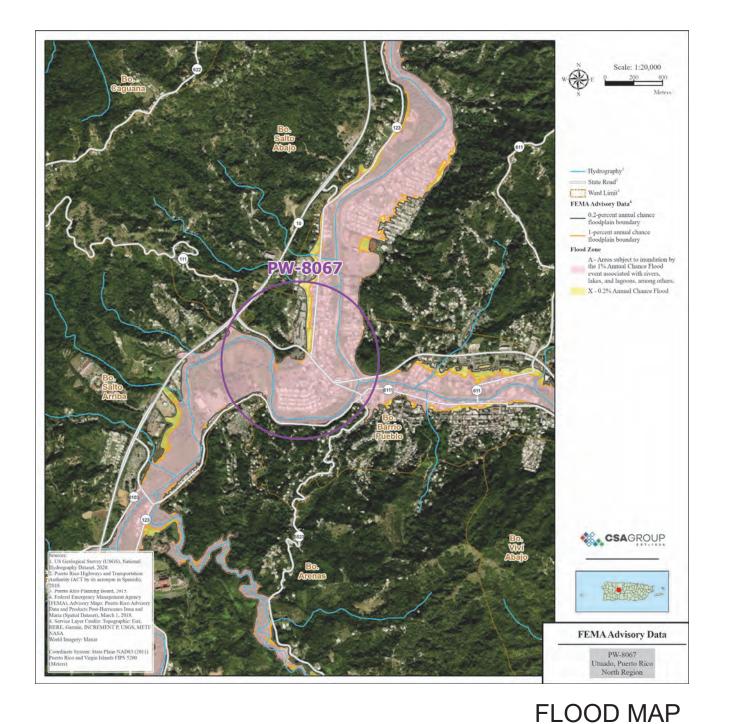

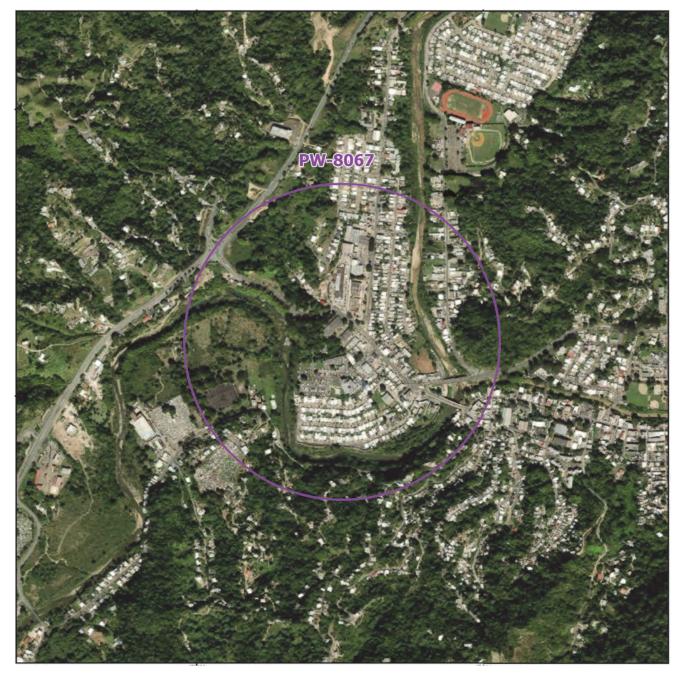

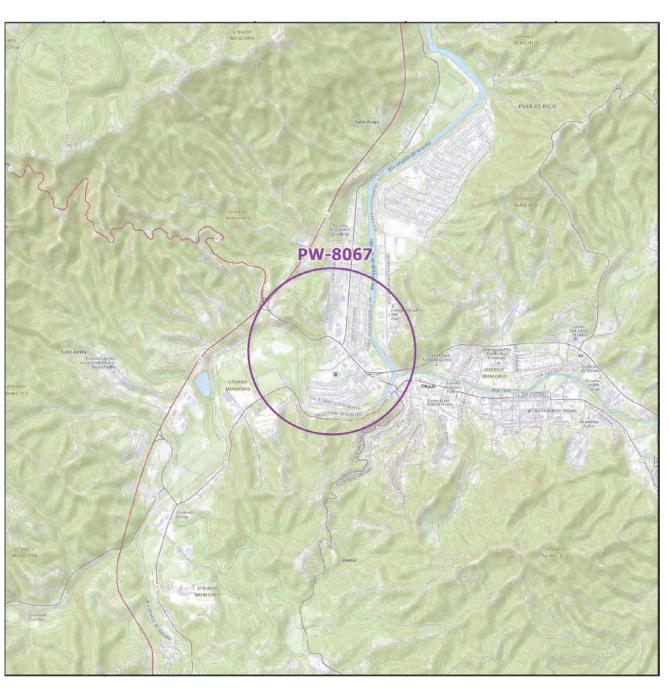

LOCATION MAP SCALE 1:20,000

NORTH REGION STAGE 1 BID PACKAGE N1-3 PRIDCO-FEMA 4339 DR PROGRAM

AERIAL PHOTO

REPAIR AND IMPROVEMENTS OF INDUSTRIAL BUILDINGS OF THE PUERTO RICO INDUSTRIAL DEVELOPMENT COMPANY FOR THE:


4. PW: 8067 / DI: 219458 / Bldg: T089406700 / Mun: Utuado










COVER SHEE	T PW 8067
SCALE:	
AS SH	OWN
DELIVERY DATE:	PROJECT NUMBER 21-0258-02
PRINT DATE & TIME: 4/22/2024 3:28:36 PM	BIM FILE NAME:
DRAWING / MODEL LOCATION:	L

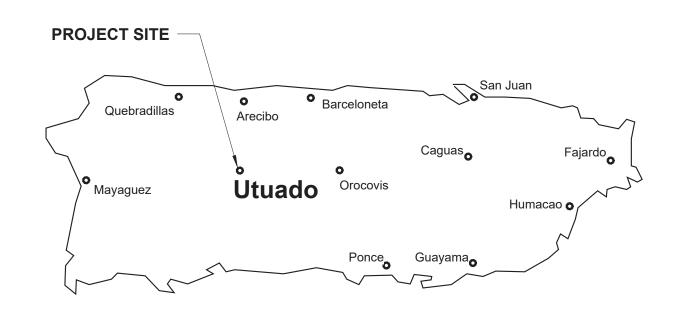

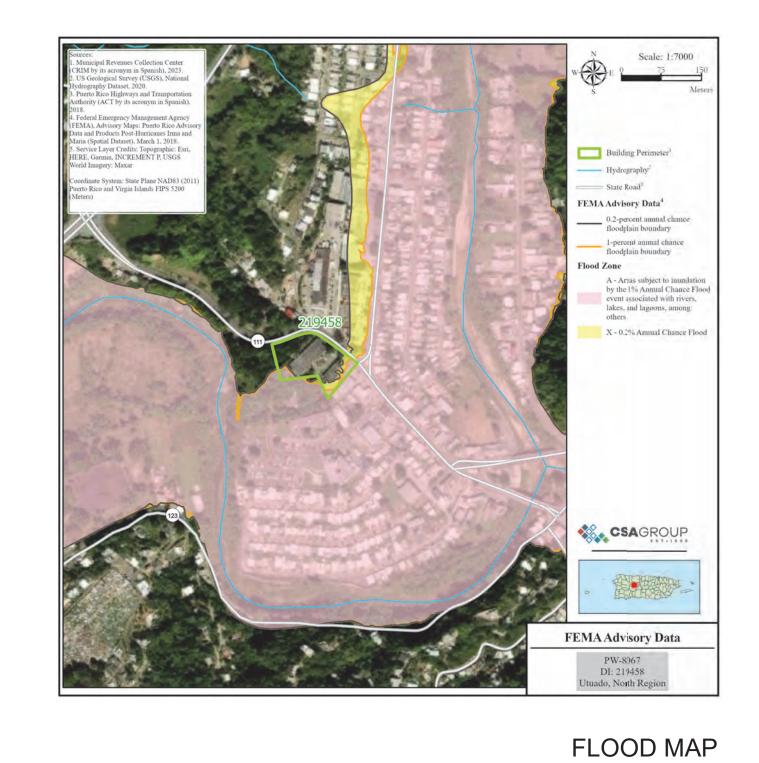

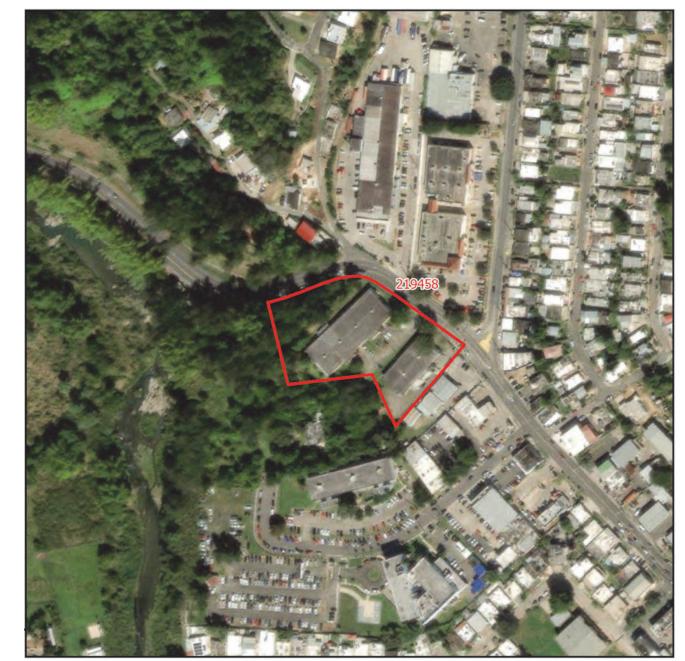

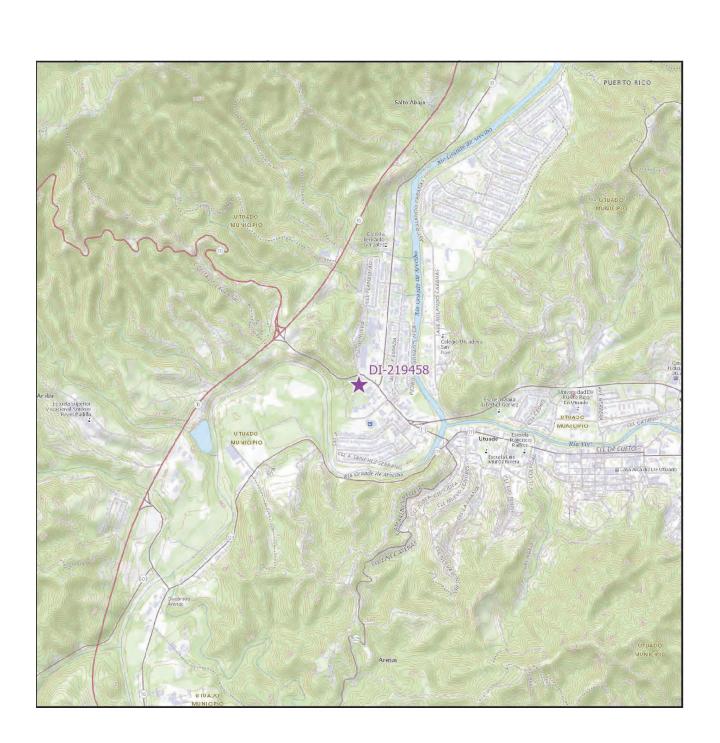

AERIAL PHOTO 18.269000, -66.712558


LOCATION MAP SCALE 1: 20,000

INDEX OF DRAWINGS - PW 8067, DI 219458						
	Sheet	Current				
Discipline	Number	Revision	Sheet Name			
00-GENERAL	4GI001		COVER SHEET - DI 219458			
00-GENERAL	4GI002		GENERAL NOTES, ABBREVIATIONS AND LEGEND			
03-ARCHITECTURAL	4AE101		SITE PLAN BUILDING T089406700 DI 219458			
05-DETAILS	4DT501		DETAILS AND SPECIFICATIONS			
05-DETAILS	4DT502		DETAILS AND SPECIFICATIONS			
05-DETAILS	4DT503		DETAILS AND SPECIFICATIONS			

PRIDCO-FEMA 4339 DR PROGRAM NORTH REGION STAGE 1 BID PACKAGE N1-3

4. PW: 8067 | DI: 219458 | Bldg: T089406700

Road PR-11, Km 0.1, Salto Abajo, Utuado, PR 00641

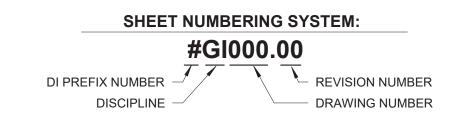





COVER SHEE	T - DI 219458
SCALE:	
AS SI	HOWN
DELIVERY DATE:	PROJECT NUMBER 21-0258-02
PRINT DATE & TIME: 4/22/2024 3:28:37 PM	BIM FILE NAME:

GENERAL NOTES

CALLED FOR IN SAID CODES COMPLY WITH APPLICABLE RULES AND REGULATIONS FOR OBTAINING NECESSARY AND REQUIRED INSPECTIONS, APPROVALS AND PERMITS

NECESSARY TO PERFORM WORK AND SERVICES FOR THE PROJECT. EXECUTE WORK IN ACCORDANCE WITH THE BEST ACCEPTED TRADE PRACTICES, AS PER MANUFACTURER'S WRITTEN RECOMMENDATIONS, AND IN A CAREFUL AND ORDERLY MANNER WITH THE LEAST POSSIBLE NOISE, DUST, OR DISTURBANCE TO OCCUPANTS

IMPLEMENT SAFETY CONTROLS DURING DEMOLITION/CONSTRUCTION

DAILY REMOVE DEBRIS RESULTING FROM DEMOLITION/CONSTRUCTION AND TRANSPORT IT OUT OF PROJECT LIMITS. PERFORM DISPOSAL OPERATION IN ACCORDANCE WITH GOVERNMENT APPROVALS AND REGULATIONS. SITE AND STRUCTURE SHALL BE LEFT BROOM CLEAN FOR SUBSTANTIAL COMPLETION.

DO NOT SCALE DRAWINGS. VERIFY DIMENSIONS IN THE FIELD BEFORE PROCEDING WITH ANY PORTION OF THE WORK. ADVISE IN WRITING TO CONSTRUCTION MANAGER AND ARCHITECT OF DISCREPANCY BETWEEN **EXISTING CONDITIONS AND DRAWINGS**

REPORT TO CONSTRUCTION MANAGER AND ARCHITECT DISCREPANCIES IN THE CONTRACT DRAWINGS, SPECIFICATIONS OR DETAILS PRIOR TO COMMENCING THE WORK.

COORDINATE CIVIL, MECHANICAL, ELECTRICAL, ARCHITECTURAL AND STRUCTURAL REQUIREMENTS FOR PROPER LOCATION AND PROVISIONS OF SLEEVES, INSERTS, OPENINGS AND ROUGH-IN REQUIRED CONDUCT DEMOLITION/CONSTRUCTION OPERATION TO INSURE MINIMUM

INTERFERENCE WITH ROADS, STREETS, SIDEWALKS AND OTHER ADJACENT FACILITIES THE USE OF A BRAND NAME AND/OR MODEL NUMBER TO DENOTE PRODUCTS, EQUIPMENTS, MATERIALS, OR PROCESS, IS INTENDED TO ESTABLISH A STANDARD OF QUALITY AND SHALL NOT BE CONSTRUED AS

LIMITING COMPETITION. DO NOT COMMENCE ANY DEMOLITION OF SITE ELEMENTS OR STRUCTURE UNTIL THE HAZARDOUS MATERIAL ABATEMENT IS DONE AND EPA CERTIFICATION IS OBTAINED, STATING THAT THE SITE ELEMENTS AND STRUCTURES ARE FREE OF HAZARDOUS MATERIALS. PRIOR TO COMMENCEMENT OF THE HAZARDOUS MATERIAL ABATEMENT THE BUILDING AND SITE SHALL BE VACANT.

SPECIFIED TREE PRUNING OR CUTTING OR INCIDENTAL TO OTHER REPAIR WORK MAY REQUIRE A DRNA PERMIT. THE CONTRACTOR IS RESPONSIBLE FOR OBTAINING PERMIT BEFORE PERFORMING THE WORK.

PRESSURE WASH, MINIMUM 3,000 PSI, EXISTING BUILDING EXTERIOR

WALLS, WINDOWS, AND DOORS BEFORE BEGINNING SPECIFIED WORK. REPAIR INTERIOR AND EXTERIOR WALL SURFACES WITH CEMENT PLASTER PRIOR TO APPLYING PAINT FINISH. REPAIR WORK INCLUDES, BUT IS NOT LIMITED TO CUT AND PATCHING, REMOVAL OF NAILS AND SCREWS FROM WALLS, REPAIR OF MAJOR IMPERFECTIONS ON

WALLS AND FINISHES IN GENERAL FULL TEAR-OFF OF ROOF WATERPROOFING SYSTEM INCLUDING MEMBRANE, INSULATION AND FLASHINGS WHERE SYSTEM REPLACEMENT IS SPECIFIED. A ROOF MOISTURE SURVEY MAY BE REQUIRED PRIOR TO INSTALLATION OF NEW MEMBRANE

CLEAN, REPAIR AND VERIFY STRUCTURAL INTEGRITY OF ROOF DECK PRIOR THE INSTALLATION OF THE WATERPROOFING SYSTEM. COMPLY WITH THE MANUFACTURER RECOMMENDATIONS FOR THE INSTALLATION OF ROOF MEMBRANE TO VALIDATE THE WARRANTY.

ELECTRICAL GENERAL NOTES

INDICATED

NO WIRE SHALL BE SMALLER THAN # 12 AWG THHN, 600 VOLTS. NO CONDUIT SHALL BE SMALLER THAN 3/4" ALL CONDUIT SHALL BE RIGID GALVANIZED EXCEPT OTHERWISE

ALL WIRE SHALL BE COPPER, INSULATED AS NOTED. LEAVE A #12 AWG GALVANIZED FISH WIRE IN ALL EMPTY CONDUITS.

ALL UNDERGROUND CONDUITS SHALL BE PROTECTED WITH 4" CONCRETE ENVELOPE EXPANSION FITTINGS SHALL BE USED FOR EVERY CONDUIT CROSSING

BUILDING EXPANSION JOINTS. CONTRACTOR SHALL BALANCE ALL LOADS

PROVIDE A #12 GREEN THW BONDING JUMPER BETWEEN EACH OUTLET BOX AND RECEPTACLE GROUNDING TERMINAL, USE 3/8" LONG 10-32 GROUNDING SCREW

ALL INSTALLATIONS SHALL BE EXPOSED UNLESS OTHERWISE INDICATED. EXPOSED CONDUITS SHALL BE SUPPORTED BY MEANS OF ONE BOLT CLAMP SPACED NOT FURTHER THAN 7'-6" APART. AN EXPOSED WORK CONDULET SHALL BE USED FOR ALL 90 BENDS.

ALL NON-GALVANIZED METAL PARTS SHALL BE GIVEN ONE COAT OF RED OXIDE AND TWO COATS OF METALLIC GRAY PRIOR TO INSTALLATION.

ALL GALVANIZED RIGID CONDUITS FOR TOGGLE SWITCHES AND RECEPTACLES LOCATED AT DOORWAYS AND LEAN - TO SHALL BE CONCEALED WITHIN ROOF SLAB, WALLS AND OVERHANGS. CONTRACTOR SHALL PROVIDE ELECTRICAL SERVICE TO TEST ALL

ELECTRICAL SYSTEM IN PRESENCE OF THE REPRESENTATIVE FROM THE MECHANICAL AND ELECTRICAL DEPARTMENT ALL LIGHTING CIRCUITS SHALL HAVE ONE (1) PORCELAIN LIGHT SOCKET

WITH A LED TYPE BULB, EQUIVALENT TO 100W INCANDESCENT LUMENS. SWITCHES AND RECEPTACLES SHALL BE INSTALLED 4'-0" A.F.F. THE NEUTRAL WIRES SHALL BE IDENTIFIED THROUGHT THE INSTALLATION

BY THE USE OF WHITE COLOR COVERED LIVE WIRES WITHIN THE SAME CONDUIT SHALL BE COLOR CODED AS PER N.E.C. RECEPTACLES AND LIGHTING CIRCUITS SHALL BE #12 THHN WIRE AND

SHALL BE CONNECTED TO 20 AMP BREAKERS AT THE PANELBOARD. ALL OVERHANGS AND LEAN - TO'S SHALL BE PROVIDED WITH LIGHT SOCKETS

CONTRACTOR SHALL VERIFY LENGTH OF FEEDERS IN THE FIELD BEFORE SUBMITTING BIDS

ALL SWITCHES AND RECEPTACLES THAT ARE CONCEALED IN WALLS AND OVERHANGS SHALL BE PROVIDED WITH STAINLESS STEEL COVERS. CONTRACTOR SHALL CONTACT THE DISTRICT ENGINEER OF LUMA PRIOR | 12. TO THE BEGINNING OF THE WORK AND COORDINATE WITH THEM FOR THE EXECUTION OF THE WORK CONCERNING THE SERVICE ENTRANCE AND SUBSTATION IF REQUIRED. IN ADDITION, THE CONTRACTOR SHALL OBTAIN | 13. A CERTIFICATE OF INSPECTION AT THE COMPLETION OF THE WORK AND SHALL FORWARD IT TO THE PUERTO RICO INDUSTRIAL DEVELOPMENT

ALL INSTALLATIONS SHALL BE IN ACCORDANCE WITH THE LATEST RULES AND REGULATIONS OF THE N.E.C. AND LUMA

ALL BOXES FOR RECEPTACLES & LIGHTING SWITCHES FOR EXPOSED INSTALLATION SHALL BE "FS" TYPE.

CONTRACTOR SHALL SUBMIT A LIST OF MATERIALS AND EQUIPMENT GIVING MANUFACTURER CATALOG NUMBERS AND COMPLETE SPECIFICATIONS AND DRAWINGS FOR APPROVAL OF P.R.I.D.C.O. PRIOR TO THE PURCHASING OF SAID MATERIALS AND/OR EQUIPMENT.

PLUMBING GENERAL NOTES:

PLUMBING SHALL BE IN STRICT ACCORDANCE WITH THE 2018 PUERTO RICO BUILDING CODE.

FURNISH AND SET IN PLACE BEFORE CONCRETE POURING ALL NECESSARY SLEEVES FOR WASTE OR SOIL, VENT, HOT, AND COLD WATER LINES, THESE SLEEVES SHALL BE AS SPECIFIED OR REQUIRED BY THE

THE PLUMBING DRAWING IS GENERALLY DIAGRAMATTIC AND INDICATIVE OF THE WORK TO BE INSTALLED. RUN ALL PIPING CONCEALED WHEREVER POSSIBLE UNLESS OTHERWISE NOTED.

SIZES SHOWN IN FIXTURE SCHEDULE ARE MINIMUM AND SHALL BE INCREASED AS NECESSARY TO COMPLY WITH CODE REQUIREMENTS OR AS SHOWN ON DRAWINGS.

BEFORE CONSTRUCTION VERIFY EXISTING ELEVATIONS AGAINST PROPOSED SLOPES. ANY DISCREPANCIES SHALL BE BROUGHT TO THE ATTENTION OF THE ARCHITECT.

CLEANOUT SHALL BE OF SAME SIZE AS THE PIPES TO WHICH THEY ARE CONNECTED UP TO 4", FOR LARGE

UNLESS OTHERWISE INDICATED, ALL DRAINAGE PIPING 3" AND SMALLER SHALL BE SLOPED 1/4" PER FT., LARGER

CLEANOUT SHALL BE NOT MORE THAN 50 FEET AP-ART IN HORIZONTAL DRAINAGE LINES OF 4" NOMINAL DIAMETER OR LESS AND NOT MORE THAN 100 FEET APART FOR LARGER PIPES.

FOR FIXTURES AND EQUIPMENT NOT LISTED IN SCHEDULE, SEE CONTRACT SPECIFICATIONS.

DETERMINE EXACT LOCATION OF THE PIPING TO AVOID ANY INTERFERENCE WITH PIPING AND/OR EQUIPMENT BEING INSTALLED BY ANOTHER SUB-CONTRACTOR.

SANITARY TEES (SINGLE AND DOUBLE) AND QUARTER BENDS SHALL BE ACCEPTABLE ONLY FOR CHANGES OF DIRECTION FROM HORIZONTAL TO VERTICAL

USE LONG SWEEPING FITTINGS AND/OR LONG SWEEP BENDS AT BASE OF ALL STACKS.

PROVIDE ROUGHING-IN AND INSTALL ALL PLUMBING FIXTURES AND/OR EQUIPMENT WHICH ARE SUPPLIED BY

FOR ALL UNDERGROUND SANITARY AND STORM DRAINAGE USE: PVC POLYVINYL CHLORIDE) SEWER PIPE AND FITTING: ASTM D 3034, SDR-35, FOR SOLVENT CEMENT OR ELASTOMERIC GASKET JOINTS. A. SOLVENT CEMENT: ASTM D 2564 B. GASKETS: ASTM F 477, ELASTOMERIC SEAL.

PROVIDE ALL PIPE OPENINGS THROUGH SLABS WITH SLEEVES HAVING AN INTERNAL DIAMETER AT LEAST 1" LARGER THAN THE OUTSIDE DIAMETER OF UN-INSULATED PIPES OR OF THE INSULATION FOR INSULATION SERVICES. FLOOR SLEEVES ARE TO PROJECT 2" ABOVE FINISHED FLOORS.

SLEEVES SHALL BE SCHEDULES 40 GALVANIZED STEEL PIPE.

BOTTOM OF THE WATER SERVICES LINE SHALL BE 12 INCHES ABOVE THE HIGHEST POINT OF THE SEWER LINE WHENEVER THE HORIZONTAL DISTANCE BETWEEN THEM IS LESS THAN 5 FT.

PROVIDE DOWNSPOUT NOZZLES (SIMILAR TO JAY R. SMITH FIG 1770) AT THE OVERFLOW RAIN WATER OUTLETS,

CONTRACTOR SHALL SUPPLY AND INSTALL 1/4 TURN SHUT OFF VALVES AT EVERY PLUMBING FIXTURE.

ALL PLUMBING FIXTURES, COLORS AND FINISHES, SELECTION BY ARCHITECT

HVAC GENERAL NOTES:

SUPPLY AND INSTALL ALL ELECTRICAL CONTROLS, SAFETY SWITCHES AND ACCESSORIES NOT INDICATED IN THE ELECTRICAL DRAWING AND NECESSARY FOR THE PROPER OPERATION OF THE EQUIPMENT IN ACCORDANCE WITH THE MECHANICAL EQUIPMENT RECOMMENDATIONS AND THE NATIONAL ELECTRIC CODE.

PERFORM ALL WIRING AND CONNECTION (POWER AND CONTROL) NOT INDICATED IN THE ELECTRICAL DRAWINGS AND NECESSARY FOR THE PROPER OPERATION OF THE MECHANICAL EQUIPMENT IN STRICT ACCORDANCE WITH THE NATIONAL ELECTRIC CODE

TAKE EVERY PRECAUTION IN ORDER TO MINIMIZE OR ELIMINATE THE TRANSMISSION OF NOISE OR VIBRATION FROM THE EQUIPMENT, PIPING SYSTEM OR DUCT SYSTEM TO THE CONDITIONING SPACE.

EQUIPMENT, MATERIALS AND ACCESSORIES SHALL BE SIMILAR TO THE INDICATED SPECIFICATION AND/OR MANUFACTURER MODEL OR CATALOG NUMBER.

UNLESS OTHERWISE NOTED IN DRAWINGS AND/OR SPECIFICATIONS ALL EQUIPMENT AND ACCESSORIES SHALL BE FURNISHED AND INSTALLED BY THE CONTRACTOR.

CIVIL SITE GENERAL NOTES

ALL DISTANCES AND ELEVATIONS ARE EXPRESSED IN METERS UNLESS OTHERWISE SPECIFIED. ELEVATIONS ARE REFERRED TO MEAN SEA LEVEL.

COORDINATES ARE BASED ON THE LAMBERT PROJECTION FOR PUERTO RICO AND THE US VIRGIN ISLAND AND REFERENCED TO THE NORTH AMERICAN DATUM OF 1983 (NAD83 NA2011) EPOCH 2010.00 ADJUSTED IN

THE CONTRACTOR SHALL COORDINATE WITH THE CONSTRUCTION MANAGER BEFORE CUTTING OR

TRIMMING EXISTING TREES AFFECTED BY THE CONSTRUCTION. THE CONTRACTOR SHALL PREPARE AND SUBMIT FOR EACH PROJECT AREA, THE CONTROL OF EROSION AND SEDIMENTATION (CES) PLAN FOR APPROVAL BY THE PERTINENT AGENCY AND THE CONSTRUCTION MANAGER.

THE CONTRACTOR SHALL PROVIDE AND MAINTAIN A DEWATERING SYSTEM TO KEEP SUBGRADES DRY AND CONVEY GROUND WATER AWAY FROM EXCAVATIONS. THE DEWATERING PLAN SHALL BE SUBMITTED TO THE CONSTRUCTION MANAGER FOR APPROVAL AND COORDINATION. DEWATERING PLANS SHALL INCLUDE CONTROL OF EROSION AND SEDIMENTATION FOR EACH PROJECT

PHASE AND/OR WORK AREA. THE WATER FROM THE DEWATERING SYSTEM SHALL BE FREE OF SEDIMENT AND/OR DEBRIS BEFORE ANY DISPOSAL. THE CONTRACTOR SHALL MAINTAIN THE DEWATERING SYSTEM UNTIL DEWATERING IS NO LONGER

ELECTRICAL, COMMUNICATION, SANITARY AND POTABLE WATER SERVICE SHALL NOT BE INTERRUPTED DURING CONSTRUCTION. IF NECESSARY, A PROVISIONAL TEMPORARY SERVICE AND/OR BY-PASS SHALL BE INSTALLED TO MAINTAIN SERVICE. PROVISIONAL TEMPORARY SERVICE AND/OR BY-PASS SHALL BE SUBMITTED TO THE CONSTRUCTION MANAGER FOR APPROVAL AND COORDINATION PRIOR TO CONSTRUCTION. THE CONTRACTOR SHALL PREPARE AND SUBMIT THE MAINTENANCE OF SERVICE PLAN FOR ELECTRICAL

SANITARY AND POTABLE WATER FOR APPROVAL OF THE CONSTRUCTION MANAGER. THE CONTRACTOR SHALL NOTIFY THE CONSTRUCTION MANAGER IF ANY ELEMENT SUSPECTED OF CONTAINING HAZARDOUS MATERIAL IS ENCOUNTERED, PRIOR TO ANY RELATED WORK ACTIVITY. THE CONTRACTOR SHALL VISIT THE PROJECT AREA TO VERIFY THE SPACE LIMITATIONS FOR CONSTRUCTION

PROCESS AND EQUIPMENT. THE CONTRACT PRICE SHALL CONSIDER THE REQUIRED CONSTRUCTION PROCESS AND/OR EQUIPMENTS. PRIOR TO COMMENCEMENT OF THE WORK, CONTRACTOR SHALL VERIFY ALL DIMENSIONS AND EXISTING CONDITIONS AT PROJECT SITE AND SHALL NOTIFY THE CONSTRUCTION MANAGER OF ANY DISCREPANCIES BETWEEN EXISTING CONDITIONS AND CONTRACT DOCUMENTS THAT COULD AFFECT CONSTRUCTION WORK

SCHEDULE AND /OR PERFORMANCE ALL DETAILS, SECTIONS AND NOTES SHOWN ON DRAWINGS ARE INTENDED TO BE TYPICAL AND SHALL APPLY TO

SIMILAR SITUATIONS ELSEWHERE UNLESS OTHERWISE NOTED. THE CONTRACTOR SHALL REPAIR OR REPLACE EXISTING FACILITIES DAMAGED DURING CONSTRUCTION PRIOR TO SUBSTANTIAL COMPLETION

THE CONTRACTOR SHALL MAINTAIN IN OPERATION EXISTING FACILITIES UNTIL NEW FACILITIES ARE IN OPERATION.

GENERAL STRUCTURAL NOTES

STRUCTURAL BUILDING AND DESIGN CODES:

PUERTO RICO BUILDING CODE 2018 AND ITS BINDING REFERENCED STANDARDS, INCLUDING BUT NOT LIMITED TO THE INTERNATIONAL BUILDING CODE 2018

AMERICAN INSTITUTE FOR STEEL CONSTRUCTION (AISC), STEEL CONSTRUCTION MANUAL, 15 TH EDITION AMERICAN CONCRETE INSTITUTE (ACI), BUILDING CODE REQUIREMENTS FOR STRUCTURAL CONCRETE, ACI 318-14.

OTHER STRUCTURES, ASCE/SEI 7-16 STRUCTURAL NOTES ON CONCRETE REPAIR:

ALL CONCRETE REPAIR WORKS SHALL BE PERFORMED FOLLOWING THE GUIDELINES OF THE INTERNATIONAL CONCRETE REPAIR INSTITUTE (ICRI). HIRING A PROFESSIONAL EXPERIENCED IN THIS TYPE OF REPAIR IS RECOMMENDED TO ENSURE A PROPER

FOR THE REPAIR OF AREAS AFFECTED BY CORROSION, ICRI NO. 03730 GUIDELINE FOR SURFACE PREPARATION FOR THE REPAIR OF DETERIORATED CONCRETE RESULTING FROM REINFORCING STEEL CORROSION SHOULD BE FOLLOWED. BEFORE COMMENCING ANY CONCRETE REPAIR WORK, THE CONTRACTOR SHALL REVIEW THE REPAIR DETAILS PRESENTED IN THE DRAWINGS. IN CASE OF DOUBT WITH THE REPAIR DETAILS PRESENTED, THE CONTRACTOR SHOULD CONTACT THE

AMERICAN SOCIETY OF CIVIL ENGINEERS, MINIMUM DESIGN LOADS AND ASSOCIATED CRITERIA FOR BUILDINGS AND

ARCHITECT OR ENGINEER OF RECORD TO CLARIFY THEM. IT IS IMPORTANT TO FOLLOW THE MANUFACTURER'S RECOMMENDATIONS FOR EACH PRODUCT UTILIZED FOR THIS JOB, IN ORDER TO GUARANTEE THAT THE REPAIR WORKS ARE CARRIED OUT ADEQUATELY.

<u>STRUCTURAL NOTES ON CAST-IN-PLACE CONCRETE:</u>

PORTLAND CEMENT SHALL BE TYPE II. ALL CONCRETE SHALL BE OF REGULAR WEIGHT (145 POUNDS PER CUBIC FOOT). THE FOLLOWING CONCRETE MIX PARAMETERS SHALL BE USED UNLESS OTHERWISE NOTED:

CONCRETE STRENGTH AT 28 DAYS – 3,000 PSI MAX. WATER/CEMENT RATIO - 0.65 RECOMMENDED SLUMP – 3 INCHES MAX. AGGREGATE SIZE (ASTM C33) - 1 INCH

PROVIDE CONCRETE MIXES DESIGNED BY A QUALIFIED TESTING LABORATORY FOR REVIEW AND APPROVAL BY THE STRUCTURAL ENGINEER. CONCRETE MIX DESING SHALL BE SIGNED AND SEALED BY A PROFESSIONAL ENGINEER AUTHORIZED TO EXERCISE THE PROFESSION IN THE COMMOM WEALTH OF PUERTO RICO.

NOTE ON REINFORCING STEEL BARS:

ALL REINFORCING STEEL SHALL BE NEW STOCK DEFORMED BARS CONFORMING TO ASTM A615, GRADE 60 (FY = 60 KSI). MAINTAIN THE FOLLOWING CONCRETE COVERAGE FOR REINFORCING STEEL UNLESS NOTED OTHERWISE:

CONCRETE CAST AGAINST EARTH: 3 INCHES

CONCRETE IN CONTACT WITH THE GROUND: 2 INCHES

CONCRETE SLAB AND WALLS WITHOUT CONTACT WITH GROUND: 1 INCHES CONCRETE BEAMS AND COLUMNS: 1 1/2 INCHES

STRUCTURAL STEEL

DESIGN, DETAIL AND ERECT STRUCTURAL STEEL ELEMENTS IN ACCORDANCE WITH THE FOLLOWING:

AISC SPECIFICATION FOR THE DESIGN, FABRICATION, AND ERECTION OF STRUCTURAL STEEL FOR BUILDINGS

AISC MANUAL OF STEEL CONSTRUCTION, ALLOWABLE STRESS DESIGN. AISC CODE OF STANDARD PRACTICE FOR STEEL BUILDINGS AND BRIDGES.

STRUCTURAL STEEL SHALL CONFORM TO THE FOLLOWING GRADES:

W SHAPES: ASTM A992 (FY = 50 KSI, FU = 65 KSI)

AWS STRUCTURAL WELDING CODE, D1.1.

STEEL ANGLE, CHANNELS, PLATES: ASTM A36 BOLTS, NUTS AND WASHERS: HIGH-STRENGTH BOLTS, INCLUDING NUTS AND WASHERS: ASTM A325

STEEL PLATES FOR LANDINGS AND THREADS: 1/4" ANTI-SLIP DIAMOND TYPE STEEL PLATE A36 WELDING ELECTRODE FOR STEEL SHALL BE E70XX.

PROVIDE DESIGN, FABRICATION, AND ERECTION OF METAL DECK CONFORMING TO THE STEEL DECK INSTITUTE'S "CODE OF FORM ROOF DECK FROM STEEL SHEETS CONFORMING TO ASTM A 611 GRADE C AND D OR A 653 OR HIGHER SPECIFICATIONS

WITH A MINIMUM YIELD STRENGTH OF 33 KSI. ATTACH SHEETS TO STEEL SUPPORT MEMBERS AS INDICATED AND IN ACCORDANCE WITH THE MANUFACTURER'S INSTRUCTIONS FOR INSTALLATION. WHEN DECK IS SCHEDULED TO BEEXPOSED, DE-SLAG, CLEAN AND TOUCH UP WELDS WITH A ZINC-RICH

LAP ROOF AND FLOOR DECK ENDS MINIMUM OF 2 INCHES. WHEN FASTENING DECK TO SUPPORT MEMBERS PROVIDE WELDING MATERIALS INSTALLATION PROCEDURES TO PREVENT BURNING OF HOLES IN DECK.

AT ENDS OF DECKS OR WHERE CHANGES OF DECK DIRECTION OCCUR, FASTEN TO SUPPORTS AT EACH FLUTE. PROVIDE ADEQUATE CLOSURES AND FASTENERS TO SIDES AT EIGHTEEN INCHES ON CENTER. WHERE PARTIAL PANELS MAY BE REQUIRED TO COMPLETE DECK INSTALLATION AT PERIMETER OF STRUCTURE, PROVIDE WELDS

IN EACH FLUTE TO STRUCTURAL MEMBERS. INSTALL DECK IN THREE CONTINUOUS SPAN LENGTHS. AT PERIMETER OF DECK, SECURE DECK TO STRUCTURAL MEMBERS WITH SAME ATTACHMENTAND SPACING SUPPORT ATTACHMENT AS INDICATED ON PLANS. HOT DIP GALVANIZE (G90) AFTER FABRICATION ALL METAL DECK AND TOUCH UP CONNECTIONS WITH A ZINC-RICH PRIMER.

NOTES (IF APPLICABLE):

TREE REMOVAL:

REMOVE ALL TREES INDICATED BY THE DRAWINGS AND SPECIFICATIONS, AS REQUIRING REMOVAL, IN A MANNER THAT WILL NOT DAMAGE ADJACENT TREES OR STRUCTURES OR COMPACTS THE SOIL.

REMOVE TREES THAT ARE ADJACENT TO TREES OR STRUCTURES TO REMAIN, IN SECTIONS, TO LIMIT THE OPPORTUNITY OF DAMAGE TO ADJACENT CROWNS, TRUNKS, GROUND PLANE ELEMENTS AND STRUCTURES. DO NOT DROP TREES WITH A SINGLE CUT UNLESS THE TREE WILL FALL IN AN AREA NOT INCLUDED IN THE TREE AND PLANT PROTECTION AREA. NO TREE TO BE REMOVED WITHIN 50 FEET OF THE TREE AND PLANT PROTECTION AREA SHALL BE PUSHED

REMOVE STUMPS AND IMMEDIATE ROOT PLATE FROM EXISTING TREES TO BE REMOVED. GRIND TRUNK BASES AND LARGE

OVER OR UP-ROOTED USING A PIECE OF GRADING EQUIPMENT. PROTECT ADJACENT PAVING, SOIL, TREES, SHRUBS, GROUND COVER PLANTINGS AND UNDERSTORY PLANTS TO REMAIN FROM DAMAGE DURING ALL TREE REMOVAL OPERATIONS, AND FROM CONSTRUCTION OPERATIONS. PROTECTION SHALL INCLUDE THE ROOT SYSTEM, TRUNK, LIMBS, AND CROWN FROM BREAKAGE OR SCARRING, AND THE SOIL FROM COMPACTION.

BUTTRESS ROOTS TO A DEPTH OF THE LARGEST BUTTRESS ROOT OR AT LEAST 18 INCHES BELOW THE TOP MOST ROOTS WHICH EVER IS LESS AND OVER THE AREA OF THREE TIMES THE DIAMETER OF THE TRUNK (DBH). FOR TREES WHERE THE STUMP WILL FALL UNDER NEW PAVED AREAS, GRIND ROOTS TO A TOTAL DEPTH OF 18 INCHES BELOW THE EXISTING GRADE. IF THE SIDES OF THE STUMP HOLE STILL HAVE GREATER THAN APPROXIMATELY 20% WOOD VISIBLE, CONTINUE GRINDING OPERATION DEEPER AND OR WIDER UNTIL THE RESULTING HOLE HAS LESS THAN 20% WOOD. REMOVE ALL WOOD CHIPS PRODUCED BY THE GRINDING OPERATION AND BACK FILL IN 8 INCH LAYERS WITH CONTROLLED FILL OF A QUALITY ACCEPTABLE TO THE SITE ENGINEER FOR FILL MATERIAL UNDER STRUCTURES, COMPACTED TO 95% OF THE MAXIMUM DRY DENSITY STANDARD PROCTOR. THE OWNER'S REPRESENTATIVE SHALL APPROVE EACH HOLE AT THE END OF THE GRINDING

IN AREAS WHERE THE TREE LOCATION IS TO BE A PLANTING BED OR LAWN, REMOVE ALL WOODCHIPS AND BACKFILL STUMP HOLES WITH PLANTING SOIL AS DEFINED IN SPECIFICATION SECTION PLANTING SOIL, IN MAXIMUM OF 12 INCH LAYERS AND COMPACT TO 80 - 85% OF THE MAXIMUM DRY DENSITY STANDARD PROCTOR.

WITHIN SIX MONTHS OF THE ESTIMATED DATE OF SUBSTANTIAL COMPLETION, PRUNE ALL DEAD OR HAZARDOUS BRANCHES LARGER THAN 2 INCH IN DIAMETER FROM ALL TREES TO REMAIN.

IMPLEMENT ALL PRUNING RECOMMENDATIONS FOUND IN THE ARBORIST REPORT PRUNE ANY LOW, HANGING BRANCHES AND VINES FROM EXISTING TREES AND SHRUBS THAT OVERHANG WALKS, STREETS AND DRIVES, OR PARKING AREAS AS FOLLOWS:

1. WALKS - WITHIN 8 FEET VERTICALLY OF THE PROPOSED WALK ELEVATION.

2. PARKING AREAS - WITHIN 12 FEET VERTICALLY OF THE PROPOSED PARKING SURFACE ELEVATION.

3. STREETS AND DRIVES - WITHIN 14 FEET VERTICALLY OF THE PROPOSED DRIVING SURFACE ELEVATION.

ALL PRUNING SHALL BE DONE IN ACCORDANCE WITH ANSI A300 (PART 1), ISA BMP TREE PRUNING (LATEST EDITION, AND THE "STRUCTURAL PRUNING: A GUIDE FOR THE GREEN INDUSTRY", EDWARD GILMAN, BRIAN KEMPF, NELDA MATHENY AND JIM CLARK, 2013 URBAN TREE FOUNDATION, VISALIA CA.

PERFORM OTHER PRUNING TASK AS INDICATED ON THE DRAWINGS OR REQUESTED BY THE OWNER'S REPRESENTATIVE. WHERE TREE SPECIFIC DISEASE VECTORS REQUIRE, STERILIZE ALL PRUNING TOOLS BETWEEN THE WORK IN INDIVIDUAL TREES.

ABBREVIATIONS: GENERAL DRAWING SYMBOLS:

EXISTING WALL NEW CONCRETE BLOCK WALL 6" OR 8" NEW PLYCEM BOARD WALL

BEHIND AS INDICATED.

DETAIL REFERENCE NUMBER DETAIL REFERENCE SYMBOL - SHEET WHERE DETAIL IS DRAWN ELEVATION REFERENCE NUMBER

SHEET WHERE ELEVATION IS DRAWN - SECTION REFERENCE NUMBER GENERAL BUILDING SECTION - SHEET WHERE SECTION IS DRAWN

- WALL SECTION REFERENCE NUMBER

- ELEVATION REFERENCE NUMBER

WALL SECTION SHEET WHERE INT. ELEV. IS DRAWN INTERIOR ELVATION SYMBOL

NORTH ARROW

KEY NOTE

RISER SYMBOL

REVISION SYMBOL

HANDICAPPED SYMBOL

WINDOW SYMBO

EQUIPMENT SYMBO LEVEL SYMBOL

ROOM IDENTIFICATION ROOM NUMBER

AIR CONDITIONING

CENTER TO CENTER

CONCRETE MASONRY UNIT

FINISH FLOOR ELEVATIONS

FINISH FLOOR LEVEL

ALUMINUM

CORRIDOR

CORROSION

ELEVATION

FLOOR DRAIN

FINISH(ED)

HARDWARE

JANITOR CLOSE

NOT IN CONTRA

ROOF DRAIN

REQUIRED

SMOOTH CEMENT PLAST

STAINLESS STEEL

TOP OF MASONRY

UNLESS OTHERWISE NOTED

TOP OF STEEL

DROP MANHOLE

VERIFY IN FIELD

TELEPHONE

STORM SEWER

STRUCTURAL

MECHANICAL

MINIMUM

MOUNTED

F.F.L.

T.O.S.

THIS DOCUMENT REPRESENTS THE IDEAS AND EFFORTS OF CSA ARCHITECTS AND ENGINEERS. IT SHALL BE USED ONLY BY AUTHORIZED PERSONS AND SHALL NOT BE REPRODUCED OR EXHIBITED WITHOUT WRITTEN CONSENT OF

CSA ARCHITECTS AND ENGINEERS.

PUERTO RICO INDUSTRIAL DEVELOPMENT COMPANY PRIDCO

ISSUE FOR BID

FEBRUARY 21, 2024

	REV	DATE		DESCRIPTION	
_					
С	DISC	IPLINE IN	JEORM	ATION:	
		ROFESIONAL:			
	ANNE	TTE ALFO	ONSO		
	PROFES	SIONAL OF RE	ECORD:		
	ANNE	TTE ALFO	NSO		
	STAFF D	ESIGNER:			
	JOHA	NNA SALO	CEDO		
	Q.C. AUI	DITOR:			

PROFESSIONAL'S STATEMENT:

YO, ANNETTE ALFONSO

CERTIFICO QUE SOY EL PROFESIONAL QUE ICONFECCIONÓ, DISEÑÓ O PREPARÓI ESTOS PLANOS TAMBIÉN, CERTIFICO QUE ENTIENDO QUE DICHOS PLANOS Y ESPECIFICACIONES CUMPLEN CON LAS DISPOSICIONES APLICABLES DEL REGLAMENTO CONJUNTO Y LAS DISPOSICIONES APLICABLES DE LOS REGLAMENTOS Y CÓDIGOS DE CONSTRUCCIÓN VIGENTES DE LAS AGENCIAS. JUNTAS REGLAMENTADORAS O CORPORACIONES PÚBLICAS CON JURISDICCIÓN. CERTIFICO, ADEMÁS, QUE EN LAPREPARACIÓN DE ESTOS PLANOS Y ESPECIFICACIONES SE HA CUMPLIDO CABALMENTE CON LO DISPUESTO EN LA LEY NÚM. 14 DE 8 DE ENERO DE 2004. SEGÚN ENMENDADA, CONOCIDA COMO LA "LEY PARA LA INVERSIÓN POR LA INDUSTRIA PUERTORRIQUEÑA" Y CON LA [LEY NÚM. 319 DE 15 DE MAYO DE 1938, SEGÚN ENMENDADA; LEY NÚM. 96 DE 6 DE JULIO DE 1978, SEGÚN ENMENDADA: SEGÚN APLIQUEI, RECONOZCO QUE CUALQUIER DECLARACIÓN FALSA O FALSIFICACIÓN DE LOS HECHOS QUE SE HAYA PRODUCIDO POR

PRIDCO DAMAGE IMPROVEMENTS **NORTH REGION STAGE 1 BID PACKAGE N1-3**

PW: 8067 / UTUADO

DESCONOCIMIENTO O POR NEGLIGENCIA YA SEA

PERSONAS CON MI CONOCIMIENTO. ME HACEN

DISCIPLINARIA POR LA OGPE.

POR MÍ, MIS AGENTES O EMPLEADOS, O POR OTRAS

RESPONSABLE DE CUALQUIER ACCIÓN JUDICIAL Y


SHEET TITLE:


GENERAL NOTES, ABBREVIATIONS AND LEGEND

AS SHOWN

DELIVERY DATE PROJECT NUMBER: 21-0258-02 PRINT DATE & TIME: BIM FILE NAME: 4/22/2024 3:28:38 PM

DRAWING / MODEL LOCATION:

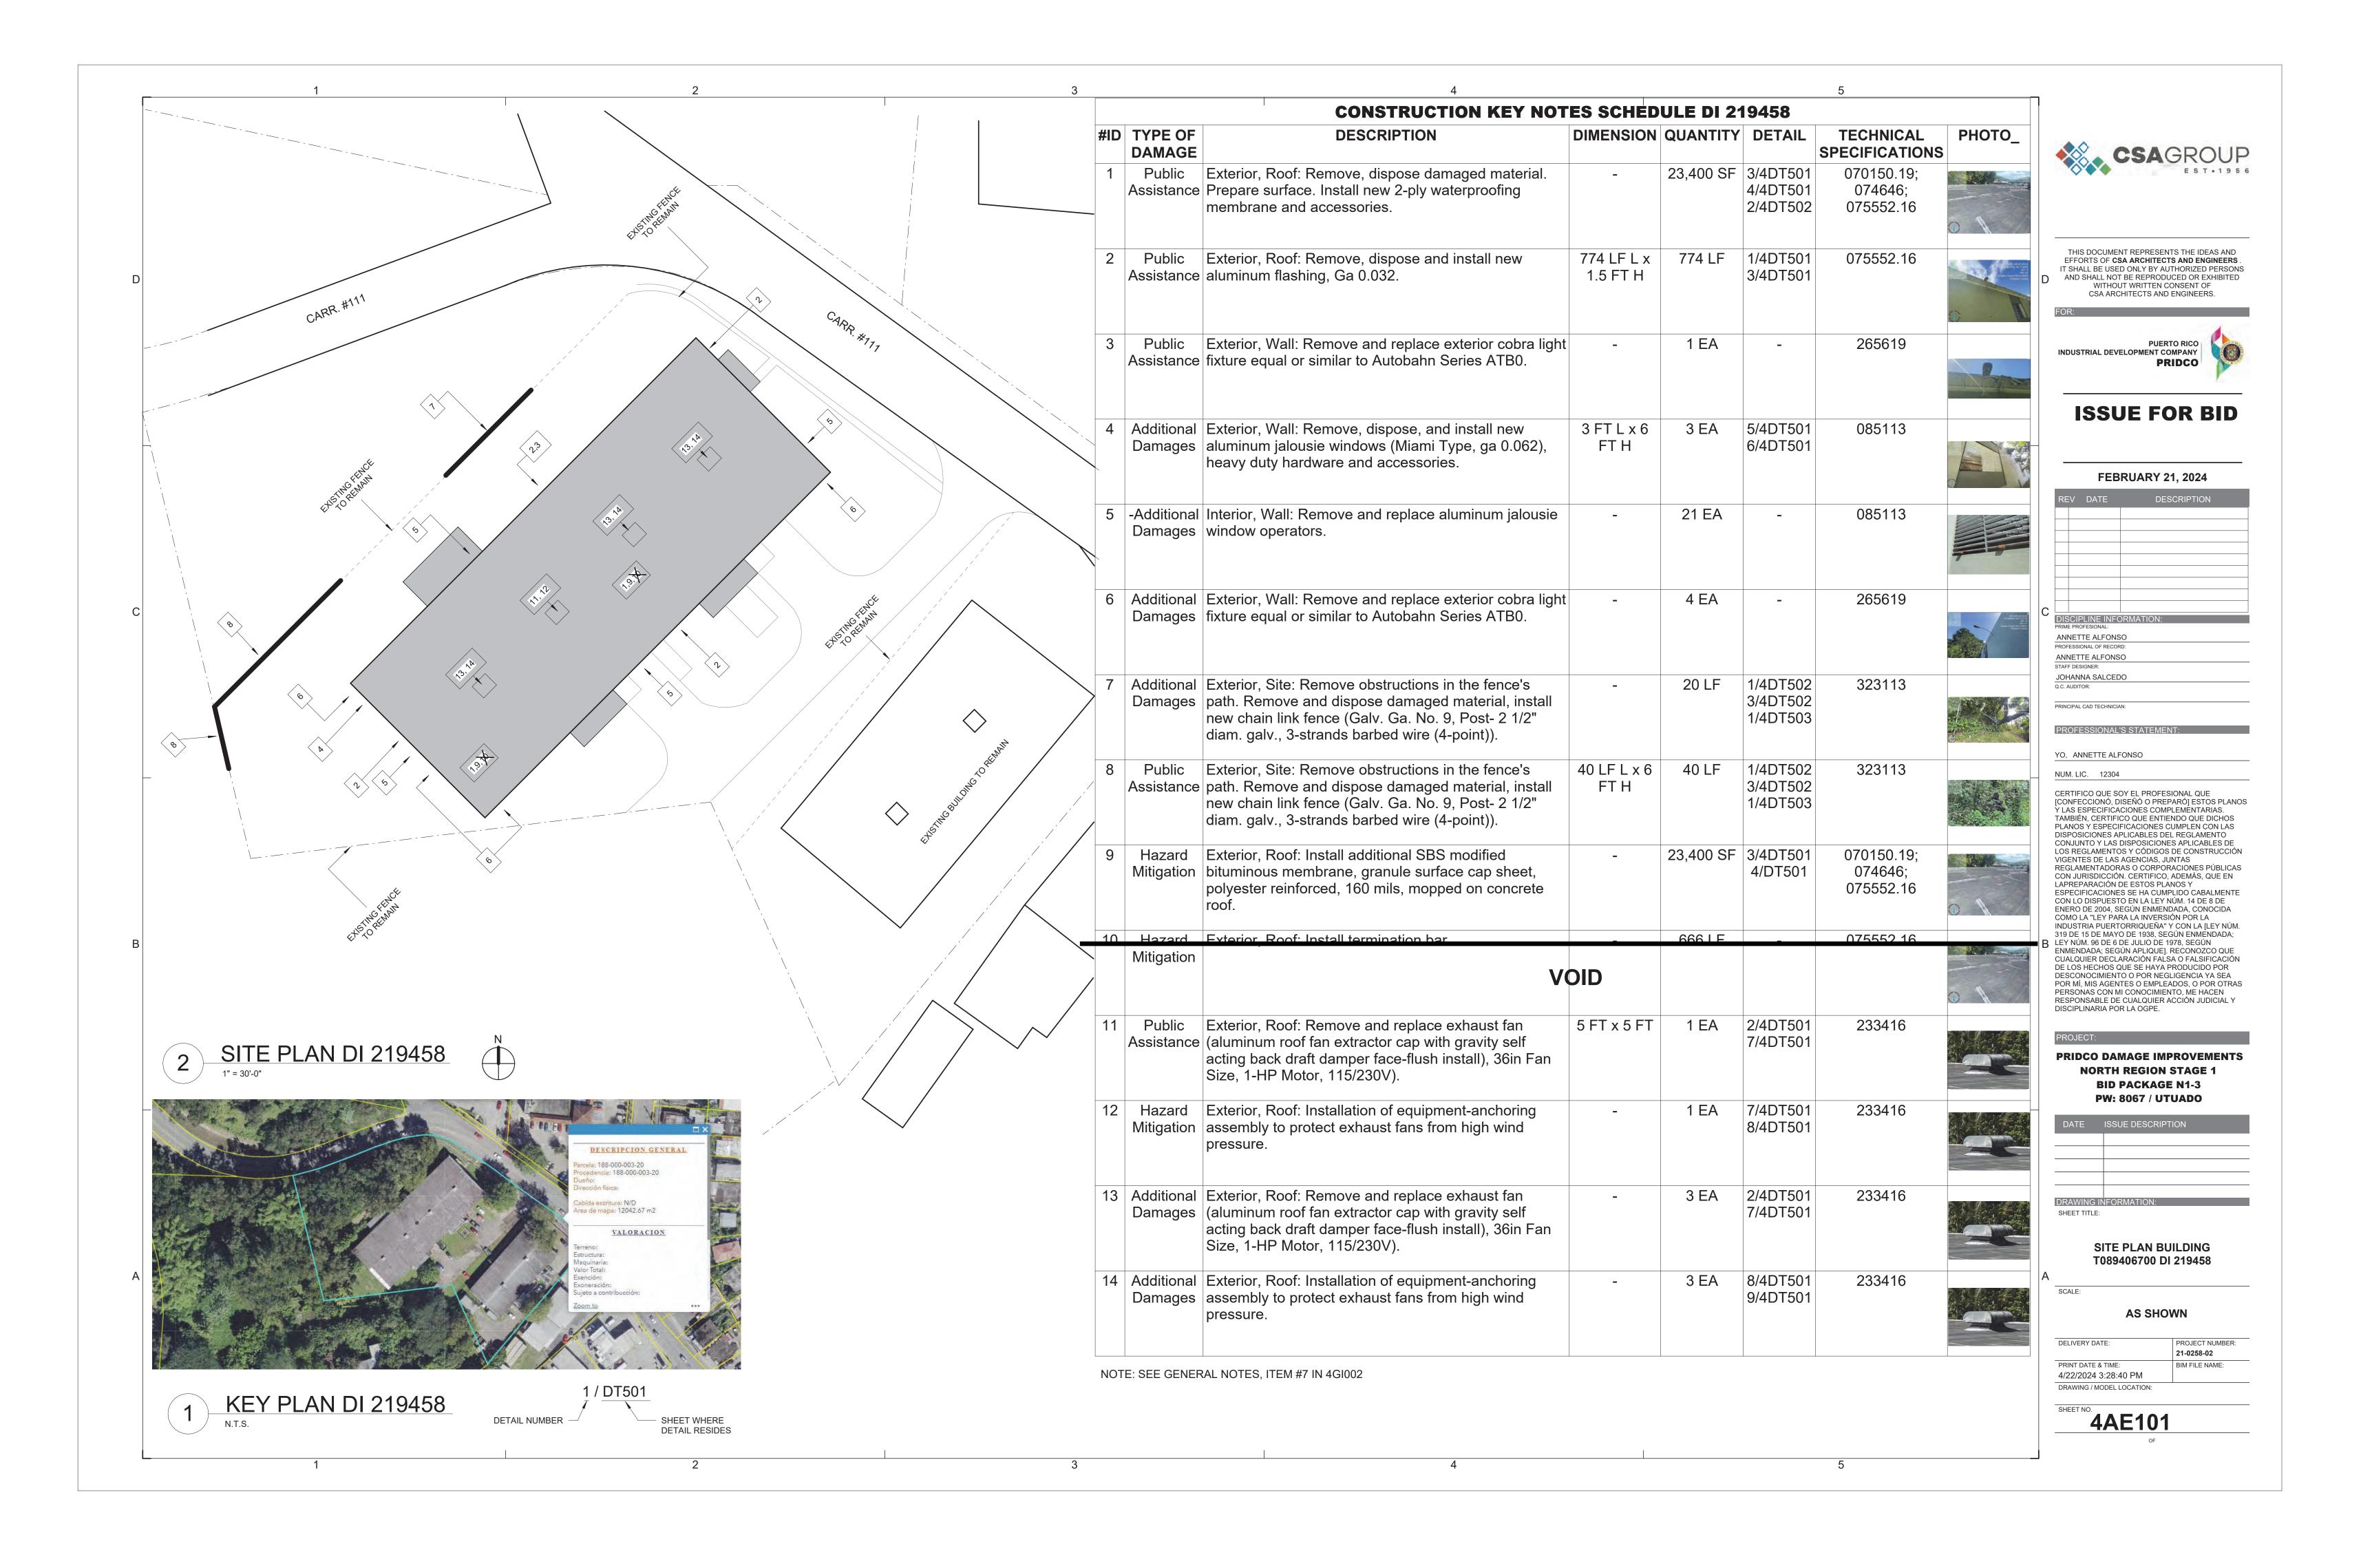

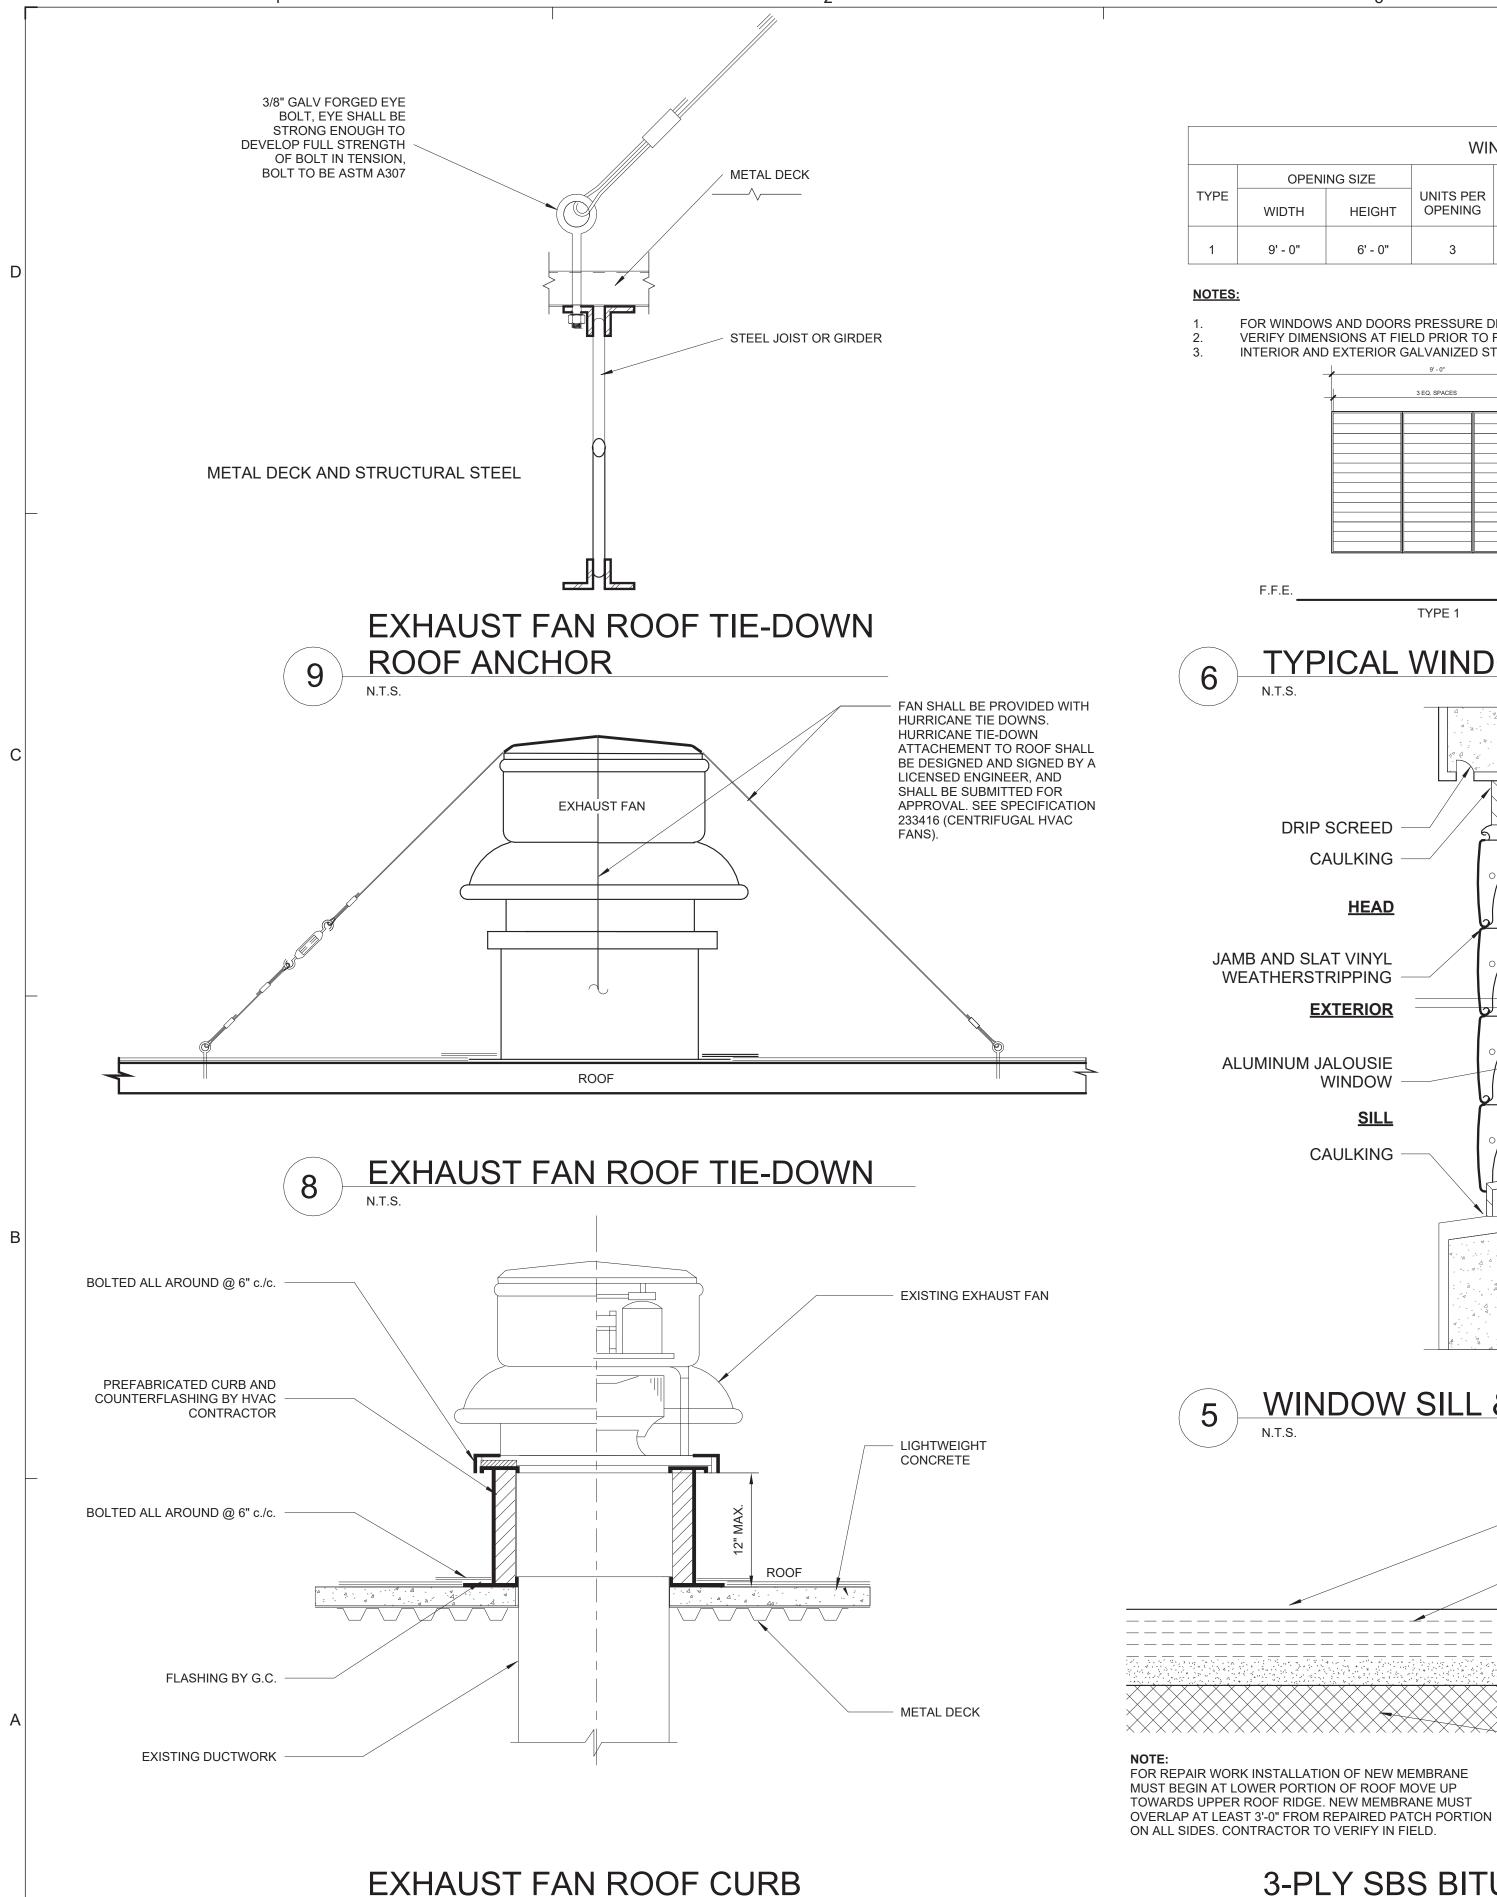


DETAIL


WINDOW TYPES							
	OPENI	NG SIZE			MATERIAL		
TYPE	WIDTH	HEIGHT		SILL HEIGHT	WINDOW	FRAME	
1	9' - 0"	6' - 0"	3	3' - 0"	0.062-GAUGE MIAMI TYPE	ALUMINUM	

NOTES:


FOR WINDOWS AND DOORS PRESSURE DESIGN, REFER TO SB103 - TYPICAL WALL WIND LOADS DIAGRAM. VERIFY DIMENSIONS AT FIELD PRIOR TO FABRICATING AND INSTALLING DOORS, WINDOW, AND STOREFRONT SYSTEM. INTERIOR AND EXTERIOR GALVANIZED STEEL DOORS SHALL BE FACTORY PAINTED COLOR. TBD BY ARCHITECT.

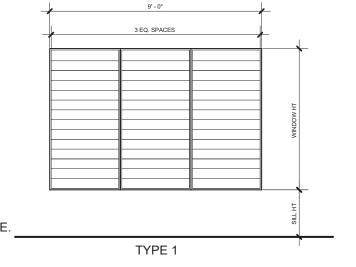


TYPICAL WINDOWS

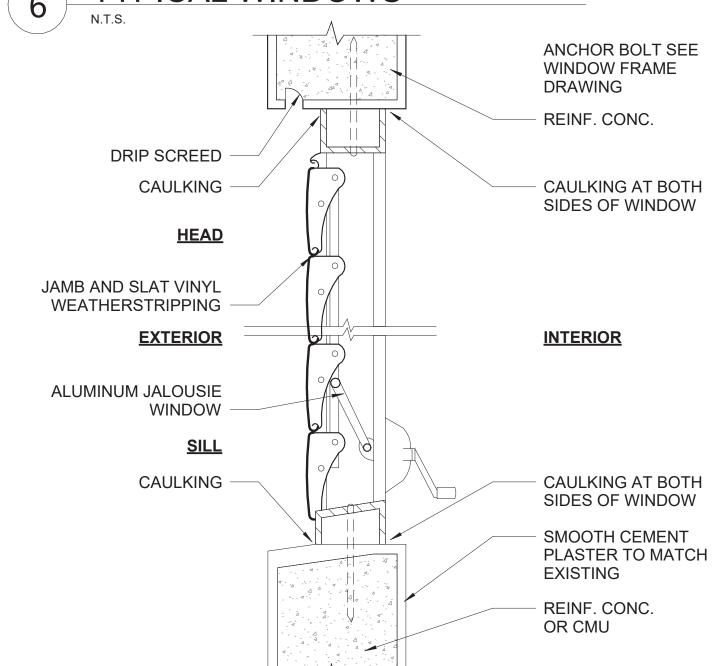


WINDOW SILL & HEAD DETAIL

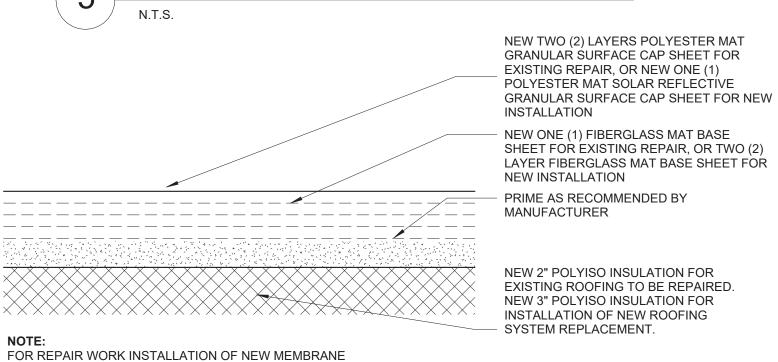


3-PLY SBS BITUMINOUS MEMBRANE SECTION

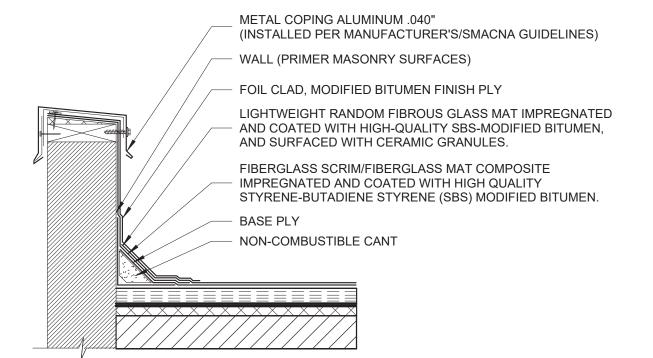



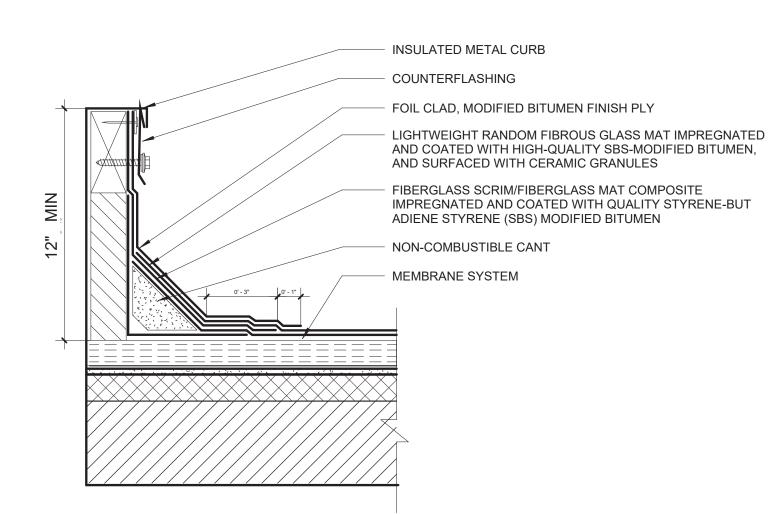

FLASHING AT EXHAUST FAN **CURB DETAIL**

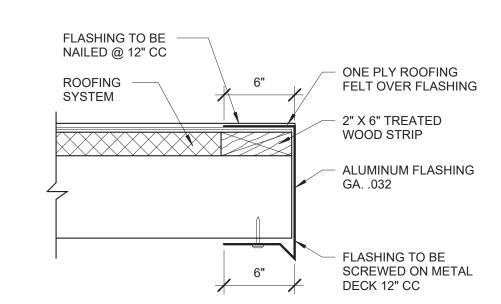





THIS DOCUMENT REPRESENTS THE IDEAS AND EFFORTS OF CSA ARCHITECTS AND ENGINEERS. IT SHALL BE USED ONLY BY AUTHORIZED PERSONS AND SHALL NOT BE REPRODUCED OR EXHIBITED WITHOUT WRITTEN CONSENT OF CSA ARCHITECTS AND ENGINEERS.

PUERTO RICO INDUSTRIAL DEVELOPMENT COMPANY



ISSUE FOR BID

FEBRUARY 21, 2024

			· .				
	REV	DATE	DESCRIPTION				
С							
C	DISCIPLINE INFORMATION:						
	PRIME PR	OFESIONAL:					
	ANNE	TTE ALFONS	80				
	PROFESS	IONAL OF RECOF	RD:				
	ANNET	TE ALFONS	80				
	STAFF DE	SIGNER:					
	JOHAN	INA SALCED	00				
	Q.C. AUDI	TOR:					
	PRINCIPA	L CAD TECHNICIA	ANI:				


PRINCIPAL CAD TECHNICIAN:

NUM. LIC. 12304

PROFESSIONAL'S STATEMENT: YO, ANNETTE ALFONSO

CERTIFICO QUE SOY EL PROFESIONAL QUE [CONFECCIONÓ, DISEÑÓ O PREPARÓ] ESTOS PLANOS VIAS ESPECIFICACIONES COMPLEMENT TAMBIÉN, CERTIFICO QUE ENTIENDO QUE DICHOS PLANOS Y ESPECIFICACIONES CUMPLEN CON LAS DISPOSICIONES APLICABLES DEL REGLAMENTO CONJUNTO Y LAS DISPOSICIONES APLICABLES DE LOS REGLAMENTOS Y CÓDIGOS DE CONSTRUCCIÓN VIGENTES DE LAS AGENCIAS, JUNTAS REGLAMENTADORAS O CORPORACIONES PÚBLICAS CON JURISDICCIÓN. CERTIFICO, ADEMÁS, QUE EN LAPREPARACIÓN DE ESTOS PLANOS Y ESPECIFICACIONES SE HA CUMPLIDO CABALMENTE CON LO DISPUESTO EN LA LEY NÚM. 14 DE 8 DE ENERO DE 2004, SEGÚN ENMENDADA, CONOCIDA COMO LA "LEY PARA LA INVERSIÓN POR LA INDUSTRIA PUERTORRIQUEÑA" Y CON LA [LEY NÚM. 319 DE 15 DE MAYO DE 1938, SEGÚN ENMENDADA; B LEY NÚM. 96 DE 6 DE JULIO DE 1978, SEGÚN ENMENDADA; SEGÚN APLIQUE]. RECONOZCO QUE CUALQUIER DECLARACIÓN FALSA O FALSIFICACIÓN DE LOS HECHOS QUE SE HAYA PRODUCIDO POR DESCONOCIMIENTO O POR NEGLIGENCIA YA SEA POR MÍ, MIS AGENTES O EMPLEADOS, O POR OTRAS PERSONAS CON MI CONOCIMIENTO, ME HACEN RESPONSABLE DE CUALQUIER ACCIÓN JUDICIAL Y DISCIPLINARIA POR LA OGPE.

PRIDCO DAMAGE IMPROVEMENTS **NORTH REGION STAGE 1 BID PACKAGE N1-3**

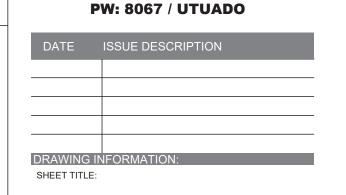


DETAILS AND SPECIFICATIONS


AS SHOWN DELIVERY DATE: PROJECT NUMBER:

21-0258-02


BIM FILE NAME:

PRINT DATE & TIME: 4/22/2024 3:28:41 PM DRAWING / MODEL LOCATION:

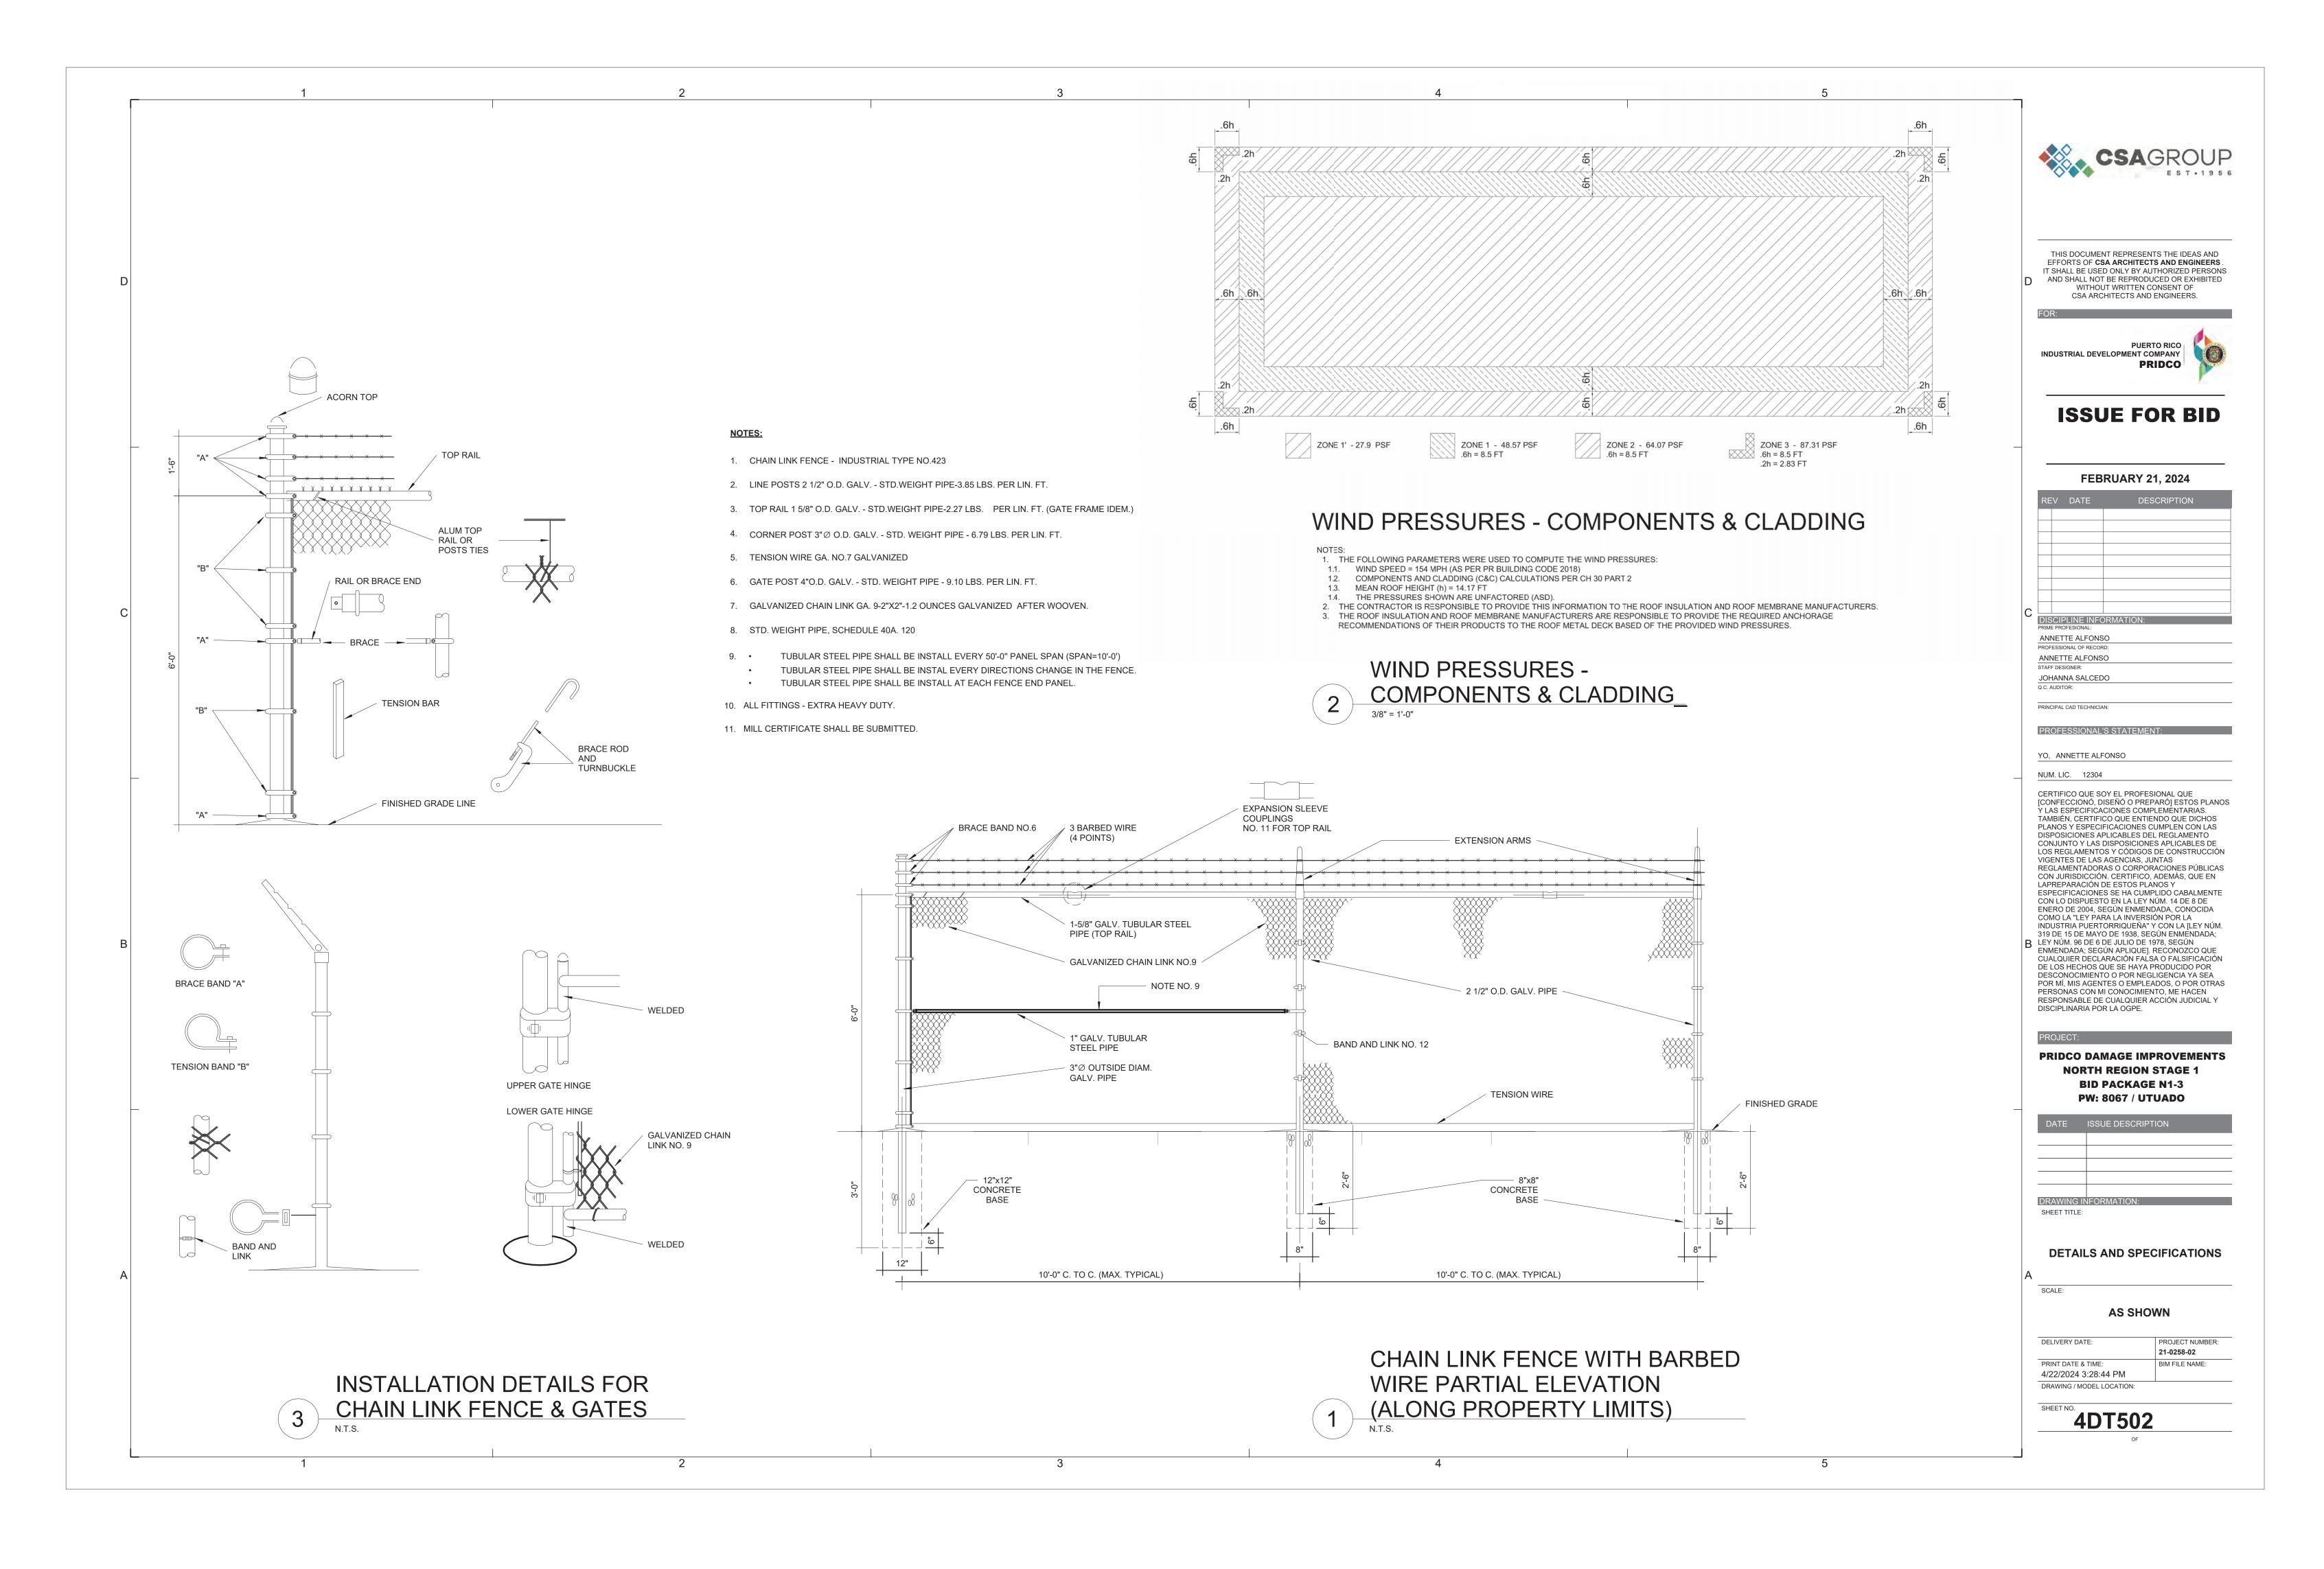


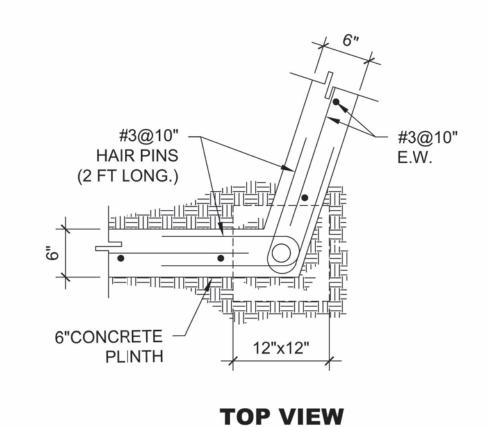

ADDITIONAL REINFORCEMENT AT FENCE POLE LOCATION (AT CORNERS)

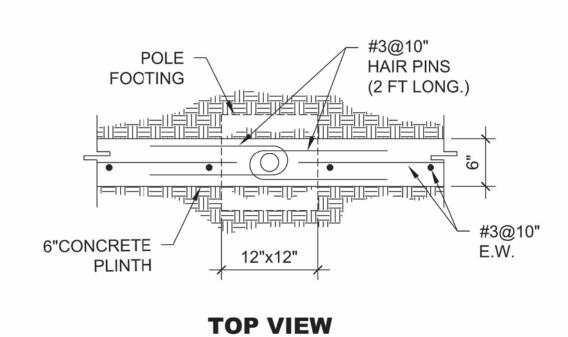


ADDITIONAL REINFORCEMENT AT FENCE POLE LOCATION

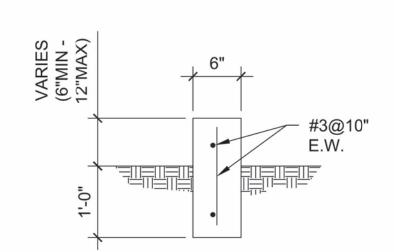

TYPICAL 6" CONCRETE PLINTH SECTION

NOTES:

- 1. CHAIN LINK FENCE INDUSTRIAL TYPE NO.423
- 2. LINE POSTS 2 7/8" O.D. GALV. STD.WEIGHT PIPE.
- 3. TOP RAIL 1 5/8" O.D. GALV. STD.WEIGHT PIPE. PER LIN. FT. (GATE FRAME IDEM.)
- 4. CORNER POST 2 7/8" Ø O.D. GALV. STD. WEIGHT PIPE
- 5. TENSION WIRE GA. NO.7 GALVANIZED
- 6. GATE POST 4"O.D. GALV. STD. WEIGHT PIPE 9.10 LBS. PER LIN. FT.
- 7. GALVANIZED CHAIN LINK GA. 9-2"X2"-1.2 OUNCES GALVANIZED AFTER WOOVEN.
- 8. STD. WEIGHT PIPE, SCHEDULE 40A. 120
- TUBULAR STEEL PIPE SHALL BE INSTALL EVERY 50'-0" PANEL SPAN (SPAN=10'-0') - TUBULAR STEEL PIPE SHALL BE INSTAL EVERY DIRECTIONS CHANGE IN THE FENCE. - TUBULAR STEEL PIPE SHALL BE INSTALL AT EACH FENCE END PANEL.
- 10. ALL FITTINGS EXTRA HEAVY DUTY.
- 11. MILL CERTIFICATE SHALL BE SUBMITTED.

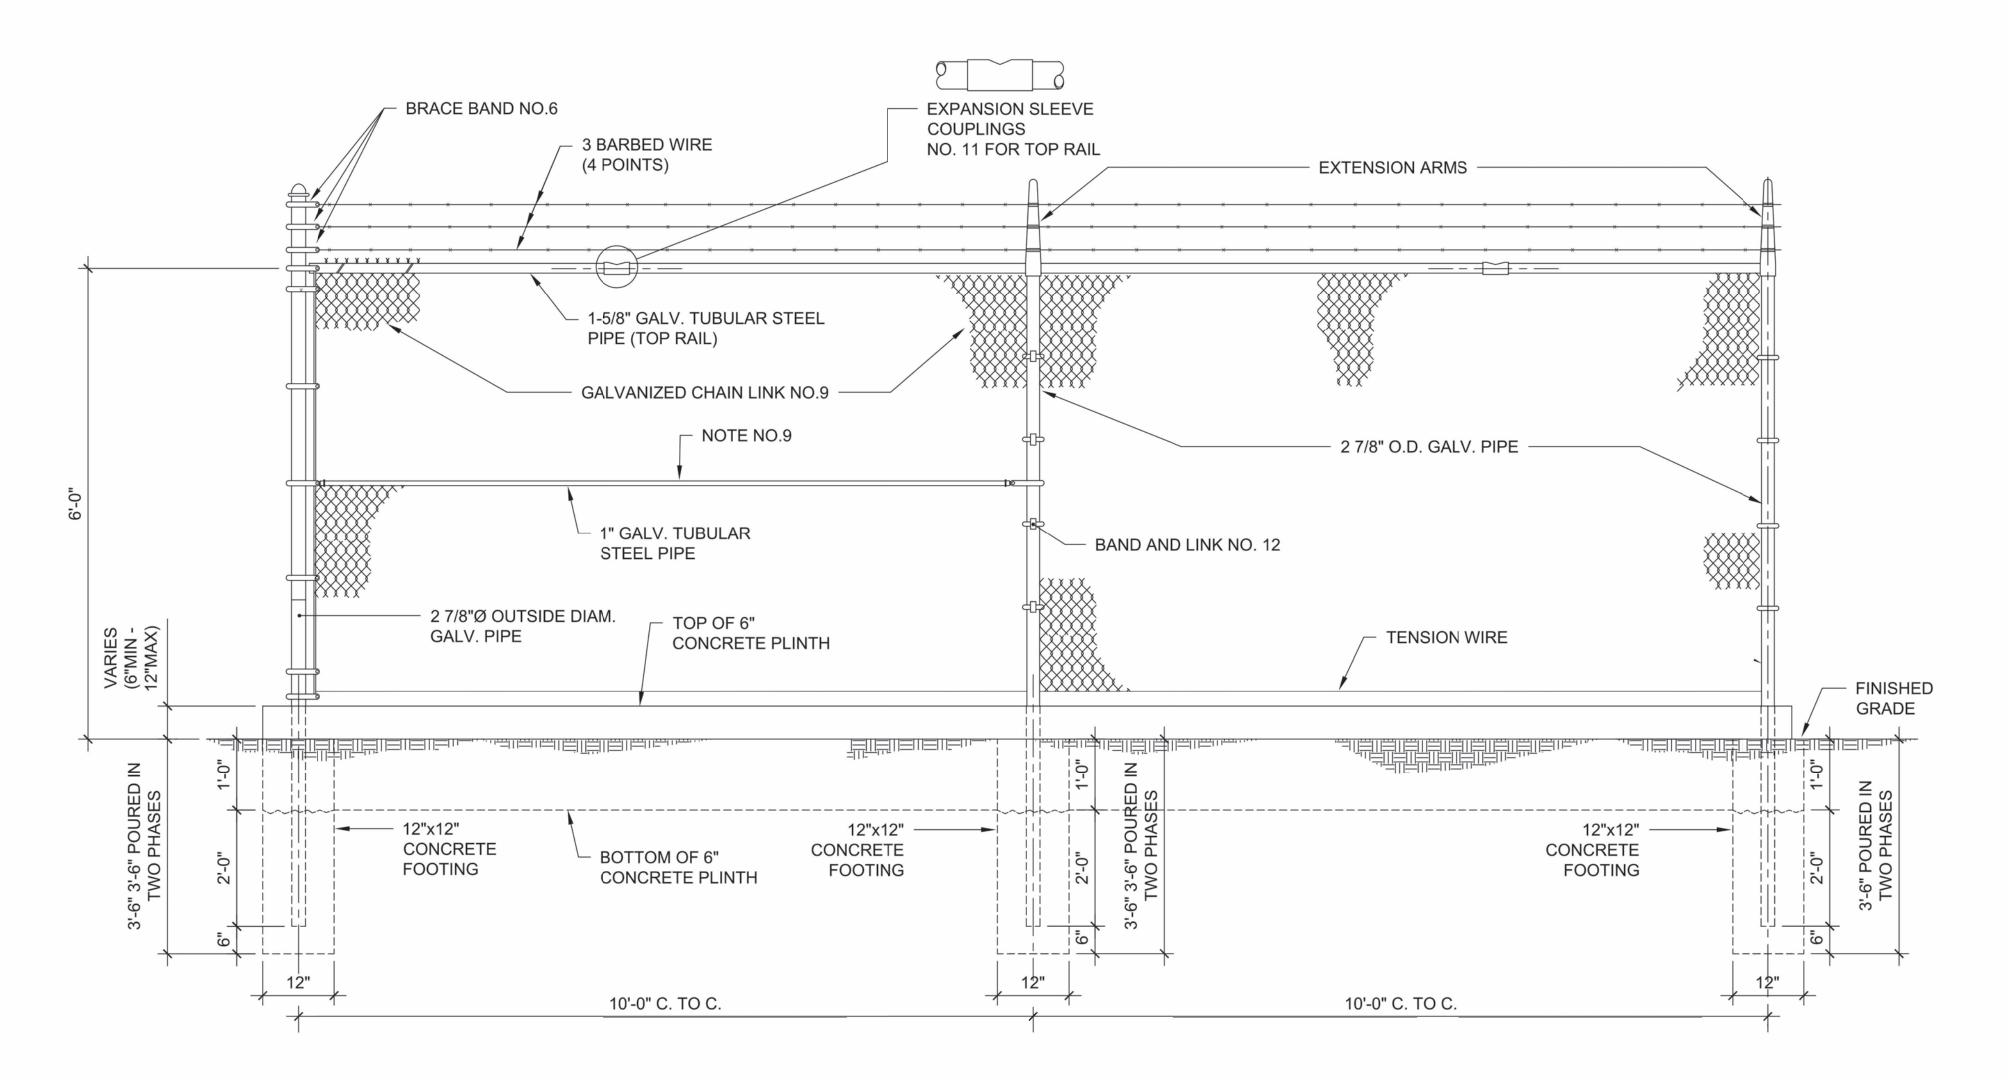

CHAIN LINK FENCE PARTIAL ELEVATION (ALONG PROPERTY LIMITS)

CHAIN LINK FENCE WITH BARBED WIRE AND CONCRETE PLINTH



THIS DOCUMENT REPRESENTS THE IDEAS AND EFFORTS OF CSA ARCHITECTS AND ENGINEERS. IT SHALL BE USED ONLY BY AUTHORIZED PERSONS AND SHALL NOT BE REPRODUCED OR EXHIBITED WITHOUT WRITTEN CONSENT OF CSA ARCHITECTS AND ENGINEERS.



ISSUE FOR BID

FEBRUARY 21, 2024

	RE	V	DATE	DESCRIPTION			
С	DISCIPLINE INFORMATION:						
			FESIONAL:				

ANNETTE ALFONSO

JOHANNA SALCEDO

PRINCIPAL CAD TECHNICIAN:

NUM. LIC. 12304

PROFESSIONAL'S STATEMENT: YO, ANNETTE ALFONSO

CERTIFICO QUE SOY EL PROFESIONAL QUE [CONFECCIONÓ, DISEÑÓ O PREPARÓ] ESTOS PLANOS TAMBIÉN, CERTIFICO QUE ENTIENDO QUE DICHOS PLANOS Y ESPECIFICACIONES CUMPLEN CON LAS DISPOSICIONES APLICABLES DEL REGLAMENTO CONJUNTO Y LAS DISPOSICIONES APLICABLES DE LOS REGLAMENTOS Y CÓDIGOS DE CONSTRUCCIÓN VIGENTES DE LAS AGENCIAS, JUNTAS REGLAMENTADORAS O CORPORACIONES PÚBLICAS CON JURISDICCIÓN. CERTIFICO, ADEMÁS, QUE EN LAPREPARACIÓN DE ESTOS PLANOS Y ESPECIFICACIONES SE HA CUMPLIDO CABALMENTE CON LO DISPUESTO EN LA LEY NÚM. 14 DE 8 DE ENERO DE 2004, SEGÚN ENMENDADA, CONOCIDA COMO LA "LEY PARA LA INVERSIÓN POR LA INDUSTRIA PUERTORRIQUEÑA" Y CON LA [LEY NÚM. 319 DE 15 DE MAYO DE 1938, SEGÚN ENMENDADA; LEY NÚM. 96 DE 6 DE JULIO DE 1978, SEGÚN ENMENDADA; SEGÚN APLIQUE]. RECONOZCO QUE CUALQUIER DECLARACIÓN FALSA O FALSIFICACIÓN DE LOS HECHOS QUE SE HAYA PRODUCIDO POR DESCONOCIMIENTO O POR NEGLIGENCIA YA SEA POR MÍ, MIS AGENTES O EMPLEADOS, O POR OTRAS PERSONAS CON MI CONOCIMIENTO, ME HACEN

PRIDCO DAMAGE IMPROVEMENTS **NORTH REGION STAGE 1 BID PACKAGE N1-3**

PW: 8067 / UTUADO

RESPONSABLE DE CUALQUIER ACCIÓN JUDICIAL Y

DISCIPLINARIA POR LA OGPE.

DETAILS AND SPECIFICATIONS


PROJECT NUMBER:


21-0258-02


BIM FILE NAME:


AS SHOWN

DELIVERY DATE: PRINT DATE & TIME: 4/22/2024 3:28:47 PM DRAWING / MODEL LOCATION:

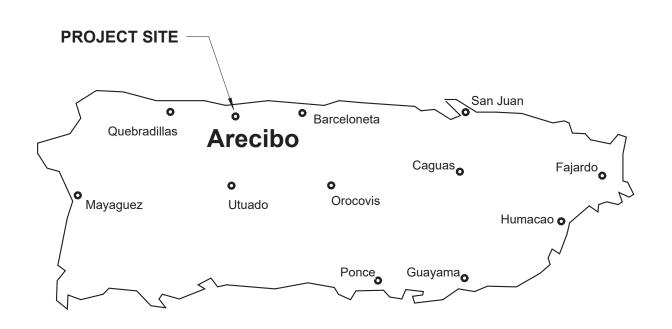

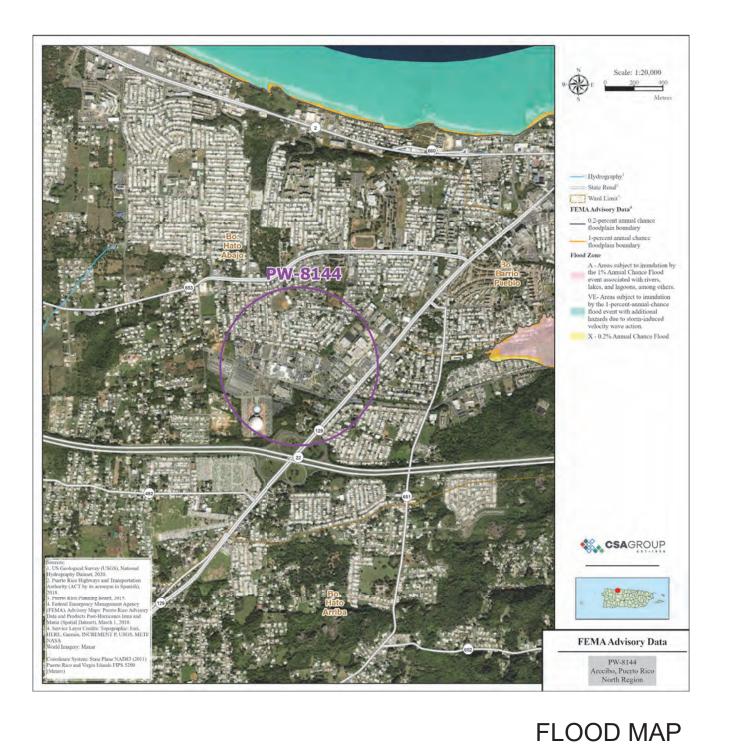

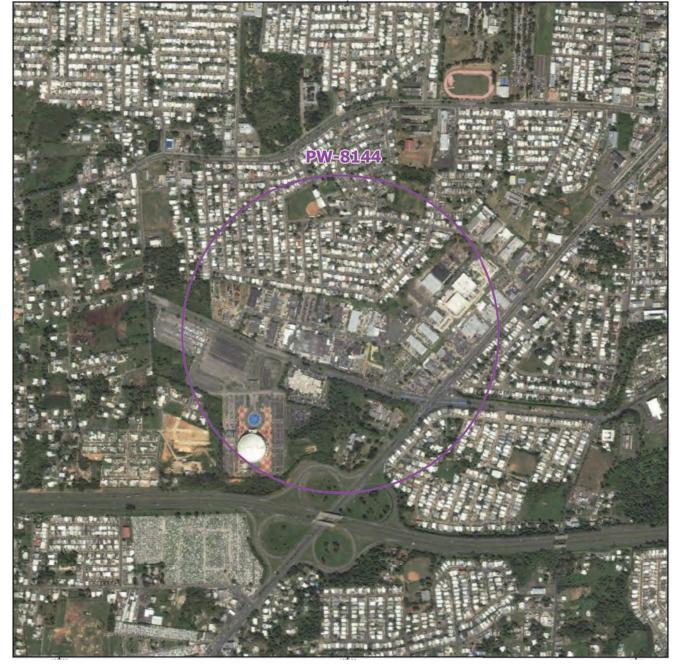

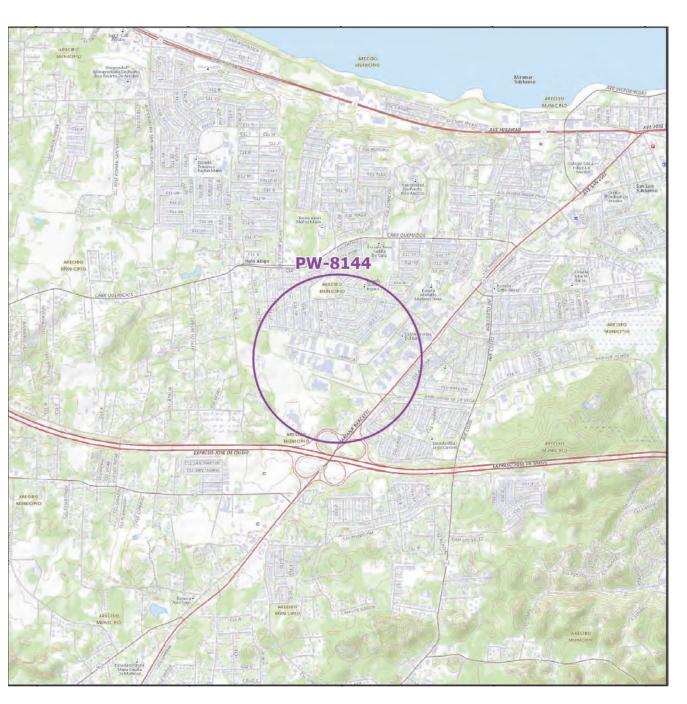

LOCATION MAP SCALE 1:20,000

INDEX OF DRAWINGS - PW 8144, DI 218811					
	Sheet	Current			
Discipline	Number	Revision	Sheet Name		
00-GENERAL	5GI001		COVER SHEET - DI 218811		
00-GENERAL	5GI002		GENERAL NOTES, ABBREVIATIONS AND LEGEND		
03-ARCHITECTURAL	5AE101		SITE PLAN BUILDING T082506700 DI 218811		
05-DETAILS	5DT501		DETAILS AND SPECIFICATIONS		
05-DETAILS	5DT502		DETAILS AND SPECIFICATIONS		

INDEX OF DRAWINGS - PW 8144, DI 218815						
Discipline	Sheet Number	Current Revision	Sheet Name			
00-GENERAL	6GI001		COVER SHEET - DI 218815			
00-GENERAL	6GI002		GENERAL NOTES, ABBREVIATIONS AND LEGEND			
03-ARCHITECTURAL	6AE101		SITE PLAN BUILDING T093606800 DI 218815			
05-DETAILS	6DT501		DETAILS AND SPECIFICATIONS			
05-DETAILS	6DT502		DETAILS AND SPECIFICATIONS			


INDEX OF DRAWINGS - PW 8144, DI 218823					
	Sheet	Current			
Discipline	Number	Revision	Sheet Name		
00-GENERAL	7GI001		COVER SHEET - DI 218823		
00-GENERAL	7GI002		GENERAL NOTES, ABBREVIATIONS AND LEGEND		
03-ARCHITECTURAL	7AE101		SITE PLAN BUILDING T125507900 DI 218823		
05-DETAILS	7DT501		DETAILS AND SPECIFICATIONS		
05-DETAILS	7DT502		DETAILS AND SPECIFICATIONS		
05-DETAILS	7DT503		DETAILS AND SPECIFICATIONS		

NORTH REGION STAGE 1 BID PACKAGE N1-3 PRIDCO-FEMA 4339 DR PROGRAM

AERIAL PHOTO


REPAIR AND IMPROVEMENTS OF INDUSTRIAL BUILDINGS OF THE PUERTO RICO INDUSTRIAL DEVELOPMENT COMPANY FOR THE:


5. PW: 8144 / DI: 218811 / Bldg: T082506700 / Mun: Arecibo
6. PW: 8144 / DI: 218815 / Bldg: T093606800 / Mun: Arecibo
7. PW: 8144 / DI: 218823 / Bldg: T125507900 / Mun: Arecibo

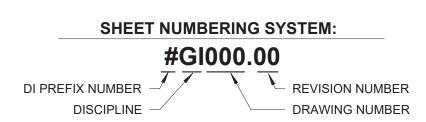






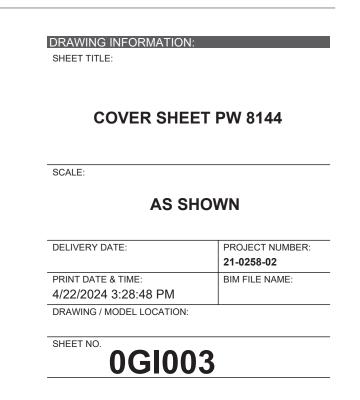

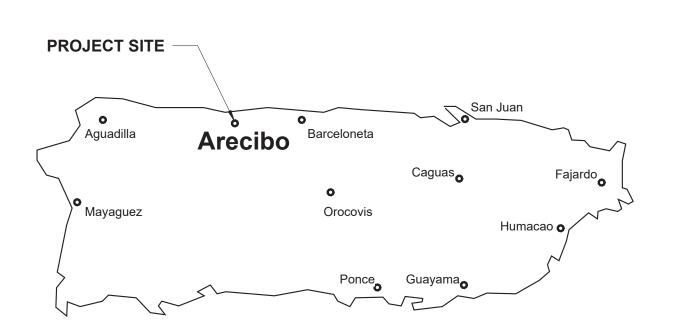





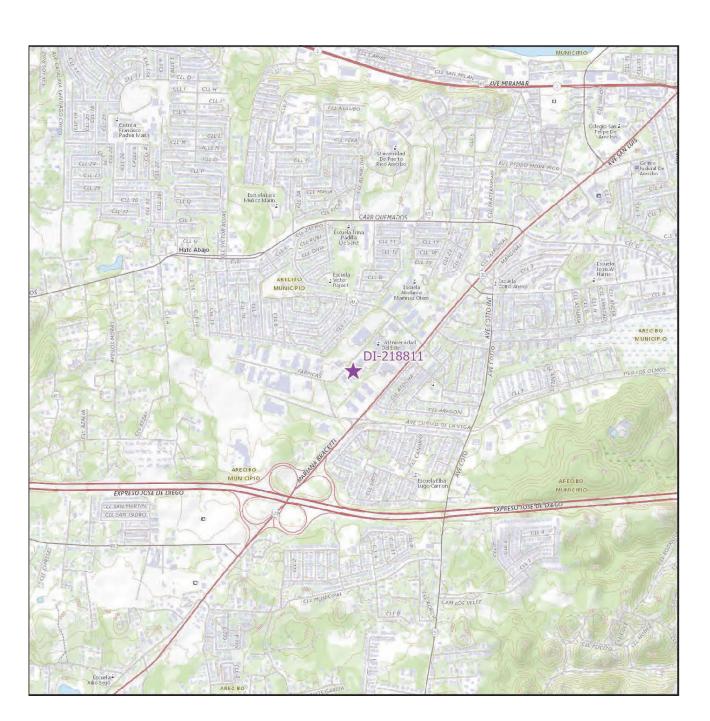

FLOOD MAP

AERIAL PHOTO 18.45882, -66.74318


LOCATION MAP SCALE 1: 20,000

IND	INDEX OF DRAWINGS - PW 8144, DI 218811						
	Sheet	Current					
Discipline	Number	Revision	Sheet Name				
00-GENERAL	5GI001		COVER SHEET - DI 218811				
00-GENERAL	5GI002		GENERAL NOTES, ABBREVIATIONS AND LEGEND				
03-ARCHITECTURAL	5AE101		SITE PLAN BUILDING T082506700 DI 218811				
05-DETAILS	5DT501		DETAILS AND SPECIFICATIONS				
OF DETAIL C	CDTCOO		DETAIL C AND ODECIFICATIONS				

PRIDCO-FEMA 4339 DR PROGRAM NORTH REGION STAGE 1 BID PACKAGE N1-3

5. PW: 8144 | DI: 218811 | Bldg: T082506700

Road PR-128, Km. 40.9, Lot #24, Zeno Gandia Industrial Park, Arecibo, Puerto Rico, 00612

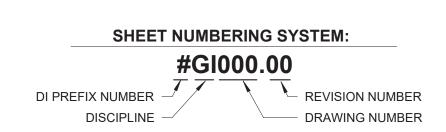





COVER SHEE	T - DI 218811
SCALE:	
AS SI	HOWN
DELIVERY DATE:	PROJECT NUMBER 21-0258-02
PRINT DATE & TIME: 4/22/2024 3:28:49 PM	BIM FILE NAME:

THE INTERNATIONAL BUILDING CODE 2018 AMERICAN INSTITUTE FOR STEEL CONSTRUCTION (AISC), STEEL CONSTRUCTION MANUAL, 15 TH EDITION

AMERICAN CONCRETE INSTITUTE (ACI), BUILDING CODE REQUIREMENTS FOR STRUCTURAL CONCRETE, ACI 318-14. AMERICAN SOCIETY OF CIVIL ENGINEERS, MINIMUM DESIGN LOADS AND ASSOCIATED CRITERIA FOR BUILDINGS AND OTHER STRUCTURES, ASCE/SEI 7-16

STRUCTURAL NOTES ON CONCRETE REPAIR:

ALL CONCRETE REPAIR WORKS SHALL BE PERFORMED FOLLOWING THE GUIDELINES OF THE INTERNATIONAL CONCRETE REPAIR INSTITUTE (ICRI). HIRING A PROFESSIONAL EXPERIENCED IN THIS TYPE OF REPAIR IS RECOMMENDED TO ENSURE A PROPER

FOR THE REPAIR OF AREAS AFFECTED BY CORROSION, ICRI NO. 03730 GUIDELINE FOR SURFACE PREPARATION FOR THE REPAIR OF DETERIORATED CONCRETE RESULTING FROM REINFORCING STEEL CORROSION SHOULD BE FOLLOWED. BEFORE COMMENCING ANY CONCRETE REPAIR WORK, THE CONTRACTOR SHALL REVIEW THE REPAIR DETAILS PRESENTED IN THE DRAWINGS. IN CASE OF DOUBT WITH THE REPAIR DETAILS PRESENTED, THE CONTRACTOR SHOULD CONTACT THE

ARCHITECT OR ENGINEER OF RECORD TO CLARIFY THEM. IT IS IMPORTANT TO FOLLOW THE MANUFACTURER'S RECOMMENDATIONS FOR EACH PRODUCT UTILIZED FOR THIS JOB, IN ORDER TO GUARANTEE THAT THE REPAIR WORKS ARE CARRIED OUT ADEQUATELY.

<u>STRUCTURAL NOTES ON CAST-IN-PLACE CONCRETE:</u>

PORTLAND CEMENT SHALL BE TYPE II. ALL CONCRETE SHALL BE OF REGULAR WEIGHT (145 POUNDS PER CUBIC FOOT). THE FOLLOWING CONCRETE MIX PARAMETERS SHALL BE USED UNLESS OTHERWISE NOTED:

CONCRETE STRENGTH AT 28 DAYS – 3,000 PSI MAX. WATER/CEMENT RATIO - 0.65 RECOMMENDED SLUMP – 3 INCHES MAX. AGGREGATE SIZE (ASTM C33) - 1 INCH

PROVIDE CONCRETE MIXES DESIGNED BY A QUALIFIED TESTING LABORATORY FOR REVIEW AND APPROVAL BY THE STRUCTURAL ENGINEER. CONCRETE MIX DESING SHALL BE SIGNED AND SEALED BY A PROFESSIONAL ENGINEER AUTHORIZED TO EXERCISE THE PROFESSION IN THE COMMOM WEALTH OF PUERTO RICO.

NOTE ON REINFORCING STEEL BARS:

ALL REINFORCING STEEL SHALL BE NEW STOCK DEFORMED BARS CONFORMING TO ASTM A615, GRADE 60 (FY = 60 KSI). MAINTAIN THE FOLLOWING CONCRETE COVERAGE FOR REINFORCING STEEL UNLESS NOTED OTHERWISE:

CONCRETE CAST AGAINST EARTH: 3 INCHES

CONCRETE IN CONTACT WITH THE GROUND: 2 INCHES

CONCRETE SLAB AND WALLS WITHOUT CONTACT WITH GROUND: 1 INCHES

CONCRETE BEAMS AND COLUMNS: 1 1/2 INCHES

AWS STRUCTURAL WELDING CODE, D1.1.

STRUCTURAL STEEL

DESIGN, DETAIL AND ERECT STRUCTURAL STEEL ELEMENTS IN ACCORDANCE WITH THE FOLLOWING:

AISC SPECIFICATION FOR THE DESIGN, FABRICATION, AND ERECTION OF STRUCTURAL STEEL FOR BUILDINGS.

AISC MANUAL OF STEEL CONSTRUCTION, ALLOWABLE STRESS DESIGN. AISC CODE OF STANDARD PRACTICE FOR STEEL BUILDINGS AND BRIDGES.

STRUCTURAL STEEL SHALL CONFORM TO THE FOLLOWING GRADES:

W SHAPES: ASTM A992 (FY = 50 KSI, FU = 65 KSI) STEEL ANGLE, CHANNELS, PLATES: ASTM A36

BOLTS, NUTS AND WASHERS: HIGH-STRENGTH BOLTS, INCLUDING NUTS AND WASHERS: ASTM A325

STEEL PLATES FOR LANDINGS AND THREADS: 1/4" ANTI-SLIP DIAMOND TYPE STEEL PLATE A36

WELDING ELECTRODE FOR STEEL SHALL BE E70XX

PROVIDE DESIGN, FABRICATION, AND ERECTION OF METAL DECK CONFORMING TO THE STEEL DECK INSTITUTE'S "CODE OF FORM ROOF DECK FROM STEEL SHEETS CONFORMING TO ASTM A 611 GRADE C AND D OR A 653 OR HIGHER SPECIFICATIONS

WITH A MINIMUM YIELD STRENGTH OF 33 KSI. ATTACH SHEETS TO STEEL SUPPORT MEMBERS AS INDICATED AND IN ACCORDANCE WITH THE MANUFACTURER'S INSTRUCTIONS FOR INSTALLATION. WHEN DECK IS SCHEDULED TO BEEXPOSED, DE-SLAG, CLEAN AND TOUCH UP WELDS WITH A ZINC-RICH

LAP ROOF AND FLOOR DECK ENDS MINIMUM OF 2 INCHES. WHEN FASTENING DECK TO SUPPORT MEMBERS PROVIDE WELDING MATERIALS INSTALLATION PROCEDURES TO PREVENT BURNING OF HOLES IN DECK.

AT ENDS OF DECKS OR WHERE CHANGES OF DECK DIRECTION OCCUR, FASTEN TO SUPPORTS AT EACH FLUTE. PROVIDE ADEQUATE CLOSURES AND FASTENERS TO SIDES AT EIGHTEEN INCHES ON CENTER. WHERE PARTIAL PANELS MAY BE REQUIRED TO COMPLETE DECK INSTALLATION AT PERIMETER OF STRUCTURE, PROVIDE WELDS IN EACH FLUTE TO STRUCTURAL MEMBERS. INSTALL DECK IN THREE CONTINUOUS SPAN LENGTHS.

AT PERIMETER OF DECK, SECURE DECK TO STRUCTURAL MEMBERS WITH SAME ATTACHMENTAND SPACING SUPPORT ATTACHMENT AS INDICATED ON PLANS. HOT DIP GALVANIZE (G90) AFTER FABRICATION ALL METAL DECK AND TOUCH UP CONNECTIONS WITH A ZINC-RICH PRIMER.

NOTES (IF APPLICABLE):

TREE REMOVAL:

REMOVE ALL TREES INDICATED BY THE DRAWINGS AND SPECIFICATIONS, AS REQUIRING REMOVAL, IN A MANNER THAT WILL NOT DAMAGE ADJACENT TREES OR STRUCTURES OR COMPACTS THE SOIL.

REMOVE TREES THAT ARE ADJACENT TO TREES OR STRUCTURES TO REMAIN, IN SECTIONS, TO LIMIT THE OPPORTUNITY OF DAMAGE TO ADJACENT CROWNS, TRUNKS, GROUND PLANE ELEMENTS AND STRUCTURES. DO NOT DROP TREES WITH A SINGLE CUT UNLESS THE TREE WILL FALL IN AN AREA NOT INCLUDED IN THE TREE AND PLANT

PROTECTION AREA. NO TREE TO BE REMOVED WITHIN 50 FEET OF THE TREE AND PLANT PROTECTION AREA SHALL BE PUSHED OVER OR UP-ROOTED USING A PIECE OF GRADING EQUIPMENT. PROTECT ADJACENT PAVING, SOIL, TREES, SHRUBS, GROUND COVER PLANTINGS AND UNDERSTORY PLANTS TO REMAIN FROM

DAMAGE DURING ALL TREE REMOVAL OPERATIONS, AND FROM CONSTRUCTION OPERATIONS. PROTECTION SHALL INCLUDE THE ROOT SYSTEM, TRUNK, LIMBS, AND CROWN FROM BREAKAGE OR SCARRING, AND THE SOIL FROM COMPACTION. REMOVE STUMPS AND IMMEDIATE ROOT PLATE FROM EXISTING TREES TO BE REMOVED. GRIND TRUNK BASES AND LARGE BUTTRESS ROOTS TO A DEPTH OF THE LARGEST BUTTRESS ROOT OR AT LEAST 18 INCHES BELOW THE TOP MOST ROOTS WHICH EVER IS LESS AND OVER THE AREA OF THREE TIMES THE DIAMETER OF THE TRUNK (DBH).

FOR TREES WHERE THE STUMP WILL FALL UNDER NEW PAVED AREAS, GRIND ROOTS TO A TOTAL DEPTH OF 18 INCHES BELOW THE EXISTING GRADE. IF THE SIDES OF THE STUMP HOLE STILL HAVE GREATER THAN APPROXIMATELY 20% WOOD VISIBLE, CONTINUE GRINDING OPERATION DEEPER AND OR WIDER UNTIL THE RESULTING HOLE HAS LESS THAN 20% WOOD. REMOVE ALL WOOD CHIPS PRODUCED BY THE GRINDING OPERATION AND BACK FILL IN 8 INCH LAYERS WITH CONTROLLED FILL OF A QUALITY ACCEPTABLE TO THE SITE ENGINEER FOR FILL MATERIAL UNDER STRUCTURES, COMPACTED TO 95% OF THE MAXIMUM DRY DENSITY STANDARD PROCTOR. THE OWNER'S REPRESENTATIVE SHALL APPROVE EACH HOLE AT THE END OF THE GRINDING

IN AREAS WHERE THE TREE LOCATION IS TO BE A PLANTING BED OR LAWN, REMOVE ALL WOODCHIPS AND BACKFILL STUMP HOLES WITH PLANTING SOIL AS DEFINED IN SPECIFICATION SECTION PLANTING SOIL, IN MAXIMUM OF 12 INCH LAYERS AND COMPACT TO 80 - 85% OF THE MAXIMUM DRY DENSITY STANDARD PROCTOR.

PRUNING:

WITHIN SIX MONTHS OF THE ESTIMATED DATE OF SUBSTANTIAL COMPLETION, PRUNE ALL DEAD OR HAZARDOUS BRANCHES LARGER THAN 2 INCH IN DIAMETER FROM ALL TREES TO REMAIN. IMPLEMENT ALL PRUNING RECOMMENDATIONS FOUND IN THE ARBORIST REPORT.

DRIVES, OR PARKING AREAS AS FOLLOWS:

3. STREETS AND DRIVES - WITHIN 14 FEET VERTICALLY OF THE PROPOSED DRIVING SURFACE ELEVATION.

ALL PRUNING SHALL BE DONE IN ACCORDANCE WITH ANSI A300 (PART 1), ISA BMP TREE PRUNING (LATEST EDITION, AND THE "STRUCTURAL PRUNING: A GUIDE FOR THE GREEN INDUSTRY", EDWARD GILMAN, BRIAN KEMPF, NELDA MATHENY AND JIM CLARK, 2013 URBAN TREE FOUNDATION, VISALIA CA.

GENERAL DRAWING SYMBOLS: ABBREVIATIONS:

AIR CONDITIONING ALUMINUM CENTER TO CENTER CONCRETE MASONRY UNI CORRIDOR CORROSION ELEVATION FLOOR DRAIN FINISH FLOOR ELEVATIONS FINISH FLOOR LEVEL FINISH(ED) HARDWARE HEIGHT

JANITOR CLOSE

NOT IN CONTRAC

MECHANICAL

MINIMUM

MOUNTED

ROOF DRAIN

REQUIRED

STAINLESS STEEL

TOP OF MASONRY

TOP OF STEEL

DROP MANHOLE

VERIFY IN FIELD

TELEPHONE

STORM SEWER

STRUCTURAL

SMOOTH CEMENT PLASTE

UNLESS OTHERWISE NOTE

 DETAIL REFERENCE NUMBER DETAIL REFERENCE SYMBOL - SHEET WHERE DETAIL IS DRAWN ELEVATION REFERENCE NUMBER

SHEET WHERE ELEVATION IS DRAWN SECTION REFERENCE NUMBER GENERAL BUILDING SECTION

NORTH ARROW

AXIS SYMBO

KEY NOTE

EQUIPMENT SYMBO

LEVEL SYMBOL

RISER SYMBOL

ROOM NUMBER

ROOM IDENTIFICATION

HANDICAPPED SYMBOL

NEW CONCRETE BLOCK WALL 6" OR 8"

NEW PLYCEM BOARD WALL

- SHEET WHERE SECTION IS DRAWN WALL SECTION REFERENCE NUMBER WALL SECTION

ONDITION BELOW, ABOVE OR

BEHIND AS INDICATED.

- SHEET WHERE INT. ELEV. IS DRAWN INTERIOR ELVATION SYMBOL **ELEVATION REFERENCE NUMBER**

T.O.S.

THIS DOCUMENT REPRESENTS THE IDEAS AND EFFORTS OF CSA ARCHITECTS AND ENGINEERS. IT SHALL BE USED ONLY BY AUTHORIZED PERSONS AND SHALL NOT BE REPRODUCED OR EXHIBITED WITHOUT WRITTEN CONSENT OF CSA ARCHITECTS AND ENGINEERS.

PUERTO RICO INDUSTRIAL DEVELOPMENT COMPANY PRIDCO

ISSUE FOR BID

FEBRUARY 21, 2024


DISCIPLINE INFORMATION: ANNETTE ALFONSO JOHANNA SALCEDO

PROFESSIONAL'S STATEMENT: YO, ANNETTE ALFONSO

CERTIFICO QUE SOY EL PROFESIONAL QUE [CONFECCIONÓ, DISEÑÓ O PREPARÓ] ESTOS PLANOS TAMBIÉN, CERTIFICO QUE ENTIENDO QUE DICHOS PLANOS Y ESPECIFICACIONES CUMPLEN CON LAS DISPOSICIONES APLICABLES DEL REGLAMENTO CONJUNTO Y LAS DISPOSICIONES APLICABLES DE LOS REGLAMENTOS Y CÓDIGOS DE CONSTRUCCIÓN VIGENTES DE LAS AGENCIAS. JUNTAS REGLAMENTADORAS O CORPORACIONES PÚBLICAS CON JURISDICCIÓN. CERTIFICO, ADEMÁS, QUE EN LAPREPARACIÓN DE ESTOS PLANOS Y ESPECIFICACIONES SE HA CUMPLIDO CABALMENTE CON LO DISPUESTO EN LA LEY NÚM. 14 DE 8 DE ENERO DE 2004. SEGÚN ENMENDADA, CONOCIDA COMO LA "LEY PARA LA INVERSIÓN POR LA INDUSTRIA PUERTORRIQUEÑA" Y CON LA [LEY NÚM. 319 DE 15 DE MAYO DE 1938, SEGÚN ENMENDADA; LEY NÚM. 96 DE 6 DE JULIO DE 1978, SEGÚN ENMENDADA: SEGÚN APLIQUEI, RECONOZCO QUE CUALQUIER DECLARACIÓN FALSA O FALSIFICACIÓN DE LOS HECHOS QUE SE HAYA PRODUCIDO POR DESCONOCIMIENTO O POR NEGLIGENCIA YA SEA POR MÍ, MIS AGENTES O EMPLEADOS, O POR OTRAS PERSONAS CON MI CONOCIMIENTO. ME HACEN RESPONSABLE DE CUALQUIER ACCIÓN JUDICIAL Y

PRIDCO DAMAGE IMPROVEMENTS **NORTH REGION STAGE 1 BID PACKAGE N1-3** PW: 8144 / ARECIBO

DISCIPLINARIA POR LA OGPE.

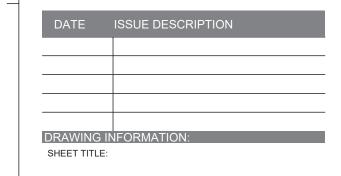

GENERAL NOTES, ABBREVIATIONS AND LEGEND

AS SHOWN

DELIVERY DATE PROJECT NUMBER: 21-0258-02 PRINT DATE & TIME: BIM FILE NAME: 4/22/2024 3:28:50 PM DRAWING / MODEL LOCATION:

PLUMBING CODE 2018, PR EXISTING BUILDING CODE 2018, ICC SUITE CODES 2018, AND WITH OTHER CODES, STANDARDS, AND REGULATIONS CALLED FOR IN SAID CODES

PERFORM WORK IN ACCORDANCE WITH OSHA RULES AND REGULATIONS.

COMPLY WITH THE REQUIREMENTS SET FORTH BY THE PR BUILDING

CODE 2018, PR FIRE CODE 2018, PR MECHANICAL CODE 2018, PR

COMPLY WITH APPLICABLE RULES AND REGULATIONS FOR OBTAINING NECESSARY AND REQUIRED INSPECTIONS, APPROVALS AND PERMITS NECESSARY TO PERFORM WORK AND SERVICES FOR THE PROJECT. EXECUTE WORK IN ACCORDANCE WITH THE BEST ACCEPTED TRADE

GENERAL NOTES

AND IN A CAREFUL AND ORDERLY MANNER WITH THE LEAST POSSIBLE NOISE, DUST, OR DISTURBANCE TO OCCUPANTS. IMPLEMENT SAFETY CONTROLS DURING DEMOLITION/CONSTRUCTION

PRACTICES, AS PER MANUFACTURER'S WRITTEN RECOMMENDATIONS,

DAILY REMOVE DEBRIS RESULTING FROM DEMOLITION/CONSTRUCTION AND TRANSPORT IT OUT OF PROJECT LIMITS. PERFORM DISPOSAL OPERATION IN ACCORDANCE WITH GOVERNMENT APPROVALS AND REGULATIONS. SITE AND STRUCTURE SHALL BE LEFT BROOM CLEAN FOR

SUBSTANTIAL COMPLETION. DO NOT SCALE DRAWINGS. VERIFY DIMENSIONS IN THE FIELD BEFORE PROCEDING WITH ANY PORTION OF THE WORK. ADVISE IN WRITING TO CONSTRUCTION MANAGER AND ARCHITECT OF DISCREPANCY BETWEEN EXISTING CONDITIONS AND DRAWINGS.

REPORT TO CONSTRUCTION MANAGER AND ARCHITECT DISCREPANCIES IN THE CONTRACT DRAWINGS, SPECIFICATIONS OR DETAILS PRIOR TO COMMENCING THE WORK.

COORDINATE CIVIL. MECHANICAL. ELECTRICAL. ARCHITECTURAL AND STRUCTURAL REQUIREMENTS FOR PROPER LOCATION AND PROVISIONS OF SLEEVES, INSERTS, OPENINGS AND ROUGH-IN REQUIRED CONDUCT DEMOLITION/CONSTRUCTION OPERATION TO INSURE MINIMUM

INTERFERENCE WITH ROADS, STREETS, SIDEWALKS AND OTHER ADJACENT FACILITIES. THE USE OF A BRAND NAME AND/OR MODEL NUMBER TO DENOTE PRODUCTS, EQUIPMENTS, MATERIALS, OR PROCESS, IS INTENDED TO ESTABLISH A STANDARD OF QUALITY AND SHALL NOT BE CONSTRUED AS

LIMITING COMPETITION. DO NOT COMMENCE ANY DEMOLITION OF SITE ELEMENTS OR STRUCTURE UNTIL THE HAZARDOUS MATERIAL ABATEMENT IS DONE AND EPA CERTIFICATION IS OBTAINED, STATING THAT THE SITE ELEMENTS AND STRUCTURES ARE FREE OF HAZARDOUS MATERIALS. PRIOR TO COMMENCEMENT OF THE HAZARDOUS MATERIAL ABATEMENT THE

BUILDING AND SITE SHALL BE VACANT. SPECIFIED TREE PRUNING OR CUTTING OR INCIDENTAL TO OTHER REPAIR WORK MAY REQUIRE A DRNA PERMIT. THE CONTRACTOR IS RESPONSIBLE FOR OBTAINING PERMIT BEFORE PERFORMING THE WORK.

PRESSURE WASH, MINIMUM 3,000 PSI, EXISTING BUILDING EXTERIOR WALLS, WINDOWS, AND DOORS BEFORE BEGINNING SPECIFIED WORK. REPAIR INTERIOR AND EXTERIOR WALL SURFACES WITH CEMENT PLASTER PRIOR TO APPLYING PAINT FINISH. REPAIR WORK INCLUDES, BUT IS NOT LIMITED TO CUT AND PATCHING, REMOVAL OF NAILS AND SCREWS FROM WALLS, REPAIR OF MAJOR IMPERFECTIONS ON

WALLS AND FINISHES IN GENERAL FULL TEAR-OFF OF ROOF WATERPROOFING SYSTEM INCLUDING MEMBRANE, INSULATION AND FLASHINGS WHERE SYSTEM REPLACEMENT IS SPECIFIED. A ROOF MOISTURE SURVEY MAY BE REQUIRED PRIOR TO INSTALLATION OF NEW MEMBRANE

CLEAN, REPAIR AND VERIFY STRUCTURAL INTEGRITY OF ROOF DECK PRIOR THE INSTALLATION OF THE WATERPROOFING SYSTEM. COMPLY WITH THE MANUFACTURER RECOMMENDATIONS FOR THE INSTALLATION OF ROOF MEMBRANE TO VALIDATE THE WARRANTY.

ELECTRICAL GENERAL NOTES

NO WIRE SHALL BE SMALLER THAN # 12 AWG THHN, 600 VOLTS NO CONDUIT SHALL BE SMALLER THAN 3/4"

ALL CONDUIT SHALL BE RIGID GALVANIZED EXCEPT OTHERWISE ALL WIRE SHALL BE COPPER, INSULATED AS NOTED. LEAVE A #12 AWG GALVANIZED FISH WIRE IN ALL EMPTY CONDUITS.

ALL UNDERGROUND CONDUITS SHALL BE PROTECTED WITH 4" CONCRETE

EXPANSION FITTINGS SHALL BE USED FOR EVERY CONDUIT CROSSING BUILDING EXPANSION JOINTS.

CONTRACTOR SHALL BALANCE ALL LOADS. PROVIDE A #12 GREEN THW BONDING JUMPER BETWEEN EACH OUTLET BOX AND RECEPTACLE GROUNDING TERMINAL, USE 3/8" LONG 10-32 GROUNDING SCREW

ALL INSTALLATIONS SHALL BE EXPOSED UNLESS OTHERWISE INDICATED. EXPOSED CONDUITS SHALL BE SUPPORTED BY MEANS OF ONE BOLT CLAMP SPACED NOT FURTHER THAN 7'-6" APART AN EXPOSED WORK CONDULET SHALL BE USED FOR ALL 90 BENDS.

ALL NON-GALVANIZED METAL PARTS SHALL BE GIVEN ONE COAT OF RED OXIDE AND TWO COATS OF METALLIC GRAY PRIOR TO INSTALLATION. ALL GALVANIZED RIGID CONDUITS FOR TOGGLE SWITCHES AND RECEPTACLES LOCATED AT DOORWAYS AND LEAN - TO SHALL BE CONCEALED WITHIN ROOF SLAB, WALLS AND OVERHANGS.

CONTRACTOR SHALL PROVIDE ELECTRICAL SERVICE TO TEST ALL ELECTRICAL SYSTEM IN PRESENCE OF THE REPRESENTATIVE FROM THE MECHANICAL AND ELECTRICAL DEPARTMENT ALL LIGHTING CIRCUITS SHALL HAVE ONE (1) PORCELAIN LIGHT SOCKET

SWITCHES AND RECEPTACLES SHALL BE INSTALLED 4'-0" A.F.F. THE NEUTRAL WIRES SHALL BE IDENTIFIED THROUGHT THE INSTALLATION BY THE USE OF WHITE COLOR COVERED LIVE WIRES WITHIN THE SAME CONDUIT SHALL BE COLOR CODED AS PER N.E.C.

WITH A LED TYPE BULB, EQUIVALENT TO 100W INCANDESCENT LUMENS.

RECEPTACLES AND LIGHTING CIRCUITS SHALL BE #12 THHN WIRE AND SHALL BE CONNECTED TO 20 AMP BREAKERS AT THE PANELBOARD. ALL OVERHANGS AND LEAN - TO'S SHALL BE PROVIDED WITH LIGHT SOCKETS

SUBMITTING BIDS ALL SWITCHES AND RECEPTACLES THAT ARE CONCEALED IN WALLS AND OVERHANGS SHALL BE PROVIDED WITH STAINLESS STEEL COVERS. CONTRACTOR SHALL CONTACT THE DISTRICT ENGINEER OF LUMA PRIOR | 12.

CONTRACTOR SHALL VERIFY LENGTH OF FEEDERS IN THE FIELD BEFORE

TO THE BEGINNING OF THE WORK AND COORDINATE WITH THEM FOR THE EXECUTION OF THE WORK CONCERNING THE SERVICE ENTRANCE AND SUBSTATION IF REQUIRED. IN ADDITION, THE CONTRACTOR SHALL OBTAIN | 13. A CERTIFICATE OF INSPECTION AT THE COMPLETION OF THE WORK AND SHALL FORWARD IT TO THE PUERTO RICO INDUSTRIAL DEVELOPMENT COMPANY.

ALL INSTALLATIONS SHALL BE IN ACCORDANCE WITH THE LATEST RULES AND REGULATIONS OF THE N.E.C. AND LUMA.

ALL BOXES FOR RECEPTACLES & LIGHTING SWITCHES FOR EXPOSED INSTALLATION SHALL BE "FS" TYPE.

CONTRACTOR SHALL SUBMIT A LIST OF MATERIALS AND EQUIPMENT GIVING MANUFACTURER CATALOG NUMBERS AND COMPLETE SPECIFICATIONS AND DRAWINGS FOR APPROVAL OF P.R.I.D.C.O. PRIOR TO THE PURCHASING OF SAID MATERIALS AND/OR EQUIPMENT.

PLUMBING GENERAL NOTES:

PLUMBING SHALL BE IN STRICT ACCORDANCE WITH THE 2018 PUERTO RICO BUILDING CODE. FURNISH AND SET IN PLACE BEFORE CONCRETE POURING ALL NECESSARY SLEEVES FOR WASTE OR SOIL, VENT, HOT, AND COLD WATER LINES, THESE SLEEVES SHALL BE AS SPECIFIED OR REQUIRED BY THE

THE PLUMBING DRAWING IS GENERALLY DIAGRAMATTIC AND INDICATIVE OF THE WORK TO BE INSTALLED. RUN ALL PIPING CONCEALED WHEREVER POSSIBLE UNLESS OTHERWISE NOTED.

SIZES SHOWN IN FIXTURE SCHEDULE ARE MINIMUM AND SHALL BE INCREASED AS NECESSARY TO COMPLY WITH CODE REQUIREMENTS OR AS SHOWN ON DRAWINGS.

BEFORE CONSTRUCTION VERIFY EXISTING ELEVATIONS AGAINST PROPOSED SLOPES. ANY DISCREPANCIES SHALL BE BROUGHT TO THE ATTENTION OF THE ARCHITECT. CLEANOUT SHALL BE OF SAME SIZE AS THE PIPES TO WHICH THEY ARE CONNECTED UP TO 4", FOR LARGE

PIPES; CLEANOUT SHALL BE 4". UNLESS OTHERWISE INDICATED, ALL DRAINAGE PIPING 3" AND SMALLER SHALL BE SLOPED 1/4" PER FT., LARGER PIPES SHALL BE SLOPED 1/8"PER FOOT.

CLEANOUT SHALL BE NOT MORE THAN 50 FEET AP-ART IN HORIZONTAL DRAINAGE LINES OF 4" NOMINAL DIAMETER OR LESS AND NOT MORE THAN 100 FEET APART FOR LARGER PIPES.

FOR FIXTURES AND EQUIPMENT NOT LISTED IN SCHEDULE, SEE CONTRACT SPECIFICATIONS.

DETERMINE EXACT LOCATION OF THE PIPING TO AVOID ANY INTERFERENCE WITH PIPING AND/OR EQUIPMENT BEING INSTALLED BY ANOTHER SUB-CONTRACTOR. SANITARY TEES (SINGLE AND DOUBLE) AND QUARTER BENDS SHALL BE ACCEPTABLE ONLY FOR CHANGES OF

DIRECTION FROM HORIZONTAL TO VERTICAL

USE LONG SWEEPING FITTINGS AND/OR LONG SWEEP BENDS AT BASE OF ALL STACKS. PROVIDE ROUGHING-IN AND INSTALL ALL PLUMBING FIXTURES AND/OR EQUIPMENT WHICH ARE SUPPLIED BY

FOR ALL UNDERGROUND SANITARY AND STORM DRAINAGE USE: PVC POLYVINYL CHLORIDE) SEWER PIPE AND FITTING: ASTM D 3034, SDR-35, FOR SOLVENT CEMENT OR ELASTOMERIC GASKET JOINTS. A. SOLVENT CEMENT

ASTM D 2564 B. GASKETS: ASTM F 477, ELASTOMERIC SEAL. PROVIDE ALL PIPE OPENINGS THROUGH SLABS WITH SLEEVES HAVING AN INTERNAL DIAMETER AT LEAST 1" LARGER THAN THE OUTSIDE DIAMETER OF UN-INSULATED PIPES OR OF THE INSULATION FOR INSULATION

SERVICES. FLOOR SLEEVES ARE TO PROJECT 2" ABOVE FINISHED FLOORS.

SLEEVES SHALL BE SCHEDULES 40 GALVANIZED STEEL PIPE. BOTTOM OF THE WATER SERVICES LINE SHALL BE 12 INCHES ABOVE THE HIGHEST POINT OF THE SEWER LINE WHENEVER THE HORIZONTAL DISTANCE BETWEEN THEM IS LESS THAN 5 FT.

PROVIDE DOWNSPOUT NOZZLES (SIMILAR TO JAY R. SMITH FIG 1770) AT THE OVERFLOW RAIN WATER OUTLETS,

CONTRACTOR SHALL SUPPLY AND INSTALL 1/4 TURN SHUT OFF VALVES AT EVERY PLUMBING FIXTURE.

BE FURNISHED AND INSTALLED BY THE CONTRACTOR.

ALL PLUMBING FIXTURES, COLORS AND FINISHES, SELECTION BY ARCHITECT

HVAC GENERAL NOTES:

SUPPLY AND INSTALL ALL ELECTRICAL CONTROLS, SAFETY SWITCHES AND ACCESSORIES NOT INDICATED IN THE ELECTRICAL DRAWING AND NECESSARY FOR THE PROPER OPERATION OF THE EQUIPMENT IN

ACCORDANCE WITH THE MECHANICAL EQUIPMENT RECOMMENDATIONS AND THE NATIONAL ELECTRIC CODE. PERFORM ALL WIRING AND CONNECTION (POWER AND CONTROL) NOT INDICATED IN THE ELECTRICAL DRAWINGS AND NECESSARY FOR THE PROPER OPERATION OF THE

MECHANICAL EQUIPMENT IN STRICT ACCORDANCE WITH THE NATIONAL ELECTRIC CODE

TAKE EVERY PRECAUTION IN ORDER TO MINIMIZE OR ELIMINATE THE TRANSMISSION OF NOISE OR VIBRATION FROM THE EQUIPMENT, PIPING SYSTEM OR DUCT SYSTEM TO THE CONDITIONING SPACE.

EQUIPMENT, MATERIALS AND ACCESSORIES SHALL BE SIMILAR TO THE INDICATED SPECIFICATION AND/OR MANUFACTURER MODEL OR CATALOG NUMBER. UNLESS OTHERWISE NOTED IN DRAWINGS AND/OR SPECIFICATIONS ALL EQUIPMENT AND ACCESSORIES SHALL

OPERATION

CIVIL SITE GENERAL NOTES ALL DISTANCES AND ELEVATIONS ARE EXPRESSED IN METERS UNLESS OTHERWISE SPECIFIED.

ELEVATIONS ARE REFERRED TO MEAN SEA LEVEL. COORDINATES ARE BASED ON THE LAMBERT PROJECTION FOR PUERTO RICO AND THE US VIRGIN ISLAND AND REFERENCED TO THE NORTH AMERICAN DATUM OF 1983 (NAD83 NA2011) EPOCH 2010.00 ADJUSTED IN

THE CONTRACTOR SHALL COORDINATE WITH THE CONSTRUCTION MANAGER BEFORE CUTTING OR TRIMMING EXISTING TREES AFFECTED BY THE CONSTRUCTION. THE CONTRACTOR SHALL PREPARE AND SUBMIT FOR EACH PROJECT AREA, THE CONTROL OF EROSION AND

SEDIMENTATION (CES) PLAN FOR APPROVAL BY THE PERTINENT AGENCY AND THE CONSTRUCTION MANAGER.

THE CONTRACTOR SHALL PROVIDE AND MAINTAIN A DEWATERING SYSTEM TO KEEP SUBGRADES DRY AND CONVEY GROUND WATER AWAY FROM EXCAVATIONS. THE DEWATERING PLAN SHALL BE SUBMITTED TO THE CONSTRUCTION MANAGER FOR APPROVAL AND COORDINATION. DEWATERING PLANS SHALL INCLUDE CONTROL OF EROSION AND SEDIMENTATION FOR EACH PROJECT

PHASE AND/OR WORK AREA. THE WATER FROM THE DEWATERING SYSTEM SHALL BE FREE OF SEDIMENT AND/OR DEBRIS BEFORE ANY DISPOSAL. THE CONTRACTOR SHALL MAINTAIN THE DEWATERING SYSTEM UNTIL DEWATERING IS NO LONGER

SANITARY AND POTABLE WATER FOR APPROVAL OF THE CONSTRUCTION MANAGER.

ELECTRICAL, COMMUNICATION, SANITARY AND POTABLE WATER SERVICE SHALL NOT BE INTERRUPTED DURING CONSTRUCTION. IF NECESSARY, A PROVISIONAL TEMPORARY SERVICE AND/OR BY-PASS SHALL BE INSTALLED TO MAINTAIN SERVICE. PROVISIONAL TEMPORARY SERVICE AND/OR BY-PASS SHALL BE SUBMITTED TO THE CONSTRUCTION MANAGER FOR APPROVAL AND COORDINATION PRIOR TO CONSTRUCTION. THE CONTRACTOR SHALL PREPARE AND SUBMIT THE MAINTENANCE OF SERVICE PLAN FOR ELECTRICAL

THE CONTRACTOR SHALL NOTIFY THE CONSTRUCTION MANAGER IF ANY ELEMENT SUSPECTED OF CONTAINING HAZARDOUS MATERIAL IS ENCOUNTERED, PRIOR TO ANY RELATED WORK ACTIVITY. THE CONTRACTOR SHALL VISIT THE PROJECT AREA TO VERIFY THE SPACE LIMITATIONS FOR CONSTRUCTION PROCESS AND EQUIPMENT. THE CONTRACT PRICE SHALL CONSIDER THE REQUIRED CONSTRUCTION PROCESS AND/OR EQUIPMENTS.

PRIOR TO COMMENCEMENT OF THE WORK, CONTRACTOR SHALL VERIFY ALL DIMENSIONS AND EXISTING CONDITIONS AT PROJECT SITE AND SHALL NOTIFY THE CONSTRUCTION MANAGER OF ANY DISCREPANCIES BETWEEN EXISTING CONDITIONS AND CONTRACT DOCUMENTS THAT COULD AFFECT CONSTRUCTION WORK SCHEDULE AND /OR PERFORMANCE. ALL DETAILS, SECTIONS AND NOTES SHOWN ON DRAWINGS ARE INTENDED TO BE TYPICAL AND SHALL APPLY TO

SIMILAR SITUATIONS ELSEWHERE UNLESS OTHERWISE NOTED. THE CONTRACTOR SHALL REPAIR OR REPLACE EXISTING FACILITIES DAMAGED DURING CONSTRUCTION PRIOR TO SUBSTANTIAL COMPLETION THE CONTRACTOR SHALL MAINTAIN IN OPERATION EXISTING FACILITIES UNTIL NEW FACILITIES ARE IN


PRUNE ANY LOW, HANGING BRANCHES AND VINES FROM EXISTING TREES AND SHRUBS THAT OVERHANG WALKS, STREETS AND

1. WALKS - WITHIN 8 FEET VERTICALLY OF THE PROPOSED WALK ELEVATION.


2. PARKING AREAS - WITHIN 12 FEET VERTICALLY OF THE PROPOSED PARKING SURFACE ELEVATION.

PERFORM OTHER PRUNING TASK AS INDICATED ON THE DRAWINGS OR REQUESTED BY THE OWNER'S REPRESENTATIVE. WHERE TREE SPECIFIC DISEASE VECTORS REQUIRE, STERILIZE ALL PRUNING TOOLS BETWEEN THE WORK IN INDIVIDUAL TREES.

			CONSTRI	UCTION KEY	/ NOTES S	CHEDIII E I	5 N 218811	_	
	#ID	TYPE OF DAMAGE	DESCRIPTION			DETAIL	TECHNICAL SPECIFICATIONS	РНОТО	CSAGROUP EST-195
telefinething.	1	PA - Public Assistance	Exterior, Roof: Remove and replace exhaust far (aluminum roof far extractor cap with gravity self acting back draft damper face-flush install), 36in Fan Size, 1-HP Motor, 115/230V).	5 FT x 5 FT	2 EA	1/5DT501 4/5DT501		2023-05-1E FI -13-52 FR 1505cs no. 43998 Areals Runtle Rico 00612 Untite States Audie 33 Ometer Speed 3 1km/h	THIS DOCUMENT REPRESENTS THE IDEAS AND EFFORTS OF CSA ARCHITECTS AND ENGINEERS. IT SHALL BE USED ONLY BY AUTHORIZED PERSONS AND SHALL NOT BE REPRODUCED OR EXHIBITED WITHOUT WRITTEN CONSENT OF CSA ARCHITECTS AND ENGINEERS. FOR: PUERTO RICO INDUSTRIAL DEVELOPMENT COMPANY PRIDCO
A. I. R. Fr. Bardon S. C. Elgart	2	HM - Hazard Mitigation	protect exhaust fans from high wind pressure.	-	2 EA	2/5DT501 3/5DT501	233416	2073-05-16 F1-F3-52 R 1500 Cc 66 243988 -	ISSUE FOR BID FEBRUARY 21, 2024 REV DATE DESCRIPTION
September 1997 (1997)	3	AD - Additional Damages	Exterior, Roof: Installation of equipment-anchor ng assembly to protect exhaust fans from high wind pressure. Exterior, Site:	-	2 EA	2/5DT501 3/5DT501	323113	2023-05-15 T 18-458690-06-2-51 Educes Aresbu Piseria Roon livis 17 Unios Status Altitude, 37 Amelor Spiece 4-7xm/s	C DISCIPLINE INFORMATION: PRIME PROFESIONAL:
	4	AD - Additional Damages	Remove and dispose damaged material, install new chain link fence (Galv. Ga. No. 9, Post- 2 1/2" diam. galv., 3-strands barbed wire (4-point)).	80 LF L x 6 FT H	80 LF	1/5DT502	323113	Aveeba Puerto Roo 00019 United States Abludo 32 minut Special 1 min	ANNETTE ALFONSO PROFESSIONAL OF RECORD: ANNETTE ALFONSO STAFF DESIGNER: JOHANNA SALCEDO Q.C. AUDITOR: PRINCIPAL CAD TECHNICIAN: PROFESSIONAL'S STATEMENT: YO, ANNETTE ALFONSO NUM. LIC. 12304
de la company de	NOTE: S	SEE GENERAL NO	TES, ITEM #7 IN 5GI002		DETAIL NUMBE	1 / <u>DT501</u>	- SHEET WHERE DETAIL RESIDES		CERTIFICO QUE SOY EL PROFESIONAL QUE [CONFECCIONÓ, DISEÑO O PREPARÓ] ESTOS PLANO Y LAS ESPECIFICACIONES COMPLEMENTARIAS. TAMBIÉN, CERTIFICO QUE ENTIENDO QUE DICHOS PLANOS Y ESPECIFICACIONES CUMPLEN CON LAS DISPOSICIONES APLICABLES DEL REGLAMENTO CONJUNTO Y LAS DISPOSICIONES APLICABLES DE LOS REGLAMENTOS Y CÓDIGOS DE CONSTRUCCIÓN VIGENTES DE LAS AGENCIAS, JUNTAS REGLAMENTADORAS O CORPORACIONES PÚBLICAS CON JURISDICCIÓN. CERTIFICO, ADEMÁS, QUE EN LAPREPARACIÓN DE ESTOS PLANOS Y ESPECIFICACIONES SE HA CUMPLIDO CABALMENTE CON LO DISPUESTO EN LA LEY NÚM. 14 DE 8 DE ENERO DE 2004, SEGÚN ENMENDADA, CONOCIDA COMO LA "LEY PARA LA INVERSIÓN POR LA INDUSTRIA PUERTORRIQUEÑA" Y CON LA [LEY NÚM. 319 DE 15 DE MAYO DE 1938, SEGÚN ENMENDADA; ENMENDADA; SEGÚN APLIQUE]. RECONOZCO QUE CUALQUIER DECLARACIÓN FALSA O FALSIFICACIÓN DE LOS HECHOS QUE SE HAYA PRODUCIDO POR DESCONOCIMIENTO O POR NEGLIGENCIA YA SEA POR MÍ, MIS AGENTES O EMPLEADOS, O POR OTRAS PERSONAS CON MI CONOCIMIENTO, ME HACEN RESPONSABLE DE CUALQUIER ACCIÓN JUDICIAL Y DISCIPLINARIA POR LA OGPE.
							(1 of 2)		PROJECT: PRIDCO DAMAGE IMPROVEMENTS NORTH REGION STAGE 1 BID PACKAGE N1-3 PW: 8144 / ARECIBO DATE ISSUE DESCRIPTION
2 SITE PLAN DI 218811							Parcela: 030-022 Procedencia: 03 Dueño: Dirección física: Cabida escritura Area de mapa: 6	0-022-014-11 : N/D	DRAWING INFORMATION: SHEET TITLE: SITE PLAN BUILDING T082506700 DI 218811 A SCALE: AS SHOWN DELIVERY DATE: PROJECT NUMBER: 21-0258-02 PRINT DATE & TIME: 4/22/2024 3:28:51 PM DRAWING / MODEL LOCATION:
							KEY PLAN N.T.S.	DI 218811	SHEET NO. 5AE101 OF
1 3			4				5		

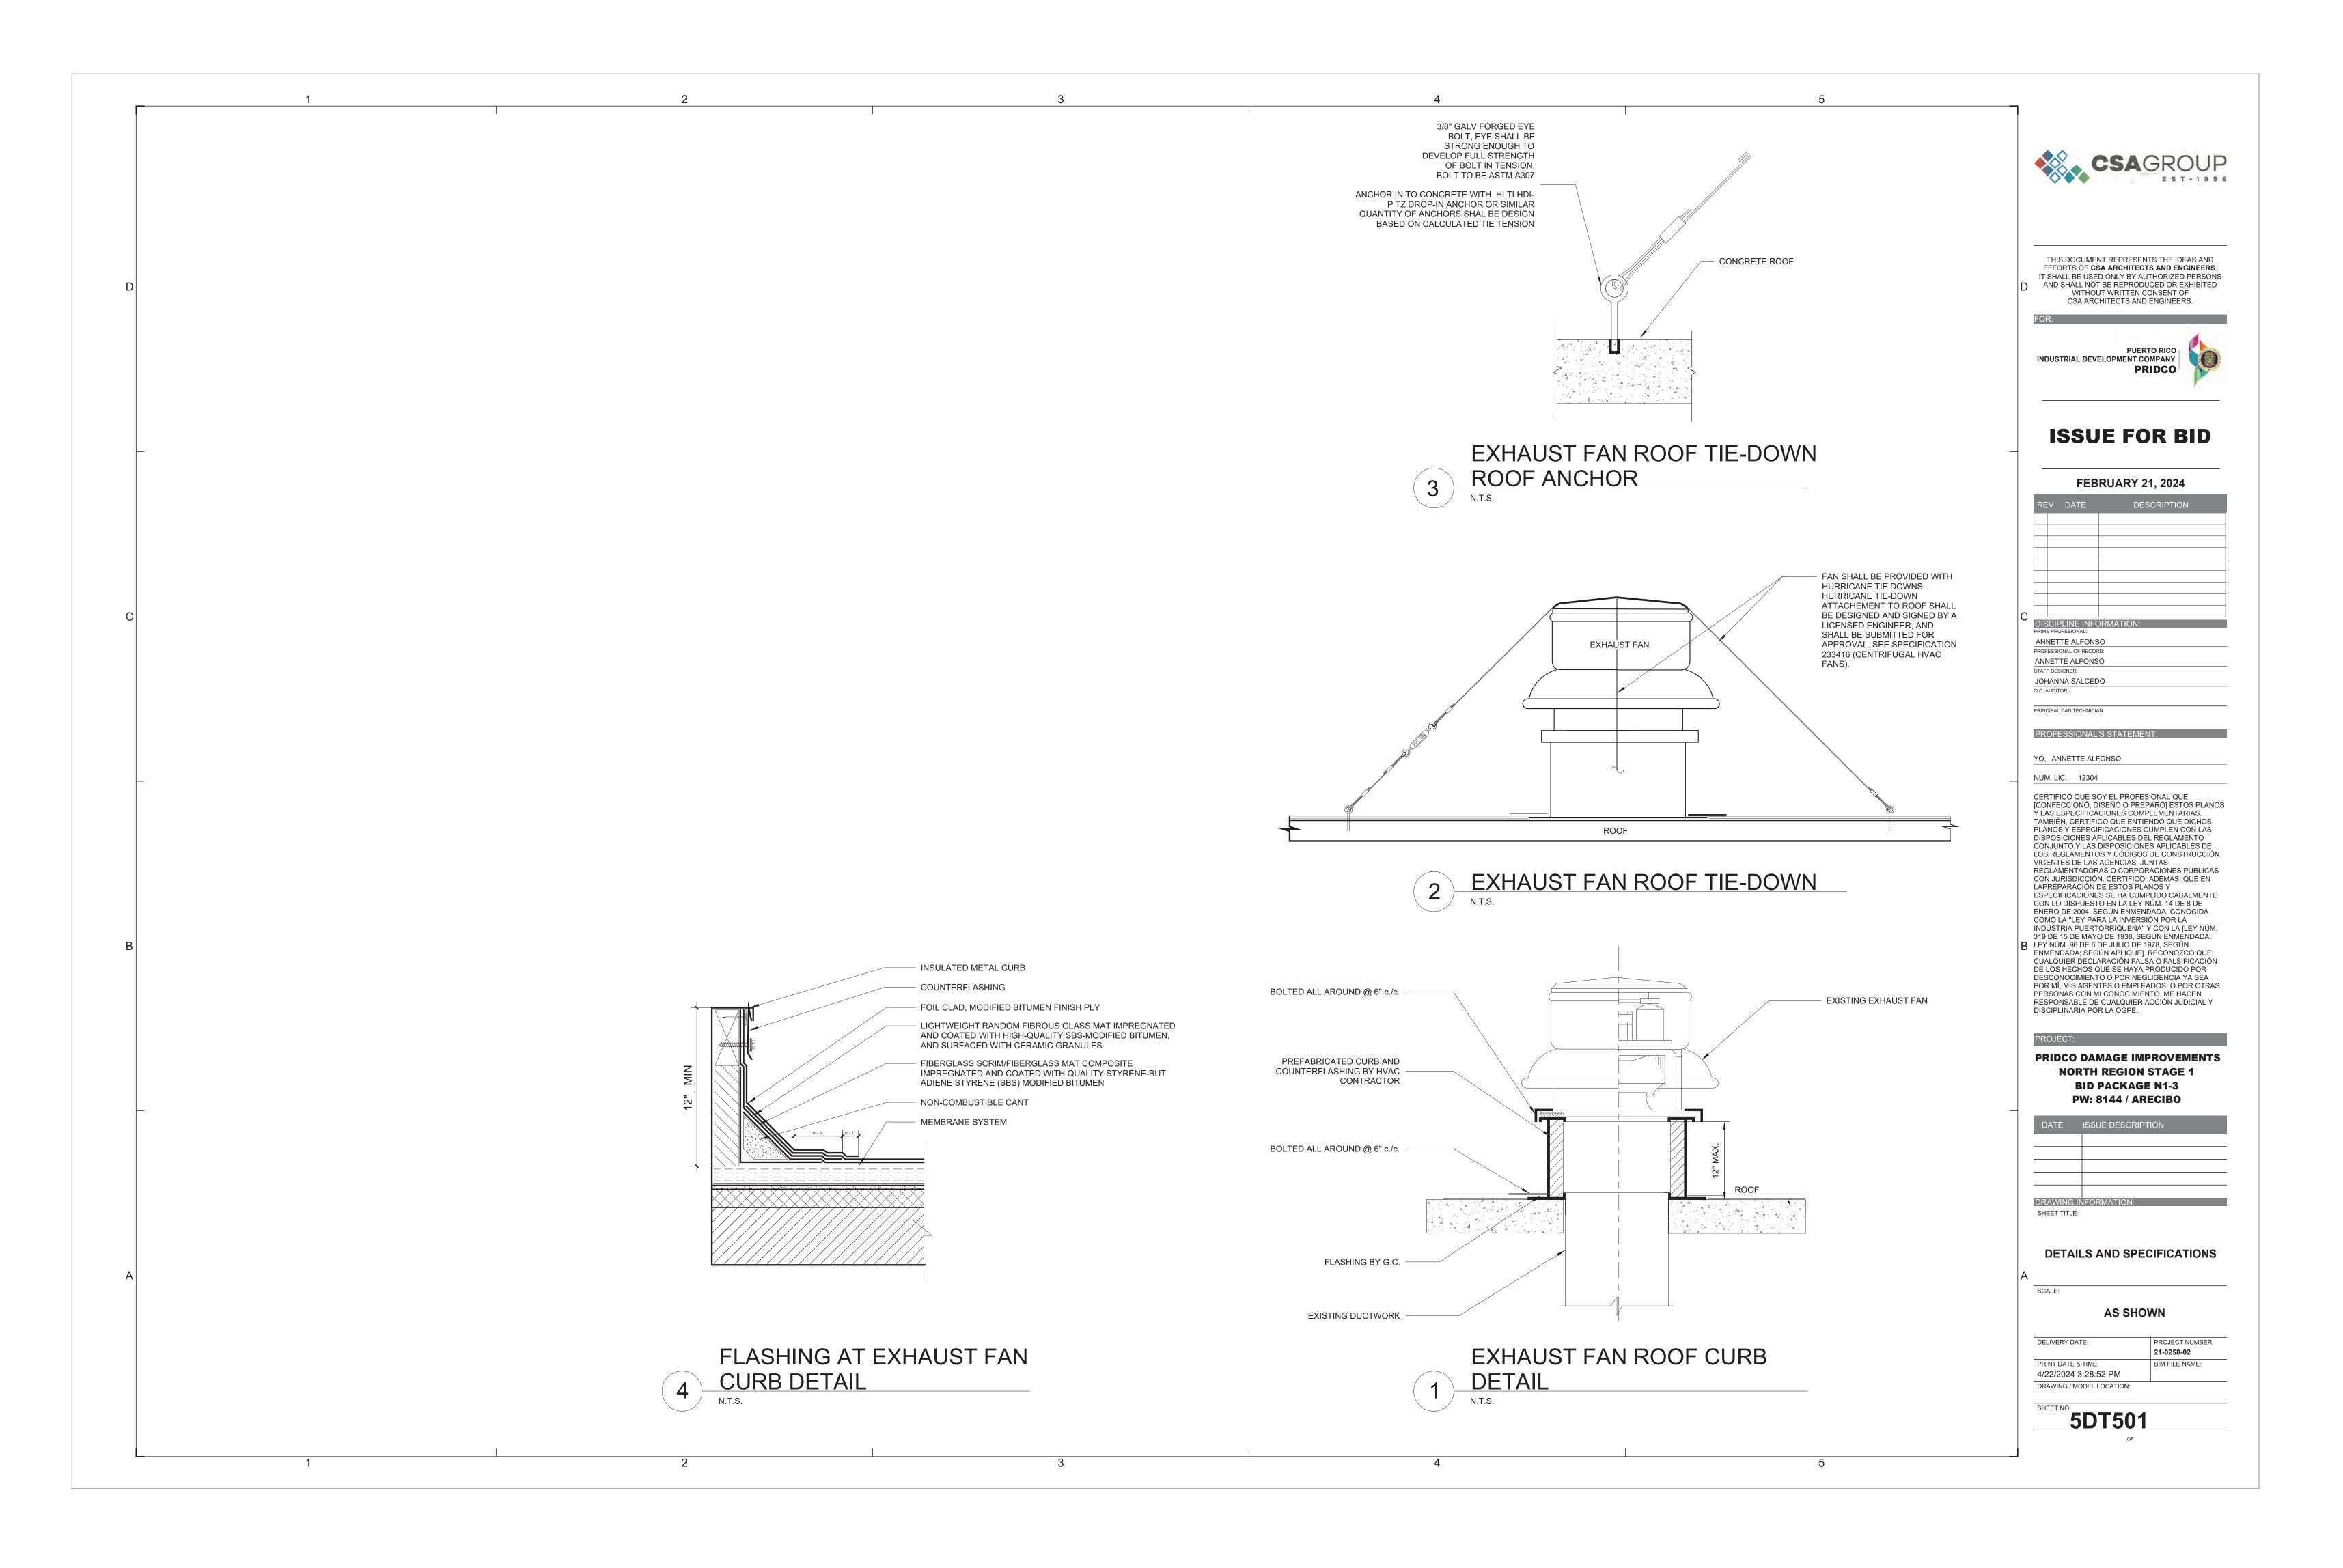


ACORN TOP 0 × × × × × TOP RAIL * * * * * * * * * * ALUM TOP RAIL OR RAIL OR BRACE END BRACE -TENSION BAR BRACE ROD TURNBUCKLE FINISHED GRADE LINE

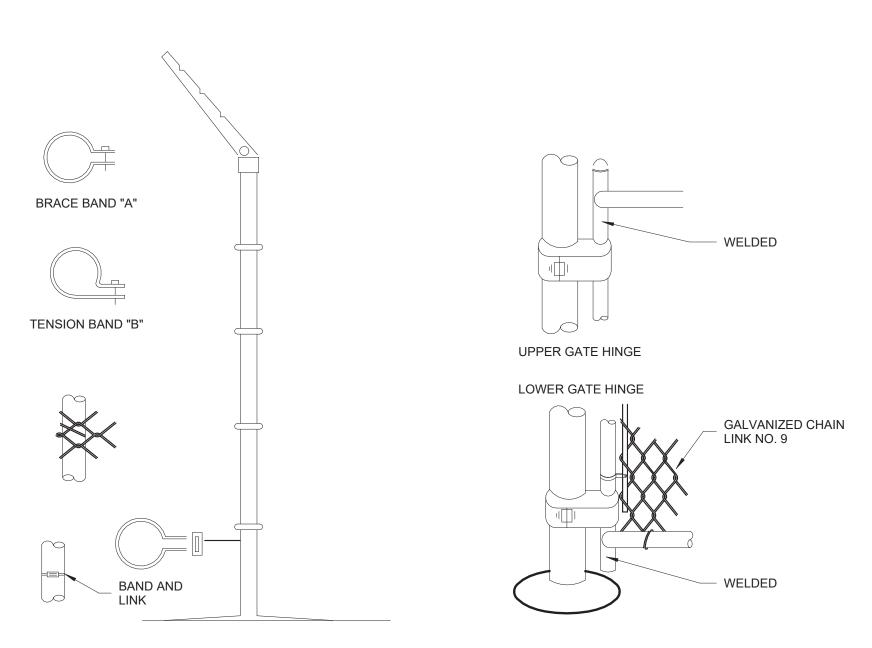

INSTALLATION DETAILS FOR CHAIN LINK FENCE & GATES

NOTES:

- 1. CHAIN LINK FENCE INDUSTRIAL TYPE NO.423
- 2. LINE POSTS 2 1/2" O.D. GALV. STD.WEIGHT PIPE-3.85 LBS. PER LIN. FT.
- 3. TOP RAIL 1 5/8" O.D. GALV. STD.WEIGHT PIPE-2.27 LBS. PER LIN. FT. (GATE FRAME IDEM.)
- 4. CORNER POST 3"∅ O.D. GALV. STD. WEIGHT PIPE 6.79 LBS. PER LIN. FT.
- 5. TENSION WIRE GA. NO.7 GALVANIZED
- 6. GATE POST 4"O.D. GALV. STD. WEIGHT PIPE 9.10 LBS. PER LIN. FT.
- 7. GALVANIZED CHAIN LINK GA. 9-2"X2"-1.2 OUNCES GALVANIZED AFTER WOOVEN.
- 8. STD. WEIGHT PIPE, SCHEDULE 40A. 120
- 9. TUBULAR STEEL PIPE SHALL BE INSTALLED EVERY 50'- 0" PANEL SPAN (SPAN = 10'- 0") TUBULAR STEEL PIPE SHALL BE INSTALLED EVERY DIRECTIONS CHANGE IN THE FENCE TUBULAR STEEL PIPE SHALL BE INSTALLED AT EACH FENCE END PANEL.
- 10. ALL FITTINGS EXTRA HEAVY DUTY
- 11. MILL CERTIFICATE SHALL BE SUBMITTED.

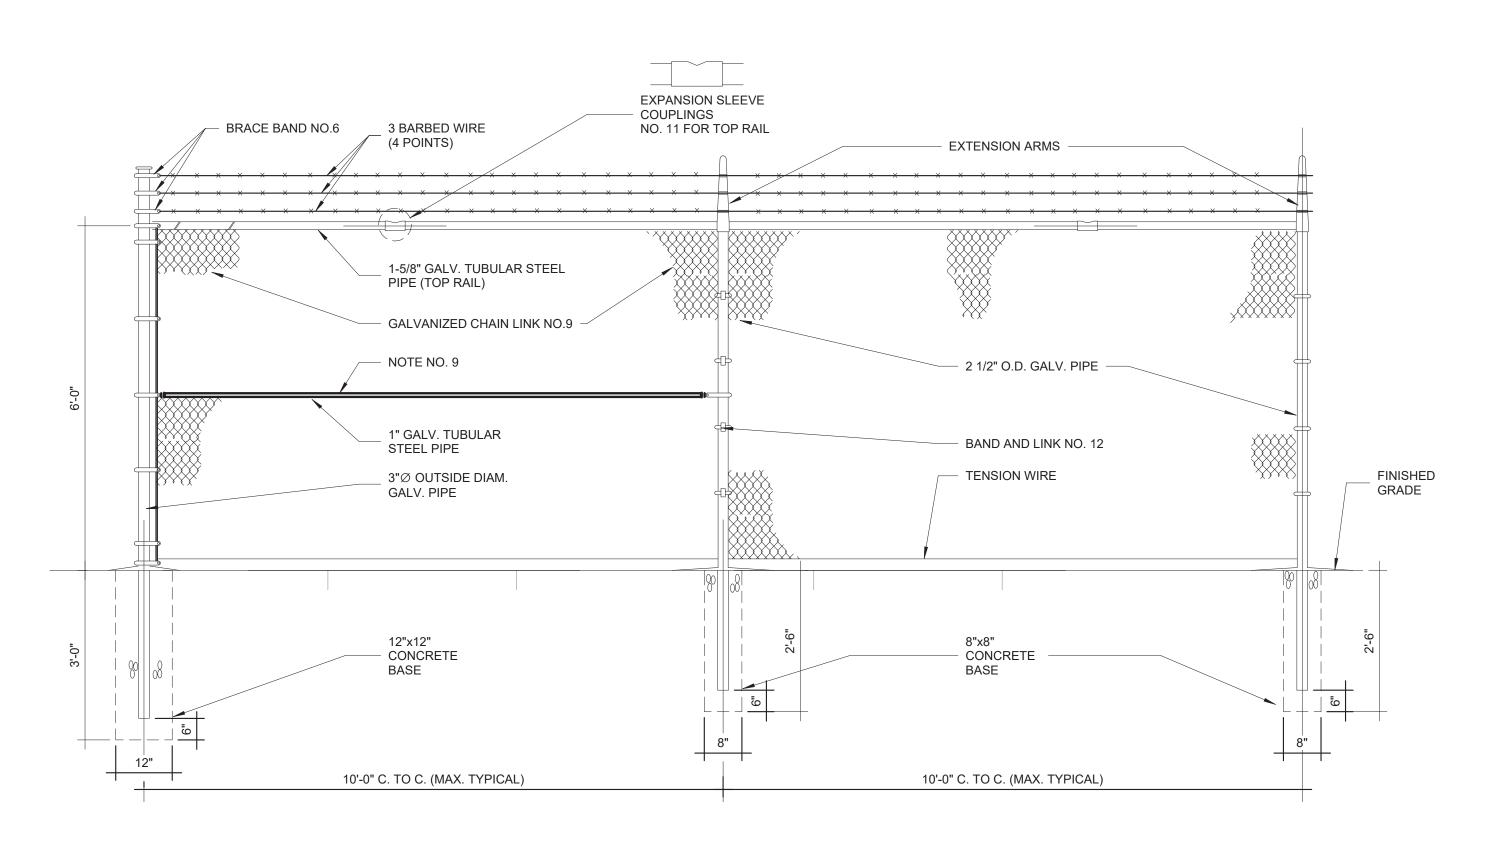

CHAIN LINK FENCE PARTIAL ELEVATION (ALONG PROPERTY LIMITS)





THIS DOCUMENT REPRESENTS THE IDEAS AND EFFORTS OF CSA ARCHITECTS AND ENGINEERS. IT SHALL BE USED ONLY BY AUTHORIZED PERSONS AND SHALL NOT BE REPRODUCED OR EXHIBITED WITHOUT WRITTEN CONSENT OF

CSA ARCHITECTS AND ENGINEERS.

PUERTO RICO INDUSTRIAL DEVELOPMENT COMPANY PRIDCO

ISSUE FOR BID

FEBRUARY 21, 2024

	RE	V	DATE	DESCRIPTION
С	פוח	CIP	I INE INEC	DRMATION:

ANNETTE ALFONSO JOHANNA SALCEDO

PRINCIPAL CAD TECHNICIAN:

PROFESSIONAL'S STATEMENT:

YO, ANNETTE ALFONSO

NUM. LIC. 12304

CERTIFICO QUE SOY EL PROFESIONAL QUE [CONFECCIONÓ, DISEÑÓ O PREPARÓ] ESTOS PLANOS VI AS ESDECIEICACIONES COMDI EMENT TAMBIÉN, CERTIFICO QUE ENTIENDO QUE DICHOS PLANOS Y ESPECIFICACIONES CUMPLEN CON LAS DISPOSICIONES APLICABLES DEL REGLAMENTO CONJUNTO Y LAS DISPOSICIONES APLICABLES DE LOS REGLAMENTOS Y CÓDIGOS DE CONSTRUCCIÓN VIGENTES DE LAS AGENCIAS, JUNTAS REGLAMENTADORAS O CORPORACIONES PÚBLICAS CON JURISDICCIÓN. CERTIFICO, ADEMÁS, QUE EN LAPREPARACIÓN DE ESTOS PLANOS Y ESPECIFICACIONES SE HA CUMPLIDO CABALMENTE CON LO DISPUESTO EN LA LEY NÚM. 14 DE 8 DE ENERO DE 2004, SEGÚN ENMENDADA, CONOCIDA COMO LA "LEY PARA LA INVERSIÓN POR LA INDUSTRIA PUERTORRIQUEÑA" Y CON LA [LEY NÚM. 319 DE 15 DE MAYO DE 1938, SEGÚN ENMENDADA; B LEY NÚM. 96 DE 6 DE JULIO DE 1978, SEGÚN ENMENDADA; SEGÚN APLIQUE]. RECONOZCO QUE CUALQUIER DECLARACIÓN FALSA O FALSIFICACIÓN DE LOS HECHOS QUE SE HAYA PRODUCIDO POR DESCONOCIMIENTO O POR NEGLIGENCIA YA SEA POR MÍ, MIS AGENTES O EMPLEADOS, O POR OTRAS

PRIDCO DAMAGE IMPROVEMENTS NORTH REGION STAGE 1 **BID PACKAGE N1-3**

PW: 8144 / ARECIBO

PERSONAS CON MI CONOCIMIENTO, ME HACEN RESPONSABLE DE CUALQUIER ACCIÓN JUDICIAL Y


DISCIPLINARIA POR LA OGPE.

SHEET TITLE:


DETAILS AND SPECIFICATIONS


AS SHOWN

PROJECT NUMBER: 21-0258-02 PRINT DATE & TIME: BIM FILE NAME: 4/22/2024 3:28:52 PM DRAWING / MODEL LOCATION:

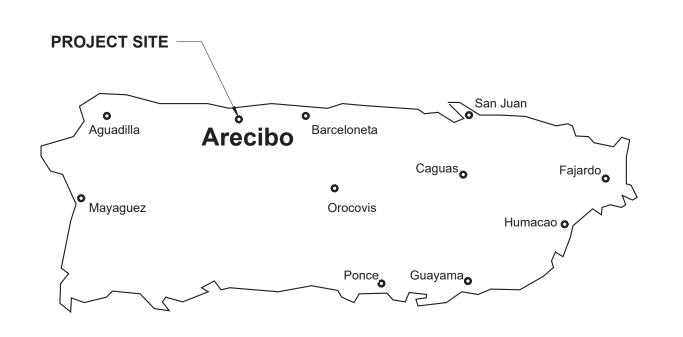



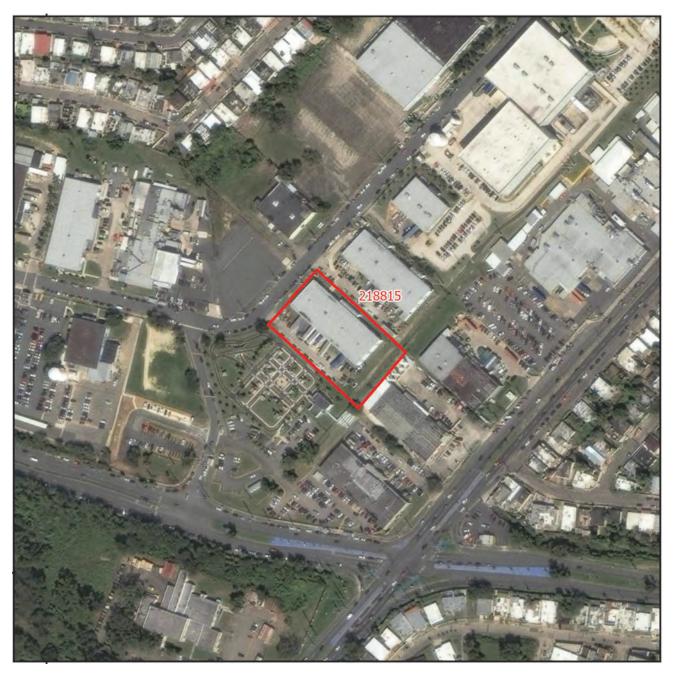

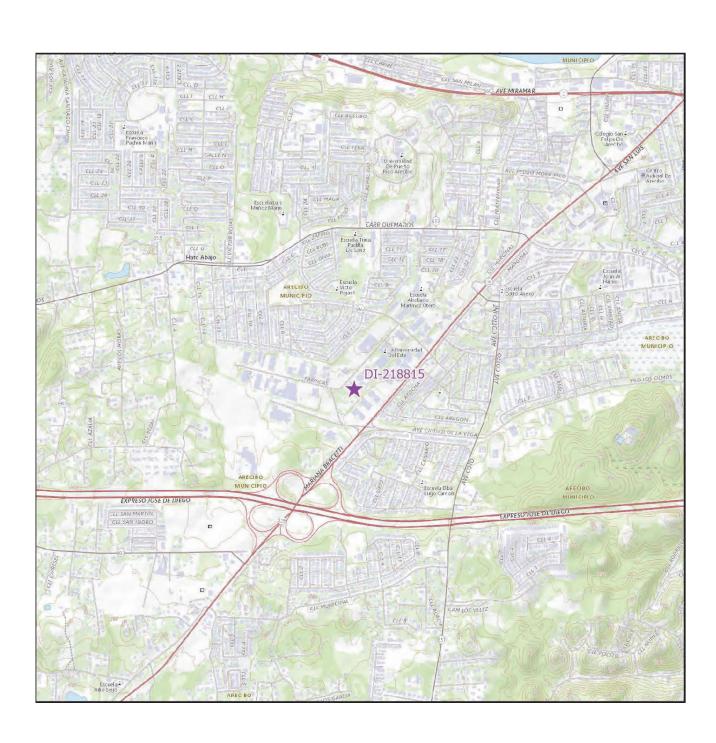

FLOOD MAP


AERIAL PHOTO 18.45833, -66.74346 LOCATION MAP SCALE 1: 20,000

IND	EX OF	DRAW	INGS - PW 8144, DI 218815
	Sheet	Current	
Discipline	Number	Revision	Sheet Name
00-GENERAL	6GI001		COVER SHEET - DI 218815
00-GENERAL	6GI002		GENERAL NOTES, ABBREVIATIONS AND LEGEND
03-ARCHITECTURAL	6AE101		SITE PLAN BUILDING T093606800 DI 218815
05-DETAILS	6DT501		DETAILS AND SPECIFICATIONS
OF DETAIL C	CDTEGG		DETAIL C AND ODECIFICATIONS

PRIDCO-FEMA 4339 DR PROGRAM NORTH REGION STAGE 1 BID PACKAGE N1-3

6. PW: 8144 | DI: 218815 | Bldg: T093606800

Road PR-128, Km. 40.9, Lot #25, Zeno Gandia Industrial Park, Arecibo, Puerto Rico, 00612

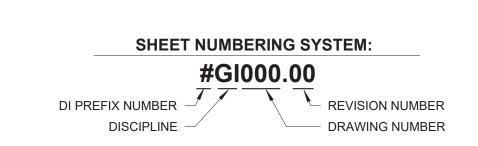





COVER SHEE	T - DI 218815
SCALE:	
AS S	HOWN
DELIVERY DATE:	PROJECT NUMBER 21-0258-02
DELIVERY DATE: PRINT DATE & TIME:	
	21-0258-02

CALLED FOR IN SAID CODES

SUBSTANTIAL COMPLETION.

COMMENCING THE WORK.

ADJACENT FACILITIES

LIMITING COMPETITION.

ARCHITECTURAL NOTES

EXISTING CONDITIONS AND DRAWINGS

BUILDING AND SITE SHALL BE VACANT.

WALLS AND FINISHES IN GENERAL

INSTALLATION OF NEW MEMBRANE

ELECTRICAL GENERAL NOTES

INDICATED

ENVELOPE

SOCKETS

SUBMITTING BIDS

PERFORM WORK IN ACCORDANCE WITH OSHA RULES AND REGULATIONS.

CODES 2018, AND WITH OTHER CODES, STANDARDS, AND REGULATIONS

COMPLY WITH APPLICABLE RULES AND REGULATIONS FOR OBTAINING

NECESSARY AND REQUIRED INSPECTIONS, APPROVALS AND PERMITS

PRACTICES, AS PER MANUFACTURER'S WRITTEN RECOMMENDATIONS,

AND IN A CAREFUL AND ORDERLY MANNER WITH THE LEAST POSSIBLE

IMPLEMENT SAFETY CONTROLS DURING DEMOLITION/CONSTRUCTION

DAILY REMOVE DEBRIS RESULTING FROM DEMOLITION/CONSTRUCTION

REGULATIONS. SITE AND STRUCTURE SHALL BE LEFT BROOM CLEAN FOR

AND TRANSPORT IT OUT OF PROJECT LIMITS. PERFORM DISPOSAL

OPERATION IN ACCORDANCE WITH GOVERNMENT APPROVALS AND

DO NOT SCALE DRAWINGS. VERIFY DIMENSIONS IN THE FIELD BEFORE

PROCEDING WITH ANY PORTION OF THE WORK. ADVISE IN WRITING TO

CONSTRUCTION MANAGER AND ARCHITECT OF DISCREPANCY BETWEEN

REPORT TO CONSTRUCTION MANAGER AND ARCHITECT DISCREPANCIES

IN THE CONTRACT DRAWINGS, SPECIFICATIONS OR DETAILS PRIOR TO

COORDINATE CIVIL. MECHANICAL. ELECTRICAL. ARCHITECTURAL AND

OF SLEEVES, INSERTS, OPENINGS AND ROUGH-IN REQUIRED

INTERFERENCE WITH ROADS, STREETS, SIDEWALKS AND OTHER

THE USE OF A BRAND NAME AND/OR MODEL NUMBER TO DENOTE

UNTIL THE HAZARDOUS MATERIAL ABATEMENT IS DONE AND EPA

STRUCTURES ARE FREE OF HAZARDOUS MATERIALS. PRIOR TO

FOR OBTAINING PERMIT BEFORE PERFORMING THE WORK.

COMMENCEMENT OF THE HAZARDOUS MATERIAL ABATEMENT THE

PRESSURE WASH, MINIMUM 3,000 PSI, EXISTING BUILDING EXTERIOR

REPAIR INTERIOR AND EXTERIOR WALL SURFACES WITH CEMENT

SCREWS FROM WALLS, REPAIR OF MAJOR IMPERFECTIONS ON

FULL TEAR-OFF OF ROOF WATERPROOFING SYSTEM INCLUDING

NO WIRE SHALL BE SMALLER THAN # 12 AWG THHN, 600 VOLTS.

ALL CONDUIT SHALL BE RIGID GALVANIZED EXCEPT OTHERWISE

LEAVE A #12 AWG GALVANIZED FISH WIRE IN ALL EMPTY CONDUITS.

ALL UNDERGROUND CONDUITS SHALL BE PROTECTED WITH 4" CONCRETE

EXPANSION FITTINGS SHALL BE USED FOR EVERY CONDUIT CROSSING

PROVIDE A #12 GREEN THW BONDING JUMPER BETWEEN EACH OUTLET

ALL INSTALLATIONS SHALL BE EXPOSED UNLESS OTHERWISE INDICATED.

ALL NON-GALVANIZED METAL PARTS SHALL BE GIVEN ONE COAT OF RED

ELECTRICAL SYSTEM IN PRESENCE OF THE REPRESENTATIVE FROM THE

ALL LIGHTING CIRCUITS SHALL HAVE ONE (1) PORCELAIN LIGHT SOCKET

WITH A LED TYPE BULB, EQUIVALENT TO 100W INCANDESCENT LUMENS.

THE NEUTRAL WIRES SHALL BE IDENTIFIED THROUGHT THE INSTALLATION

BY THE USE OF WHITE COLOR COVERED LIVE WIRES WITHIN THE SAME

CONTRACTOR SHALL VERIFY LENGTH OF FEEDERS IN THE FIELD BEFORE

ALL SWITCHES AND RECEPTACLES THAT ARE CONCEALED IN WALLS AND

TO THE BEGINNING OF THE WORK AND COORDINATE WITH THEM FOR THE

EXECUTION OF THE WORK CONCERNING THE SERVICE ENTRANCE AND

A CERTIFICATE OF INSPECTION AT THE COMPLETION OF THE WORK AND

ALL INSTALLATIONS SHALL BE IN ACCORDANCE WITH THE LATEST RULES

SPECIFICATIONS AND DRAWINGS FOR APPROVAL OF P.R.I.D.C.O. PRIOR TO

SHALL FORWARD IT TO THE PUERTO RICO INDUSTRIAL DEVELOPMENT

ALL BOXES FOR RECEPTACLES & LIGHTING SWITCHES FOR EXPOSED

CONTRACTOR SHALL SUBMIT A LIST OF MATERIALS AND EQUIPMENT

GIVING MANUFACTURER CATALOG NUMBERS AND COMPLETE

THE PURCHASING OF SAID MATERIALS AND/OR EQUIPMENT.

RECEPTACLES AND LIGHTING CIRCUITS SHALL BE #12 THHN WIRE AND

SHALL BE CONNECTED TO 20 AMP BREAKERS AT THE PANELBOARD.

OVERHANGS SHALL BE PROVIDED WITH STAINLESS STEEL COVERS.

ALL OVERHANGS AND LEAN - TO'S SHALL BE PROVIDED WITH LIGHT

OXIDE AND TWO COATS OF METALLIC GRAY PRIOR TO INSTALLATION.

BOX AND RECEPTACLE GROUNDING TERMINAL, USE 3/8" LONG 10-32

EXPOSED CONDUITS SHALL BE SUPPORTED BY MEANS OF ONE BOLT

AN EXPOSED WORK CONDULET SHALL BE USED FOR ALL 90 BENDS.

ALL GALVANIZED RIGID CONDUITS FOR TOGGLE SWITCHES AND

CONCEALED WITHIN ROOF SLAB, WALLS AND OVERHANGS.

RECEPTACLES LOCATED AT DOORWAYS AND LEAN - TO SHALL BE

CONTRACTOR SHALL PROVIDE ELECTRICAL SERVICE TO TEST ALL

SWITCHES AND RECEPTACLES SHALL BE INSTALLED 4'-0" A.F.F.

OF ROOF MEMBRANE TO VALIDATE THE WARRANTY.

ALL WIRE SHALL BE COPPER, INSULATED AS NOTED.

NO CONDUIT SHALL BE SMALLER THAN 3/4"

CONTRACTOR SHALL BALANCE ALL LOADS

CLAMP SPACED NOT FURTHER THAN 7'-6" APART.

MECHANICAL AND ELECTRICAL DEPARTMENT

CONDUIT SHALL BE COLOR CODED AS PER N.E.C.

AND REGULATIONS OF THE N.E.C. AND LUMA

INSTALLATION SHALL BE "FS" TYPE.

BUILDING EXPANSION JOINTS.

GROUNDING SCREW

WALLS, WINDOWS, AND DOORS BEFORE BEGINNING SPECIFIED WORK.

PLASTER PRIOR TO APPLYING PAINT FINISH. REPAIR WORK INCLUDES,

MEMBRANE, INSULATION AND FLASHINGS WHERE SYSTEM REPLACEMENT

IS SPECIFIED. A ROOF MOISTURE SURVEY MAY BE REQUIRED PRIOR TO

CLEAN, REPAIR AND VERIFY STRUCTURAL INTEGRITY OF ROOF DECK

PRIOR THE INSTALLATION OF THE WATERPROOFING SYSTEM. COMPLY

WITH THE MANUFACTURER RECOMMENDATIONS FOR THE INSTALLATION

BUT IS NOT LIMITED TO CUT AND PATCHING, REMOVAL OF NAILS AND

CERTIFICATION IS OBTAINED, STATING THAT THE SITE ELEMENTS AND

SPECIFIED TREE PRUNING OR CUTTING OR INCIDENTAL TO OTHER REPAIR

WORK MAY REQUIRE A DRNA PERMIT. THE CONTRACTOR IS RESPONSIBLE

STRUCTURAL REQUIREMENTS FOR PROPER LOCATION AND PROVISIONS

CONDUCT DEMOLITION/CONSTRUCTION OPERATION TO INSURE MINIMUM

PRODUCTS, EQUIPMENTS, MATERIALS, OR PROCESS, IS INTENDED TO

ESTABLISH A STANDARD OF QUALITY AND SHALL NOT BE CONSTRUED AS

DO NOT COMMENCE ANY DEMOLITION OF SITE ELEMENTS OR STRUCTURE

NOISE, DUST, OR DISTURBANCE TO OCCUPANTS

NECESSARY TO PERFORM WORK AND SERVICES FOR THE PROJECT. EXECUTE WORK IN ACCORDANCE WITH THE BEST ACCEPTED TRADE

COMPLY WITH THE REQUIREMENTS SET FORTH BY THE PR BUILDING

PLUMBING CODE 2018, PR EXISTING BUILDING CODE 2018, ICC SUITE

CODE 2018, PR FIRE CODE 2018, PR MECHANICAL CODE 2018, PR

GENERAL NOTES

THE PLUMBING DRAWING IS GENERALLY DIAGRAMATTIC AND INDICATIVE OF THE WORK TO BE INSTALLED. RUN ALL PIPING CONCEALED WHEREVER POSSIBLE UNLESS OTHERWISE NOTED.

VENT, HOT, AND COLD WATER LINES, THESE SLEEVES SHALL BE AS SPECIFIED OR REQUIRED BY THE

FURNISH AND SET IN PLACE BEFORE CONCRETE POURING ALL NECESSARY SLEEVES FOR WASTE OR SOIL,

SIZES SHOWN IN FIXTURE SCHEDULE ARE MINIMUM AND SHALL BE INCREASED AS NECESSARY TO COMPLY WITH CODE REQUIREMENTS OR AS SHOWN ON DRAWINGS.

BEFORE CONSTRUCTION VERIFY EXISTING ELEVATIONS AGAINST PROPOSED SLOPES. ANY DISCREPANCIES SHALL BE BROUGHT TO THE ATTENTION OF THE ARCHITECT.

CLEANOUT SHALL BE OF SAME SIZE AS THE PIPES TO WHICH THEY ARE CONNECTED UP TO 4", FOR LARGE PIPES; CLEANOUT SHALL BE 4".

UNLESS OTHERWISE INDICATED, ALL DRAINAGE PIPING 3" AND SMALLER SHALL BE SLOPED 1/4" PER FT., LARGER

CLEANOUT SHALL BE NOT MORE THAN 50 FEET AP-ART IN HORIZONTAL DRAINAGE LINES OF 4" NOMINAL DIAMETER OR LESS AND NOT MORE THAN 100 FEET APART FOR LARGER PIPES.

FOR FIXTURES AND EQUIPMENT NOT LISTED IN SCHEDULE, SEE CONTRACT SPECIFICATIONS.

DETERMINE EXACT LOCATION OF THE PIPING TO AVOID ANY INTERFERENCE WITH PIPING AND/OR EQUIPMENT BEING INSTALLED BY ANOTHER SUB-CONTRACTOR.

SANITARY TEES (SINGLE AND DOUBLE) AND QUARTER BENDS SHALL BE ACCEPTABLE ONLY FOR CHANGES OF DIRECTION FROM HORIZONTAL TO VERTICAL

USE LONG SWEEPING FITTINGS AND/OR LONG SWEEP BENDS AT BASE OF ALL STACKS.

PROVIDE ROUGHING-IN AND INSTALL ALL PLUMBING FIXTURES AND/OR EQUIPMENT WHICH ARE SUPPLIED BY

FOR ALL UNDERGROUND SANITARY AND STORM DRAINAGE USE: PVC POLYVINYL CHLORIDE) SEWER PIPE AND FITTING: ASTM D 3034, SDR-35, FOR SOLVENT CEMENT OR ELASTOMERIC GASKET JOINTS. A. SOLVENT CEMENT: ASTM D 2564 B. GASKETS: ASTM F 477, ELASTOMERIC SEAL

PROVIDE ALL PIPE OPENINGS THROUGH SLABS WITH SLEEVES HAVING AN INTERNAL DIAMETER AT LEAST 1" LARGER THAN THE OUTSIDE DIAMETER OF UN-INSULATED PIPES OR OF THE INSULATION FOR INSULATION SERVICES. FLOOR SLEEVES ARE TO PROJECT 2" ABOVE FINISHED FLOORS.

SLEEVES SHALL BE SCHEDULES 40 GALVANIZED STEEL PIPE.

BOTTOM OF THE WATER SERVICES LINE SHALL BE 12 INCHES ABOVE THE HIGHEST POINT OF THE SEWER LINE WHENEVER THE HORIZONTAL DISTANCE BETWEEN THEM IS LESS THAN 5 FT.

PROVIDE DOWNSPOUT NOZZLES (SIMILAR TO JAY R. SMITH FIG 1770) AT THE OVERFLOW RAIN WATER OUTLETS,

CONTRACTOR SHALL SUPPLY AND INSTALL 1/4 TURN SHUT OFF VALVES AT EVERY PLUMBING FIXTURE.

ALL PLUMBING FIXTURES, COLORS AND FINISHES, SELECTION BY ARCHITECT

HVAC GENERAL NOTES:

SUPPLY AND INSTALL ALL ELECTRICAL CONTROLS, SAFETY SWITCHES AND ACCESSORIES NOT INDICATED IN THE ELECTRICAL DRAWING AND NECESSARY FOR THE PROPER OPERATION OF THE EQUIPMENT IN ACCORDANCE WITH THE MECHANICAL EQUIPMENT RECOMMENDATIONS AND THE NATIONAL ELECTRIC CODE.

PERFORM ALL WIRING AND CONNECTION (POWER AND CONTROL) NOT INDICATED IN THE ELECTRICAL DRAWINGS AND NECESSARY FOR THE PROPER OPERATION OF THE MECHANICAL EQUIPMENT IN STRICT ACCORDANCE WITH THE NATIONAL ELECTRIC CODE

TAKE EVERY PRECAUTION IN ORDER TO MINIMIZE OR ELIMINATE THE TRANSMISSION OF NOISE OR VIBRATION FROM THE EQUIPMENT, PIPING SYSTEM OR DUCT SYSTEM TO THE CONDITIONING SPACE.

EQUIPMENT, MATERIALS AND ACCESSORIES SHALL BE SIMILAR TO THE INDICATED SPECIFICATION AND/OR

MANUFACTURER MODEL OR CATALOG NUMBER.

UNLESS OTHERWISE NOTED IN DRAWINGS AND/OR SPECIFICATIONS ALL EQUIPMENT AND ACCESSORIES SHALL BE FURNISHED AND INSTALLED BY THE CONTRACTOR.

CIVIL SITE GENERAL NOTES

ALL DISTANCES AND ELEVATIONS ARE EXPRESSED IN METERS UNLESS OTHERWISE SPECIFIED.

ELEVATIONS ARE REFERRED TO MEAN SEA LEVEL. COORDINATES ARE BASED ON THE LAMBERT PROJECTION FOR PUERTO RICO AND THE US VIRGIN ISLAND AND REFERENCED TO THE NORTH AMERICAN DATUM OF 1983 (NAD83 NA2011) EPOCH 2010.00 ADJUSTED IN

THE CONTRACTOR SHALL COORDINATE WITH THE CONSTRUCTION MANAGER BEFORE CUTTING OR

TRIMMING EXISTING TREES AFFECTED BY THE CONSTRUCTION. THE CONTRACTOR SHALL PREPARE AND SUBMIT FOR EACH PROJECT AREA, THE CONTROL OF EROSION AND

SEDIMENTATION (CES) PLAN FOR APPROVAL BY THE PERTINENT AGENCY AND THE CONSTRUCTION MANAGER. THE CONTRACTOR SHALL PROVIDE AND MAINTAIN A DEWATERING SYSTEM TO KEEP SUBGRADES DRY AND CONVEY GROUND WATER AWAY FROM EXCAVATIONS. THE DEWATERING PLAN SHALL BE SUBMITTED TO THE

CONSTRUCTION MANAGER FOR APPROVAL AND COORDINATION. DEWATERING PLANS SHALL INCLUDE CONTROL OF EROSION AND SEDIMENTATION FOR EACH PROJECT PHASE AND/OR WORK AREA. THE WATER FROM THE DEWATERING SYSTEM SHALL BE FREE OF SEDIMENT AND/OR DEBRIS BEFORE ANY DISPOSAL.

THE CONTRACTOR SHALL MAINTAIN THE DEWATERING SYSTEM UNTIL DEWATERING IS NO LONGER

ELECTRICAL, COMMUNICATION, SANITARY AND POTABLE WATER SERVICE SHALL NOT BE INTERRUPTED DURING CONSTRUCTION. IF NECESSARY, A PROVISIONAL TEMPORARY SERVICE AND/OR BY-PASS SHALL BE INSTALLED TO MAINTAIN SERVICE. PROVISIONAL TEMPORARY SERVICE AND/OR BY-PASS SHALL BE SUBMITTED TO THE CONSTRUCTION MANAGER FOR APPROVAL AND COORDINATION PRIOR TO CONSTRUCTION.

THE CONTRACTOR SHALL PREPARE AND SUBMIT THE MAINTENANCE OF SERVICE PLAN FOR ELECTRICAL

SANITARY AND POTABLE WATER FOR APPROVAL OF THE CONSTRUCTION MANAGER. THE CONTRACTOR SHALL NOTIFY THE CONSTRUCTION MANAGER IF ANY ELEMENT SUSPECTED OF

CONTAINING HAZARDOUS MATERIAL IS ENCOUNTERED, PRIOR TO ANY RELATED WORK ACTIVITY. CONTRACTOR SHALL CONTACT THE DISTRICT ENGINEER OF LUMA PRIOR | 12. THE CONTRACTOR SHALL VISIT THE PROJECT AREA TO VERIFY THE SPACE LIMITATIONS FOR CONSTRUCTION PROCESS AND EQUIPMENT. THE CONTRACT PRICE SHALL CONSIDER THE REQUIRED CONSTRUCTION PROCESS AND/OR EQUIPMENTS.

SUBSTATION IF REQUIRED. IN ADDITION, THE CONTRACTOR SHALL OBTAIN | 13. PRIOR TO COMMENCEMENT OF THE WORK, CONTRACTOR SHALL VERIFY ALL DIMENSIONS AND EXISTING CONDITIONS AT PROJECT SITE AND SHALL NOTIFY THE CONSTRUCTION MANAGER OF ANY DISCREPANCIES BETWEEN EXISTING CONDITIONS AND CONTRACT DOCUMENTS THAT COULD AFFECT CONSTRUCTION WORK SCHEDULE AND /OR PERFORMANCE

ALL DETAILS, SECTIONS AND NOTES SHOWN ON DRAWINGS ARE INTENDED TO BE TYPICAL AND SHALL APPLY TO SIMILAR SITUATIONS ELSEWHERE UNLESS OTHERWISE NOTED.

THE CONTRACTOR SHALL REPAIR OR REPLACE EXISTING FACILITIES DAMAGED DURING CONSTRUCTION PRIOR TO SUBSTANTIAL COMPLETION

THE CONTRACTOR SHALL MAINTAIN IN OPERATION EXISTING FACILITIES UNTIL NEW FACILITIES ARE IN OPERATION.

GENERAL STRUCTURAL NOTES

STRUCTURAL BUILDING AND DESIGN CODES:

PUERTO RICO BUILDING CODE 2018 AND ITS BINDING REFERENCED STANDARDS, INCLUDING BUT NOT LIMITED TO THE INTERNATIONAL BUILDING CODE 2018

AMERICAN INSTITUTE FOR STEEL CONSTRUCTION (AISC), STEEL CONSTRUCTION MANUAL, 15 [™] EDITION AMERICAN CONCRETE INSTITUTE (ACI), BUILDING CODE REQUIREMENTS FOR STRUCTURAL CONCRETE, ACI 318-14. AMERICAN SOCIETY OF CIVIL ENGINEERS, MINIMUM DESIGN LOADS AND ASSOCIATED CRITERIA FOR BUILDINGS AND OTHER STRUCTURES, ASCE/SEI 7-16

STRUCTURAL NOTES ON CONCRETE REPAIR:

ALL CONCRETE REPAIR WORKS SHALL BE PERFORMED FOLLOWING THE GUIDELINES OF THE INTERNATIONAL CONCRETE REPAIR INSTITUTE (ICRI). HIRING A PROFESSIONAL EXPERIENCED IN THIS TYPE OF REPAIR IS RECOMMENDED TO ENSURE A PROPER

FOR THE REPAIR OF AREAS AFFECTED BY CORROSION, ICRI NO. 03730 GUIDELINE FOR SURFACE PREPARATION FOR THE REPAIR OF DETERIORATED CONCRETE RESULTING FROM REINFORCING STEEL CORROSION SHOULD BE FOLLOWED. BEFORE COMMENCING ANY CONCRETE REPAIR WORK, THE CONTRACTOR SHALL REVIEW THE REPAIR DETAILS PRESENTED IN THE DRAWINGS. IN CASE OF DOUBT WITH THE REPAIR DETAILS PRESENTED, THE CONTRACTOR SHOULD CONTACT THE

ARCHITECT OR ENGINEER OF RECORD TO CLARIFY THEM. IT IS IMPORTANT TO FOLLOW THE MANUFACTURER'S RECOMMENDATIONS FOR EACH PRODUCT UTILIZED FOR THIS JOB, IN ORDER TO GUARANTEE THAT THE REPAIR WORKS ARE CARRIED OUT ADEQUATELY.

<u>STRUCTURAL NOTES ON CAST-IN-PLACE CONCRETE:</u>

PORTLAND CEMENT SHALL BE TYPE II. ALL CONCRETE SHALL BE OF REGULAR WEIGHT (145 POUNDS PER CUBIC FOOT).

THE FOLLOWING CONCRETE MIX PARAMETERS SHALL BE USED UNLESS OTHERWISE NOTED:

CONCRETE STRENGTH AT 28 DAYS – 3,000 PSI MAX. WATER/CEMENT RATIO – 0.65 RECOMMENDED SLUMP – 3 INCHES MAX. AGGREGATE SIZE (ASTM C33) – 1 INCH

PROVIDE CONCRETE MIXES DESIGNED BY A QUALIFIED TESTING LABORATORY FOR REVIEW AND APPROVAL BY THE STRUCTURAL ENGINEER. CONCRETE MIX DESING SHALL BE SIGNED AND SEALED BY A PROFESSIONAL ENGINEER AUTHORIZED TO EXERCISE THE PROFESSION IN THE COMMOM WEALTH OF PUERTO RICO.

NOTE ON REINFORCING STEEL BARS:

ALL REINFORCING STEEL SHALL BE NEW STOCK DEFORMED BARS CONFORMING TO ASTM A615, GRADE 60 (FY = 60 KSI). MAINTAIN THE FOLLOWING CONCRETE COVERAGE FOR REINFORCING STEEL UNLESS NOTED OTHERWISE:

CONCRETE CAST AGAINST EARTH: 3 INCHES CONCRETE IN CONTACT WITH THE GROUND: 2 INCHES

CONCRETE SLAB AND WALLS WITHOUT CONTACT WITH GROUND: 1 INCHES

CONCRETE BEAMS AND COLUMNS: 1 1/2 INCHES

STRUCTURAL STEEL

DESIGN, DETAIL AND ERECT STRUCTURAL STEEL ELEMENTS IN ACCORDANCE WITH THE FOLLOWING:

AISC SPECIFICATION FOR THE DESIGN, FABRICATION, AND ERECTION OF STRUCTURAL STEEL FOR BUILDINGS AISC MANUAL OF STEEL CONSTRUCTION, ALLOWABLE STRESS DESIGN.

AISC CODE OF STANDARD PRACTICE FOR STEEL BUILDINGS AND BRIDGES. AWS STRUCTURAL WELDING CODE, D1.1.

STRUCTURAL STEEL SHALL CONFORM TO THE FOLLOWING GRADES:

W SHAPES: ASTM A992 (FY = 50 KSI, FU = 65 KSI) STEEL ANGLE, CHANNELS, PLATES: ASTM A36

BOLTS, NUTS AND WASHERS: HIGH-STRENGTH BOLTS, INCLUDING NUTS AND WASHERS: ASTM A325

STEEL PLATES FOR LANDINGS AND THREADS: 1/4" ANTI-SLIP DIAMOND TYPE STEEL PLATE A36

WELDING ELECTRODE FOR STEEL SHALL BE E70XX.

PROVIDE DESIGN, FABRICATION, AND ERECTION OF METAL DECK CONFORMING TO THE STEEL DECK INSTITUTE'S "CODE OF FORM ROOF DECK FROM STEEL SHEETS CONFORMING TO ASTM A 611 GRADE C AND D OR A 653 OR HIGHER SPECIFICATIONS

WITH A MINIMUM YIELD STRENGTH OF 33 KSI. ATTACH SHEETS TO STEEL SUPPORT MEMBERS AS INDICATED AND IN ACCORDANCE WITH THE MANUFACTURER'S INSTRUCTIONS FOR INSTALLATION. WHEN DECK IS SCHEDULED TO BEEXPOSED, DE-SLAG, CLEAN AND TOUCH UP WELDS WITH A ZINC-RICH

LAP ROOF AND FLOOR DECK ENDS MINIMUM OF 2 INCHES. WHEN FASTENING DECK TO SUPPORT MEMBERS PROVIDE WELDING MATERIALS INSTALLATION PROCEDURES TO PREVENT BURNING OF HOLES IN DECK.

AT ENDS OF DECKS OR WHERE CHANGES OF DECK DIRECTION OCCUR, FASTEN TO SUPPORTS AT EACH FLUTE. PROVIDE ADEQUATE CLOSURES AND FASTENERS TO SIDES AT EIGHTEEN INCHES ON CENTER. WHERE PARTIAL PANELS MAY BE REQUIRED TO COMPLETE DECK INSTALLATION AT PERIMETER OF STRUCTURE, PROVIDE WELDS

IN EACH FLUTE TO STRUCTURAL MEMBERS. INSTALL DECK IN THREE CONTINUOUS SPAN LENGTHS. AT PERIMETER OF DECK, SECURE DECK TO STRUCTURAL MEMBERS WITH SAME ATTACHMENTAND SPACING SUPPORT ATTACHMENT AS INDICATED ON PLANS.

HOT DIP GALVANIZE (G90) AFTER FABRICATION ALL METAL DECK AND TOUCH UP CONNECTIONS WITH A ZINC-RICH PRIMER.

NOTES (IF APPLICABLE):

TREE REMOVAL:

REMOVE ALL TREES INDICATED BY THE DRAWINGS AND SPECIFICATIONS, AS REQUIRING REMOVAL, IN A MANNER THAT WILL NOT DAMAGE ADJACENT TREES OR STRUCTURES OR COMPACTS THE SOIL. REMOVE TREES THAT ARE ADJACENT TO TREES OR STRUCTURES TO REMAIN, IN SECTIONS, TO LIMIT THE OPPORTUNITY OF

DAMAGE TO ADJACENT CROWNS, TRUNKS, GROUND PLANE ELEMENTS AND STRUCTURES. DO NOT DROP TREES WITH A SINGLE CUT UNLESS THE TREE WILL FALL IN AN AREA NOT INCLUDED IN THE TREE AND PLANT PROTECTION AREA. NO TREE TO BE REMOVED WITHIN 50 FEET OF THE TREE AND PLANT PROTECTION AREA SHALL BE PUSHED

OVER OR UP-ROOTED USING A PIECE OF GRADING EQUIPMENT. PROTECT ADJACENT PAVING, SOIL, TREES, SHRUBS, GROUND COVER PLANTINGS AND UNDERSTORY PLANTS TO REMAIN FROM DAMAGE DURING ALL TREE REMOVAL OPERATIONS, AND FROM CONSTRUCTION OPERATIONS. PROTECTION SHALL INCLUDE THE ROOT SYSTEM, TRUNK, LIMBS, AND CROWN FROM BREAKAGE OR SCARRING, AND THE SOIL FROM COMPACTION.

REMOVE STUMPS AND IMMEDIATE ROOT PLATE FROM EXISTING TREES TO BE REMOVED. GRIND TRUNK BASES AND LARGE BUTTRESS ROOTS TO A DEPTH OF THE LARGEST BUTTRESS ROOT OR AT LEAST 18 INCHES BELOW THE TOP MOST ROOTS WHICH EVER IS LESS AND OVER THE AREA OF THREE TIMES THE DIAMETER OF THE TRUNK (DBH). FOR TREES WHERE THE STUMP WILL FALL UNDER NEW PAVED AREAS, GRIND ROOTS TO A TOTAL DEPTH OF 18 INCHES BELOW THE EXISTING GRADE. IF THE SIDES OF THE STUMP HOLE STILL HAVE GREATER THAN APPROXIMATELY 20% WOOD VISIBLE, CONTINUE GRINDING OPERATION DEEPER AND OR WIDER UNTIL THE RESULTING HOLE HAS LESS THAN 20% WOOD. REMOVE ALL

WOOD CHIPS PRODUCED BY THE GRINDING OPERATION AND BACK FILL IN 8 INCH LAYERS WITH CONTROLLED FILL OF A QUALITY ACCEPTABLE TO THE SITE ENGINEER FOR FILL MATERIAL UNDER STRUCTURES, COMPACTED TO 95% OF THE MAXIMUM DRY DENSITY STANDARD PROCTOR. THE OWNER'S REPRESENTATIVE SHALL APPROVE EACH HOLE AT THE END OF THE GRINDING IN AREAS WHERE THE TREE LOCATION IS TO BE A PLANTING BED OR LAWN, REMOVE ALL WOODCHIPS AND BACKFILL STUMP

HOLES WITH PLANTING SOIL AS DEFINED IN SPECIFICATION SECTION PLANTING SOIL, IN MAXIMUM OF 12 INCH LAYERS AND COMPACT TO 80 - 85% OF THE MAXIMUM DRY DENSITY STANDARD PROCTOR.

WITHIN SIX MONTHS OF THE ESTIMATED DATE OF SUBSTANTIAL COMPLETION, PRUNE ALL DEAD OR HAZARDOUS BRANCHES LARGER THAN 2 INCH IN DIAMETER FROM ALL TREES TO REMAIN.

IMPLEMENT ALL PRUNING RECOMMENDATIONS FOUND IN THE ARBORIST REPORT PRUNE ANY LOW, HANGING BRANCHES AND VINES FROM EXISTING TREES AND SHRUBS THAT OVERHANG WALKS, STREETS AND

DRIVES, OR PARKING AREAS AS FOLLOWS:

1. WALKS - WITHIN 8 FEET VERTICALLY OF THE PROPOSED WALK ELEVATION.

2. PARKING AREAS - WITHIN 12 FEET VERTICALLY OF THE PROPOSED PARKING SURFACE ELEVATION.

3. STREETS AND DRIVES - WITHIN 14 FEET VERTICALLY OF THE PROPOSED DRIVING SURFACE ELEVATION.

ALL PRUNING SHALL BE DONE IN ACCORDANCE WITH ANSI A300 (PART 1), ISA BMP TREE PRUNING (LATEST EDITION, AND THE "STRUCTURAL PRUNING: A GUIDE FOR THE GREEN INDUSTRY", EDWARD GILMAN, BRIAN KEMPF, NELDA MATHENY AND JIM CLARK, 2013 URBAN TREE FOUNDATION, VISALIA CA.

PERFORM OTHER PRUNING TASK AS INDICATED ON THE DRAWINGS OR REQUESTED BY THE OWNER'S REPRESENTATIVE. WHERE TREE SPECIFIC DISEASE VECTORS REQUIRE, STERILIZE ALL PRUNING TOOLS BETWEEN THE WORK IN INDIVIDUAL TREES.

GENERAL DRAWING SYMBOLS: ABBREVIATIONS:

F.F.L.

T.O.S.

ALUMINUM

CORRIDOR

CORROSION

ELEVATION

FLOOR DRAIN

HARDWARE

JANITOR CLOSE

NOT IN CONTRA

ROOF DRAIN

REQUIRED

SMOOTH CEMENT PLASTE

UNLESS OTHERWISE NOTE

STAINLESS STEEL

TOP OF MASONRY

TOP OF STEEL

DROP MANHOLE

VERIFY IN FIELD

TELEPHONE

STORM SEWER

STRUCTURAL

MECHANICAL

MINIMUM

MOUNTED

CENTER TO CENTER

CONCRETE MASONRY UNIT

FINISH FLOOR ELEVATIONS

FINISH FLOOR LEVEL

EXISTING WALL NEW CONCRETE BLOCK WALL 6" OR 8" NEW PLYCEM BOARD WALL

BEHIND AS INDICATED.

- DETAIL REFERENCE NUMBER DETAIL REFERENCE SYMBOL - SHEET WHERE DETAIL IS DRAWN

SHEET WHERE ELEVATION IS DRAWN - SECTION REFERENCE NUMBER GENERAL BUILDING SECTION

- SHEET WHERE SECTION IS DRAWN

- WALL SECTION REFERENCE NUMBER

- ELEVATION REFERENCE NUMBER

ELEVATION REFERENCE NUMBER



NORTH ARROW

WINDOW SYMBO

KEY NOTE

EQUIPMENT SYMBO LEVEL SYMBOL



HANDICAPPED SYMBOL



AIR CONDITIONING

THIS DOCUMENT REPRESENTS THE IDEAS AND EFFORTS OF CSA ARCHITECTS AND ENGINEERS. IT SHALL BE USED ONLY BY AUTHORIZED PERSONS AND SHALL NOT BE REPRODUCED OR EXHIBITED WITHOUT WRITTEN CONSENT OF

CSA ARCHITECTS AND ENGINEERS.

PUERTO RICO INDUSTRIAL DEVELOPMENT COMPANY PRIDCO

ISSUE FOR BID

FEBRUARY 21, 2024

	REV	DATE	DESCRIPTION
_			
С	DISCIE	DI INIE INIEC	DRMATION:
	PRIME PRO		DRIVIATION.
	ANNET	TE ALFONS	0
	PROFESSIO	ONAL OF RECOR	D:
	ANNET	TE ALFONS	0
	STAFF DES	IGNER:	
	JOHANI	NA SALCED	0
	Q.C. AUDIT	OR:	

PROFESSIONAL'S STATEMENT: YO, ANNETTE ALFONSO

CERTIFICO QUE SOY EL PROFESIONAL QUE [CONFECCIONÓ, DISEÑÓ O PREPARÓ] ESTOS PLANOS TAMBIÉN, CERTIFICO QUE ENTIENDO QUE DICHOS PLANOS Y ESPECIFICACIONES CUMPLEN CON LAS DISPOSICIONES APLICABLES DEL REGLAMENTO CONJUNTO Y LAS DISPOSICIONES APLICABLES DE LOS REGLAMENTOS Y CÓDIGOS DE CONSTRUCCIÓN VIGENTES DE LAS AGENCIAS. JUNTAS REGLAMENTADORAS O CORPORACIONES PÚBLICAS CON JURISDICCIÓN. CERTIFICO, ADEMÁS, QUE EN LAPREPARACIÓN DE ESTOS PLANOS Y ESPECIFICACIONES SE HA CUMPLIDO CABALMENTE CON LO DISPUESTO EN LA LEY NÚM. 14 DE 8 DE ENERO DE 2004, SEGÚN ENMENDADA, CONOCIDA COMO LA "LEY PARA LA INVERSIÓN POR LA INDUSTRIA PUERTORRIQUEÑA" Y CON LA [LEY NÚM. 319 DE 15 DE MAYO DE 1938, SEGÚN ENMENDADA; LEY NÚM. 96 DE 6 DE JULIO DE 1978, SEGÚN ENMENDADA: SEGÚN APLIQUEI, RECONOZCO QUE CUALQUIER DECLARACIÓN FALSA O FALSIFICACIÓN DE LOS HECHOS QUE SE HAYA PRODUCIDO POR DESCONOCIMIENTO O POR NEGLIGENCIA YA SEA POR MÍ, MIS AGENTES O EMPLEADOS, O POR OTRAS PERSONAS CON MI CONOCIMIENTO. ME HACEN

PRIDCO DAMAGE IMPROVEMENTS **NORTH REGION STAGE 1 BID PACKAGE N1-3** PW: 8144 / ARECIBO

RESPONSABLE DE CUALQUIER ACCIÓN JUDICIAL Y

DISCIPLINARIA POR LA OGPE.

SHEET TITLE:

GENERAL NOTES, ABBREVIATIONS AND LEGEND

AS SHOWN

DELIVERY DATE PROJECT NUMBER: 21-0258-02 PRINT DATE & TIME: BIM FILE NAME: 4/22/2024 3:28:54 PM DRAWING / MODEL LOCATION:





3/8" GALV FORGED EYE BOLT, EYE SHALL BE STRONG ENOUGH TO DEVELOP FULL STRENGTH OF BOLT IN TENSION, BOLT TO BE ASTM A307 ANCHOR IN TO CONCRETE WITH HLTI HDI-P TZ DROP-IN ANCHOR OR SIMILAR QUANTITY OF ANCHORS SHAL BE DESIGN BASED ON CALCULATED TIE TENSION THIS DOCUMENT REPRESENTS THE IDEAS AND EFFORTS OF CSA ARCHITECTS AND ENGINEERS. IT SHALL BE USED ONLY BY AUTHORIZED PERSONS AND SHALL NOT BE REPRODUCED OR EXHIBITED — CONCRETE ROOF WITHOUT WRITTEN CONSENT OF CSA ARCHITECTS AND ENGINEERS. PUERTO RICO INDUSTRIAL DEVELOPMENT COMPANY PRIDCO **ISSUE FOR BID** EXHAUST FAN ROOF TIE-DOWN FEBRUARY 21, 2024 ROOF ANCHOR

N.T.S. EV DATE DESCRIPTION FAN SHALL BE PROVIDED WITH HURRICANE TIE DOWNS. HURRICANE TIE-DOWN ATTACHEMENT TO ROOF SHALL BE DESIGNED AND SIGNED BY A LICENSED ENGINEER, AND SHALL BE SUBMITTED FOR DISCIPLINE INFORMATION: PRIME PROFESIONAL: APPROVAL. SEE SPECIFICATION EXHAUST FAN 233416 (CENTRIFUGAL HVAC ANNETTE ALFONSO
STAFF DESIGNER: JOHANNA SALCEDO PRINCIPAL CAD TECHNICIAN: PROFESSIONAL'S STATEMENT: YO, ANNETTE ALFONSO NUM. LIC. 12304 CERTIFICO QUE SOY EL PROFESIONAL QUE [CONFECCIONÓ, DISEÑÓ O PREPARÓ] ESTOS PLANOS TAMBIÉN, CERTIFICO QUE ENTIENDO QUE DICHOS PLANOS Y ESPECIFICACIONES CUMPLEN CON LAS DISPOSICIONES APLICABLES DEL REGLAMENTO CONJUNTO Y LAS DISPOSICIONES APLICABLES DE LOS REGLAMENTOS Y CÓDIGOS DE CONSTRUCCIÓN VIGENTES DE LAS AGENCIAS, JUNTAS REGLAMENTADORAS O CORPORACIONES PÚBLICAS 2 EXHAUST FAN ROOF TIE-DOWN
N.T.S. CON JURISDICCIÓN. CERTIFICO, ADEMÁS, QUE EN LAPREPARACIÓN DE ESTOS PLANOS Y ESPECIFICACIONES SE HA CUMPLIDO CABALMENTE CON LO DISPUESTO EN LA LEY NÚM. 14 DE 8 DE ENERO DE 2004, SEGÚN ENMENDADA, CONOCIDA COMO LA "LEY PARA LA INVERSIÓN POR LA INDUSTRIA PUERTORRIQUEÑA" Y CON LA [LEY NÚM. 319 DE 15 DE MAYO DE 1938, SEGÚN ENMENDADA; B LEY NÚM. 96 DE 6 DE JULIO DE 1978, SEGÚN ENMENDADA; SEGÚN APLIQUE]. RECONOZCO QUE CUALQUIER DECLARACIÓN FALSA O FALSIFICACIÓN DE LOS HECHOS QUE SE HAYA PRODUCIDO POR DESCONOCIMIENTO O POR NEGLIGENCIA YA SEA POR MÍ, MIS AGENTES O EMPLEADOS, O POR OTRAS BOLTED ALL AROUND @ 6" c./c. PERSONAS CON MI CONOCIMIENTO, ME HACEN RESPONSABLE DE CUALQUIER ACCIÓN JUDICIAL Y - EXISTING EXHAUST FAN DISCIPLINARIA POR LA OGPE. INSULATED METAL CURB COUNTERFLASHING **PRIDCO DAMAGE IMPROVEMENTS** - FOIL CLAD, MODIFIED BITUMEN FINISH PLY PREFABRICATED CURB AND **NORTH REGION STAGE 1** COUNTERFLASHING BY HVAC LIGHTWEIGHT RANDOM FIBROUS GLASS MAT IMPREGNATED CONTRACTOR **BID PACKAGE N1-3** AND COATED WITH HIGH-QUALITY SBS-MODIFIED BITUMEN, AND SURFACED WITH CERAMIC GRANULES PW: 8144 / ARECIBO FIBERGLASS SCRIM/FIBERGLASS MAT COMPOSITE IMPREGNATED AND COATED WITH QUALITY STYRENE-BUT ADIENE STYRENE (SBS) MODIFIED BITUMEN BOLTED ALL AROUND @ 6" c./c. NON-COMBUSTIBLE CANT MEMBRANE SYSTEM SHEET TITLE: **DETAILS AND SPECIFICATIONS** FLASHING BY G.C. **AS SHOWN** EXISTING DUCTWORK DELIVERY DATE: PROJECT NUMBER: 21-0258-02 FLASHING AT EXHAUST FAN EXHAUST FAN ROOF CURB PRINT DATE & TIME: BIM FILE NAME: 4/22/2024 3:28:56 PM DRAWING / MODEL LOCATION: 6DT501

ACORN TOP

TOP RAIL

ALUM TOP
RAIL OR BRACE END


TA'

BRACE FINISHED GRADE LINE

ACORN TOP


TOP RAIL

BRACE ROD
AND
TURNBUCKLE

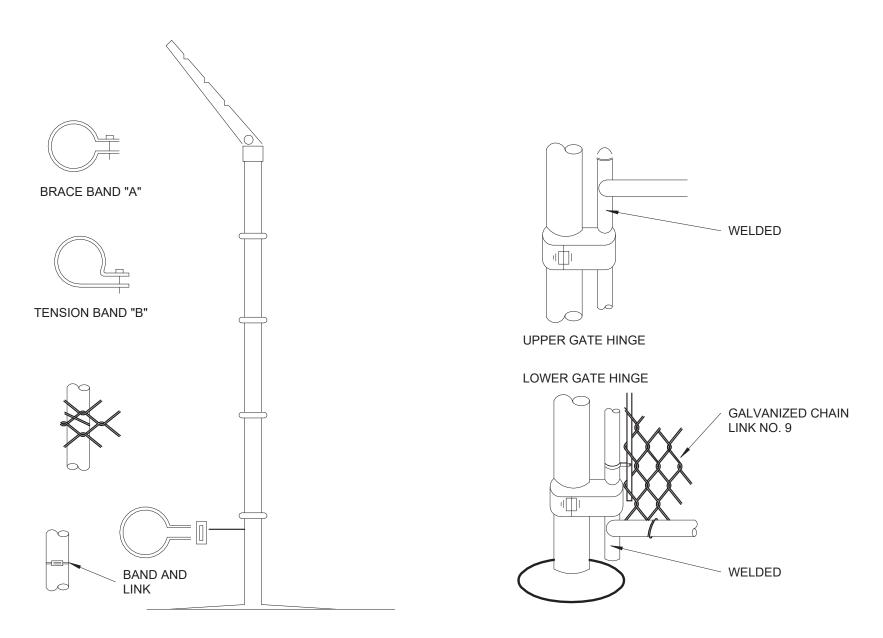

NOTES:

- 1. CHAIN LINK FENCE INDUSTRIAL TYPE NO.423
- 2. LINE POSTS 2 1/2" O.D. GALV. STD.WEIGHT PIPE-3.85 LBS. PER LIN. FT.
- 3. TOP RAIL 1 5/8" O.D. GALV. STD.WEIGHT PIPE-2.27 LBS. PER LIN. FT. (GATE FRAME IDEM.)
- 4. CORNER POST 3"∅ O.D. GALV. STD. WEIGHT PIPE 6.79 LBS. PER LIN. FT.
- 5. TENSION WIRE GA. NO.7 GALVANIZED
- 6. GATE POST 4"O.D. GALV. STD. WEIGHT PIPE 9.10 LBS. PER LIN. FT.
- 7. GALVANIZED CHAIN LINK GA. 9-2"X2"-1.2 OUNCES GALVANIZED AFTER WOOVEN.
- 8. STD. WEIGHT PIPE, SCHEDULE 40A. 120
- TUBULAR STEEL PIPE SHALL BE INSTALL EVERY 50'-0" PANEL SPAN (SPAN=10'-0')
 TUBULAR STEEL PIPE SHALL BE INSTAL EVERY DIRECTIONS CHANGE IN THE FENCE.
 TUBULAR STEEL PIPE SHALL BE INSTALL AT EACH FENCE END PANEL.
- 10. ALL FITTINGS EXTRA HEAVY DUTY.
- 11. MILL CERTIFICATE SHALL BE SUBMITTED.

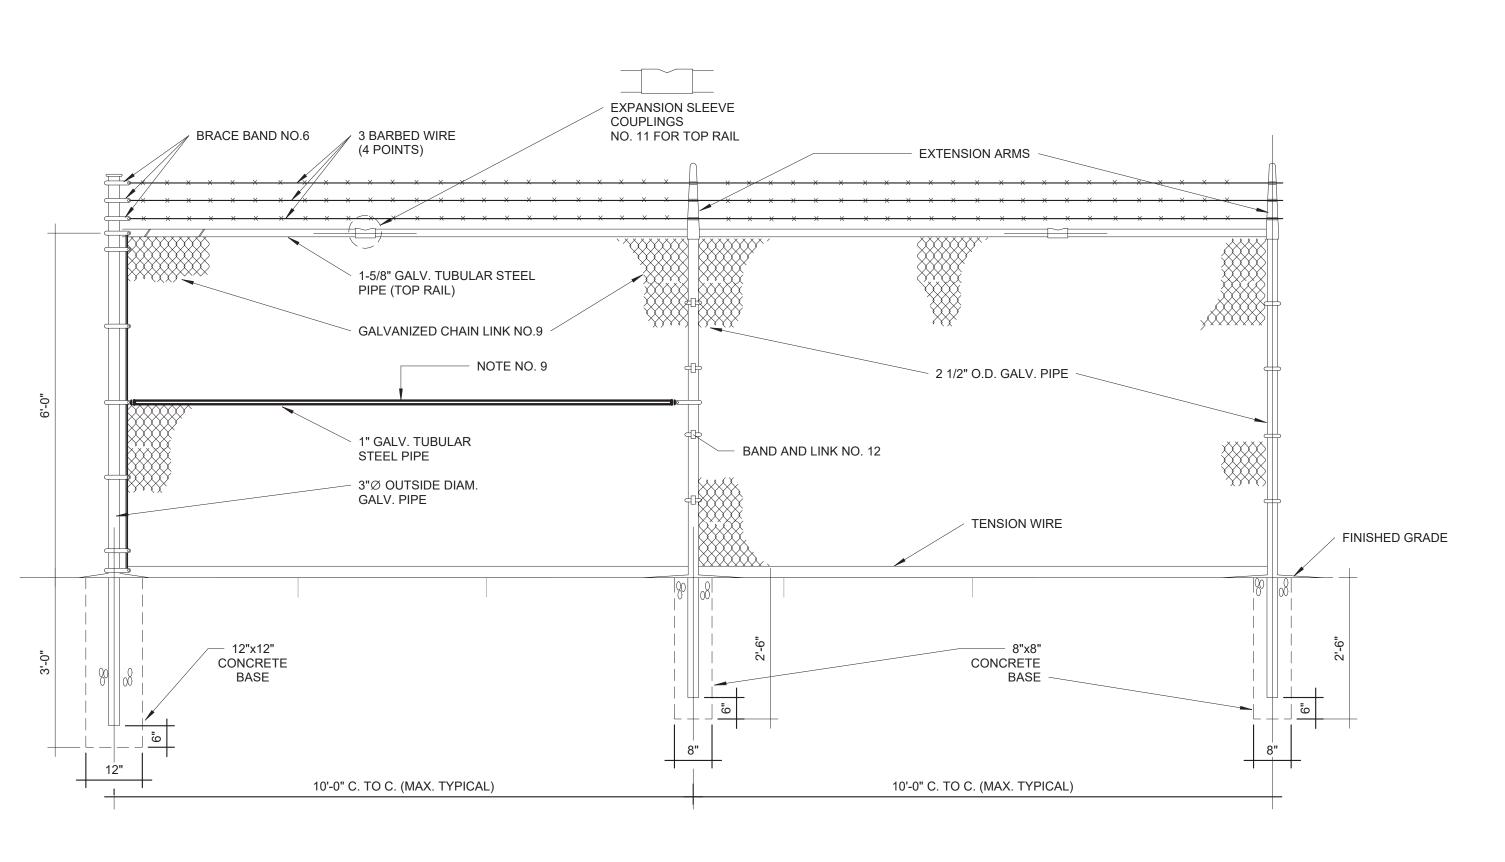

INSTALLATION DETAILS FOR
CHAIN LINK FENCE & GATES

N.T.S.

CHAIN LINK FENCE WITH BARBED WIRE PARTIAL ELEVATION

(ALONG PROPERTY LIMITS)

N.T.S.



THIS DOCUMENT REPRESENTS THE IDEAS AND EFFORTS OF **CSA ARCHITECTS AND ENGINEERS**. IT SHALL BE USED ONLY BY AUTHORIZED PERSONS AND SHALL NOT BE REPRODUCED OR EXHIBITED WITHOUT WRITTEN CONSENT OF CSA ARCHITECTS AND ENGINEERS.

PUERTO RICO
INDUSTRIAL DEVELOPMENT COMPANY
PRIDCO

ISSUE FOR BID

FEBRUARY 21, 2024

	REV	DATE	DESCRIPTION
С			
-		PLINE INFO	RMATION:

PROFESSIONAL OF RECORDS

PROFESSIONAL OF RECORD:
ANNETTE ALFONSO
STAFF DESIGNER:
JOHANNA SALCEDO

PRINCIPAL CAD TECHNICIAN:


PROFESSIONAL'S STATEMENT:

YO, ANNETTE ALFONSO

_____NUM. LIC. 12304

CERTIFICO QUE SOY EL PROFESIONAL QUE [CONFECCIONÓ, DISEÑÓ O PREPARÓ] ESTOS PLANOS TAMBIÉN, CERTIFICO QUE ENTIENDO QUE DICHOS PLANOS Y ESPECIFICACIONES CUMPLEN CON LAS DISPOSICIONES APLICABLES DEL REGLAMENTO CONJUNTO Y LAS DISPOSICIONES APLICABLES DE LOS REGLAMENTOS Y CÓDIGOS DE CONSTRUCCIÓN VIGENTES DE LAS AGENCIAS, JUNTAS REGLAMENTADORAS O CORPORACIONES PÚBLICAS CON JURISDICCIÓN. CERTIFICO, ADEMÁS, QUE EN LAPREPARACIÓN DE ESTOS PLANOS Y ESPECIFICACIONES SE HA CUMPLIDO CABALMENTE CON LO DISPUESTO EN LA LEY NÚM. 14 DE 8 DE ENERO DE 2004, SEGÚN ENMENDADA, CONOCIDA COMO LA "LEY PARA LA INVERSIÓN POR LA INDUSTRIA PUERTORRIQUEÑA" Y CON LA [LEY NÚM. 319 DE 15 DE MAYO DE 1938, SEGÚN ENMENDADA; LEY NÚM. 96 DE 6 DE JULIO DE 1978, SEGÚN ENMENDADA; SEGÚN APLIQUE]. RECONOZCO QUE CUALQUIER DECLARACIÓN FALSA O FALSIFICACIÓN DE LOS HECHOS QUE SE HAYA PRODUCIDO POR DESCONOCIMIENTO O POR NEGLIGENCIA YA SEA POR MÍ, MIS AGENTES O EMPLEADOS, O POR OTRAS PERSONAS CON MI CONOCIMIENTO, ME HACEN RESPONSABLE DE CUALQUIER ACCIÓN JUDICIAL Y DISCIPLINARIA POR LA OGPE.

PRIDCO DAMAGE IMPROVEMENTS NORTH REGION STAGE 1 BID PACKAGE N1-3 PW: 8144 / ARECIBO

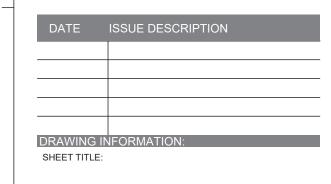

DETAILS AND SPECIFICATIONS

AC CHC


AS SHOWN

DELIVERY DATE: PROJECT NUMBER:

21-0258-02


PRINT DATE & TIME:
4/22/2024 3:28:56 PM

DRAWING / MODEL LOCATION:

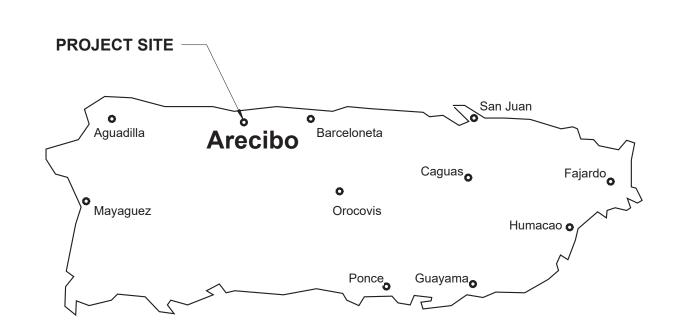





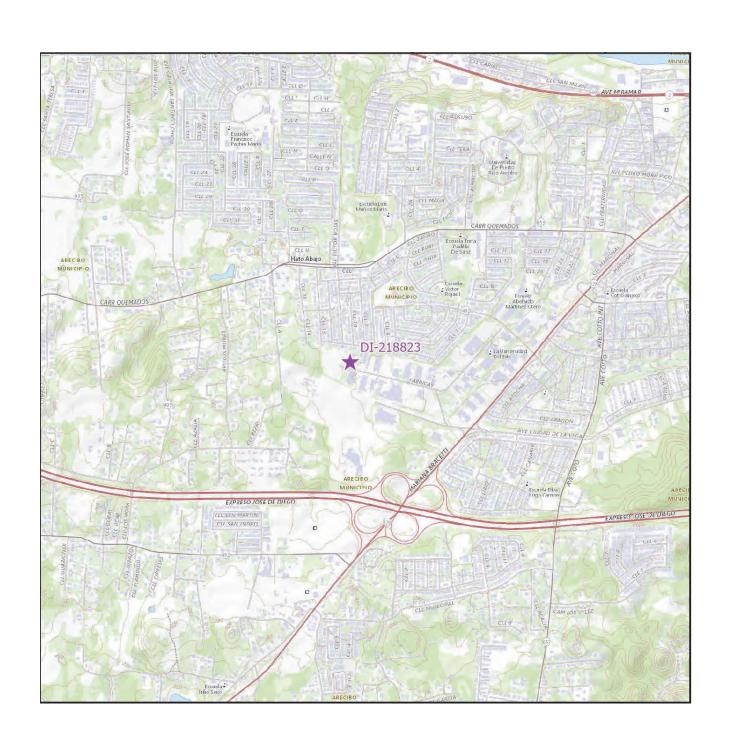

FLOOD MAP

AERIAL PHOTO 18.45965, -66.74882

LOCATION MAP SCALE 1: 20,000

IND	INDEX OF DRAWINGS - PW 8144, DI 218823						
	Sheet	Current					
Discipline	Number	Revision	Sheet Name				
00-GENERAL	7GI001		COVER SHEET - DI 218823				
00-GENERAL	7GI002		GENERAL NOTES, ABBREVIATIONS AND LEGEND				
03-ARCHITECTURAL	7AE101		SITE PLAN BUILDING T125507900 DI 218823				
05-DETAILS	7DT501		DETAILS AND SPECIFICATIONS				
05-DETAILS	7DT502		DETAILS AND SPECIFICATIONS				

DETAILS AND SPECIFICATIONS

05-DETAILS

7DT503

PRIDCO-FEMA 4339 DR PROGRAM NORTH REGION STAGE 1 BID PACKAGE N1-3

7. PW: 8144 | DI: 218823 | Bldg: T125507900

Road PR-128, Km. 40.9, Lot #44, Zeno Gandia Industrial Park, Arecibo, PR, 00612

FEBRUARY 21, 2024

#GI000.00

DI PREFIX NUMBER

DISCIPLINE

SHEET NUMBERING SYSTEM:

REVISION NUMBER

DRAWING NUMBER







GENERAL NOTES

- PERFORM WORK IN ACCORDANCE WITH OSHA RULES AND REGULATIONS. COMPLY WITH THE REQUIREMENTS SET FORTH BY THE PR BUILDING CODE 2018, PR FIRE CODE 2018, PR MECHANICAL CODE 2018, PR PLUMBING CODE 2018, PR EXISTING BUILDING CODE 2018, ICC SUITE CODES 2018, AND WITH OTHER CODES, STANDARDS, AND REGULATIONS CALLED FOR IN SAID CODES
- COMPLY WITH APPLICABLE RULES AND REGULATIONS FOR OBTAINING NECESSARY AND REQUIRED INSPECTIONS, APPROVALS AND PERMITS NECESSARY TO PERFORM WORK AND SERVICES FOR THE PROJECT.
- EXECUTE WORK IN ACCORDANCE WITH THE BEST ACCEPTED TRADE PRACTICES, AS PER MANUFACTURER'S WRITTEN RECOMMENDATIONS, AND IN A CAREFUL AND ORDERLY MANNER WITH THE LEAST POSSIBLE
- NOISE, DUST, OR DISTURBANCE TO OCCUPANTS. IMPLEMENT SAFETY CONTROLS DURING DEMOLITION/CONSTRUCTION
- DAILY REMOVE DEBRIS RESULTING FROM DEMOLITION/CONSTRUCTION AND TRANSPORT IT OUT OF PROJECT LIMITS. PERFORM DISPOSAL OPERATION IN ACCORDANCE WITH GOVERNMENT APPROVALS AND REGULATIONS. SITE AND STRUCTURE SHALL BE LEFT BROOM CLEAN FOR
- SUBSTANTIAL COMPLETION. DO NOT SCALE DRAWINGS. VERIFY DIMENSIONS IN THE FIELD BEFORE PROCEDING WITH ANY PORTION OF THE WORK. ADVISE IN WRITING TO CONSTRUCTION MANAGER AND ARCHITECT OF DISCREPANCY BETWEEN EXISTING CONDITIONS AND DRAWINGS.
- REPORT TO CONSTRUCTION MANAGER AND ARCHITECT DISCREPANCIES IN THE CONTRACT DRAWINGS, SPECIFICATIONS OR DETAILS PRIOR TO COMMENCING THE WORK.
- STRUCTURAL REQUIREMENTS FOR PROPER LOCATION AND PROVISIONS OF SLEEVES, INSERTS, OPENINGS AND ROUGH-IN REQUIRED CONDUCT DEMOLITION/CONSTRUCTION OPERATION TO INSURE MINIMUM INTERFERENCE WITH ROADS, STREETS, SIDEWALKS AND OTHER

COORDINATE CIVIL, MECHANICAL, ELECTRICAL, ARCHITECTURAL AND

- ADJACENT FACILITIES THE USE OF A BRAND NAME AND/OR MODEL NUMBER TO DENOTE PRODUCTS, EQUIPMENTS, MATERIALS, OR PROCESS, IS INTENDED TO ESTABLISH A STANDARD OF QUALITY AND SHALL NOT BE CONSTRUED AS
- LIMITING COMPETITION. DO NOT COMMENCE ANY DEMOLITION OF SITE ELEMENTS OR STRUCTURE UNTIL THE HAZARDOUS MATERIAL ABATEMENT IS DONE AND EPA CERTIFICATION IS OBTAINED, STATING THAT THE SITE ELEMENTS AND STRUCTURES ARE FREE OF HAZARDOUS MATERIALS. PRIOR TO COMMENCEMENT OF THE HAZARDOUS MATERIAL ABATEMENT THE
- BUILDING AND SITE SHALL BE VACANT. SPECIFIED TREE PRUNING OR CUTTING OR INCIDENTAL TO OTHER REPAIR WORK MAY REQUIRE A DRNA PERMIT. THE CONTRACTOR IS RESPONSIBLE FOR OBTAINING PERMIT BEFORE PERFORMING THE WORK.

ARCHITECTURAL NOTES

- PRESSURE WASH, MINIMUM 3,000 PSI, EXISTING BUILDING EXTERIOR WALLS, WINDOWS, AND DOORS BEFORE BEGINNING SPECIFIED WORK. REPAIR INTERIOR AND EXTERIOR WALL SURFACES WITH CEMENT PLASTER PRIOR TO APPLYING PAINT FINISH. REPAIR WORK INCLUDES, BUT IS NOT LIMITED TO CUT AND PATCHING, REMOVAL OF NAILS AND SCREWS FROM WALLS, REPAIR OF MAJOR IMPERFECTIONS ON WALLS AND FINISHES IN GENERAL
- FULL TEAR-OFF OF ROOF WATERPROOFING SYSTEM INCLUDING MEMBRANE, INSULATION AND FLASHINGS WHERE SYSTEM REPLACEMENT IS SPECIFIED. A ROOF MOISTURE SURVEY MAY BE REQUIRED PRIOR TO INSTALLATION OF NEW MEMBRANE
- CLEAN, REPAIR AND VERIFY STRUCTURAL INTEGRITY OF ROOF DECK PRIOR THE INSTALLATION OF THE WATERPROOFING SYSTEM. COMPLY WITH THE MANUFACTURER RECOMMENDATIONS FOR THE INSTALLATION OF ROOF MEMBRANE TO VALIDATE THE WARRANTY.

ELECTRICAL GENERAL NOTES

- NO WIRE SHALL BE SMALLER THAN # 12 AWG THHN, 600 VOLTS NO CONDUIT SHALL BE SMALLER THAN 3/4".
- ALL CONDUIT SHALL BE RIGID GALVANIZED EXCEPT OTHERWISE
- ALL WIRE SHALL BE COPPER, INSULATED AS NOTED. LEAVE A #12 AWG GALVANIZED FISH WIRE IN ALL EMPTY CONDUITS.
- ALL UNDERGROUND CONDUITS SHALL BE PROTECTED WITH 4" CONCRETE ENVELOPE.
- EXPANSION FITTINGS SHALL BE USED FOR EVERY CONDUIT CROSSING BUILDING EXPANSION JOINTS.
- CONTRACTOR SHALL BALANCE ALL LOADS PROVIDE A #12 GREEN THW BONDING JUMPER BETWEEN EACH OUTLET BOX AND RECEPTACLE GROUNDING TERMINAL, USE 3/8" LONG 10-32
- GROUNDING SCREW. ALL INSTALLATIONS SHALL BE EXPOSED UNLESS OTHERWISE INDICATED. EXPOSED CONDUITS SHALL BE SUPPORTED BY MEANS OF ONE BOLT CLAMP SPACED NOT FURTHER THAN 7'-6" APART.
- AN EXPOSED WORK CONDULET SHALL BE USED FOR ALL 90 BENDS. ALL NON-GALVANIZED METAL PARTS SHALL BE GIVEN ONE COAT OF RED OXIDE AND TWO COATS OF METALLIC GRAY PRIOR TO INSTALLATION.
- ALL GALVANIZED RIGID CONDUITS FOR TOGGLE SWITCHES AND RECEPTACLES LOCATED AT DOORWAYS AND LEAN - TO SHALL BE CONCEALED WITHIN ROOF SLAB, WALLS AND OVERHANGS. CONTRACTOR SHALL PROVIDE ELECTRICAL SERVICE TO TEST ALL
- ELECTRICAL SYSTEM IN PRESENCE OF THE REPRESENTATIVE FROM THE MECHANICAL AND ELECTRICAL DEPARTMENT
- ALL LIGHTING CIRCUITS SHALL HAVE ONE (1) PORCELAIN LIGHT SOCKET WITH A LED TYPE BULB, EQUIVALENT TO 100W INCANDESCENT LUMENS.
- SWITCHES AND RECEPTACLES SHALL BE INSTALLED 4'-0" A.F.F. THE NEUTRAL WIRES SHALL BE IDENTIFIED THROUGHT THE INSTALLATION
- BY THE USE OF WHITE COLOR COVERED LIVE WIRES WITHIN THE SAME CONDUIT SHALL BE COLOR CODED AS PER N.E.C. RECEPTACLES AND LIGHTING CIRCUITS SHALL BE #12 THHN WIRE AND SHALL BE CONNECTED TO 20 AMP BREAKERS AT THE PANELBOARD.
- SOCKETS.
- CONTRACTOR SHALL VERIFY LENGTH OF FEEDERS IN THE FIELD BEFORE SUBMITTING BIDS ALL SWITCHES AND RECEPTACLES THAT ARE CONCEALED IN WALLS AND

ALL OVERHANGS AND LEAN - TO'S SHALL BE PROVIDED WITH LIGHT

- OVERHANGS SHALL BE PROVIDED WITH STAINLESS STEEL COVERS. CONTRACTOR SHALL CONTACT THE DISTRICT ENGINEER OF LUMA PRIOR TO THE BEGINNING OF THE WORK AND COORDINATE WITH THEM FOR THE EXECUTION OF THE WORK CONCERNING THE SERVICE ENTRANCE AND SUBSTATION IF REQUIRED. IN ADDITION, THE CONTRACTOR SHALL OBTAIN A CERTIFICATE OF INSPECTION AT THE COMPLETION OF THE WORK AND SHALL FORWARD IT TO THE PUERTO RICO INDUSTRIAL DEVELOPMENT
- COMPANY ALL INSTALLATIONS SHALL BE IN ACCORDANCE WITH THE LATEST RULES AND REGULATIONS OF THE N.E.C. AND LUMA.
- ALL BOXES FOR RECEPTACLES & LIGHTING SWITCHES FOR EXPOSED INSTALLATION SHALL BE "FS" TYPE.
- CONTRACTOR SHALL SUBMIT A LIST OF MATERIALS AND EQUIPMENT GIVING MANUFACTURER CATALOG NUMBERS AND COMPLETE SPECIFICATIONS AND DRAWINGS FOR APPROVAL OF P.R.I.D.C.O. PRIOR TO THE PURCHASING OF SAID MATERIALS AND/OR EQUIPMENT.

- PLUMBING SHALL BE IN STRICT ACCORDANCE WITH THE 2018 PUERTO RICO BUILDING CODE.
- FURNISH AND SET IN PLACE BEFORE CONCRETE POURING ALL NECESSARY SLEEVES FOR WASTE OR SOIL, VENT, HOT, AND COLD WATER LINES, THESE SLEEVES SHALL BE AS SPECIFIED OR REQUIRED BY THE
- THE PLUMBING DRAWING IS GENERALLY DIAGRAMATTIC AND INDICATIVE OF THE WORK TO BE INSTALLED. RUN ALL PIPING CONCEALED WHEREVER POSSIBLE UNLESS OTHERWISE NOTED.
- SIZES SHOWN IN FIXTURE SCHEDULE ARE MINIMUM AND SHALL BE INCREASED AS NECESSARY TO COMPLY WITH CODE REQUIREMENTS OR AS SHOWN ON DRAWINGS.
- BEFORE CONSTRUCTION VERIFY EXISTING ELEVATIONS AGAINST PROPOSED SLOPES. ANY DISCREPANCIES SHALL BE BROUGHT TO THE ATTENTION OF THE ARCHITECT.
- CLEANOUT SHALL BE OF SAME SIZE AS THE PIPES TO WHICH THEY ARE CONNECTED UP TO 4", FOR LARGE
- UNLESS OTHERWISE INDICATED, ALL DRAINAGE PIPING 3" AND SMALLER SHALL BE SLOPED 1/4" PER FT., LARGER
- CLEANOUT SHALL BE NOT MORE THAN 50 FEET AP-ART IN HORIZONTAL DRAINAGE LINES OF 4" NOMINAL DIAMETER OR LESS AND NOT MORE THAN 100 FEET APART FOR LARGER PIPES.
- FOR FIXTURES AND EQUIPMENT NOT LISTED IN SCHEDULE, SEE CONTRACT SPECIFICATIONS.
- DETERMINE EXACT LOCATION OF THE PIPING TO AVOID ANY INTERFERENCE WITH PIPING AND/OR EQUIPMENT BEING INSTALLED BY ANOTHER SUB-CONTRACTOR.
- SANITARY TEES (SINGLE AND DOUBLE) AND QUARTER BENDS SHALL BE ACCEPTABLE ONLY FOR CHANGES OF DIRECTION FROM HORIZONTAL TO VERTICAL
- USE LONG SWEEPING FITTINGS AND/OR LONG SWEEP BENDS AT BASE OF ALL STACKS.

SERVICES. FLOOR SLEEVES ARE TO PROJECT 2" ABOVE FINISHED FLOORS.

- PROVIDE ROUGHING-IN AND INSTALL ALL PLUMBING FIXTURES AND/OR EQUIPMENT WHICH ARE SUPPLIED BY
- FOR ALL UNDERGROUND SANITARY AND STORM DRAINAGE USE: PVC POLYVINYL CHLORIDE) SEWER PIPE AND FITTING: ASTM D 3034, SDR-35, FOR SOLVENT CEMENT OR ELASTOMERIC GASKET JOINTS. A. SOLVENT CEMENT: ASTM D 2564 B. GASKETS: ASTM F 477, ELASTOMERIC SEAL.
- PROVIDE ALL PIPE OPENINGS THROUGH SLABS WITH SLEEVES HAVING AN INTERNAL DIAMETER AT LEAST 1" LARGER THAN THE OUTSIDE DIAMETER OF UN-INSULATED PIPES OR OF THE INSULATION FOR INSULATION
- SLEEVES SHALL BE SCHEDULES 40 GALVANIZED STEEL PIPE.
- BOTTOM OF THE WATER SERVICES LINE SHALL BE 12 INCHES ABOVE THE HIGHEST POINT OF THE SEWER LINE WHENEVER THE HORIZONTAL DISTANCE BETWEEN THEM IS LESS THAN 5 FT.
- PROVIDE DOWNSPOUT NOZZLES (SIMILAR TO JAY R. SMITH FIG 1770) AT THE OVERFLOW RAIN WATER OUTLETS,
- CONTRACTOR SHALL SUPPLY AND INSTALL 1/4 TURN SHUT OFF VALVES AT EVERY PLUMBING FIXTURE.
- ALL PLUMBING FIXTURES, COLORS AND FINISHES, SELECTION BY ARCHITECT.

HVAC GENERAL NOTES:

- SUPPLY AND INSTALL ALL ELECTRICAL CONTROLS, SAFETY SWITCHES AND ACCESSORIES NOT INDICATED IN THE ELECTRICAL DRAWING AND NECESSARY FOR THE PROPER OPERATION OF THE EQUIPMENT IN ACCORDANCE WITH THE MECHANICAL EQUIPMENT RECOMMENDATIONS AND THE NATIONAL ELECTRIC CODE.
- PERFORM ALL WIRING AND CONNECTION (POWER AND CONTROL) NOT INDICATED IN THE ELECTRICAL DRAWINGS AND NECESSARY FOR THE PROPER OPERATION OF THE MECHANICAL EQUIPMENT IN STRICT ACCORDANCE WITH THE NATIONAL ELECTRIC CODE
- TAKE EVERY PRECAUTION IN ORDER TO MINIMIZE OR ELIMINATE THE TRANSMISSION OF NOISE OR VIBRATION FROM THE EQUIPMENT, PIPING SYSTEM OR DUCT SYSTEM TO THE CONDITIONING SPACE.
- EQUIPMENT, MATERIALS AND ACCESSORIES SHALL BE SIMILAR TO THE INDICATED SPECIFICATION AND/OR MANUFACTURER MODEL OR CATALOG NUMBER.
- UNLESS OTHERWISE NOTED IN DRAWINGS AND/OR SPECIFICATIONS ALL EQUIPMENT AND ACCESSORIES SHALL BE FURNISHED AND INSTALLED BY THE CONTRACTOR.

CIVIL SITE GENERAL NOTES

- ALL DISTANCES AND ELEVATIONS ARE EXPRESSED IN METERS UNLESS OTHERWISE SPECIFIED. ELEVATIONS ARE REFERRED TO MEAN SEA LEVEL.
- COORDINATES ARE BASED ON THE LAMBERT PROJECTION FOR PUERTO RICO AND THE US VIRGIN ISLAND AND REFERENCED TO THE NORTH AMERICAN DATUM OF 1983 (NAD83 NA2011) EPOCH 2010.00 ADJUSTED IN
- THE CONTRACTOR SHALL COORDINATE WITH THE CONSTRUCTION MANAGER BEFORE CUTTING OR TRIMMING EXISTING TREES AFFECTED BY THE CONSTRUCTION. THE CONTRACTOR SHALL PREPARE AND SUBMIT FOR EACH PROJECT AREA. THE CONTROL OF EROSION AND
- SEDIMENTATION (CES) PLAN FOR APPROVAL BY THE PERTINENT AGENCY AND THE CONSTRUCTION MANAGER. THE CONTRACTOR SHALL PROVIDE AND MAINTAIN A DEWATERING SYSTEM TO KEEP SUBGRADES DRY AND CONVEY GROUND WATER AWAY FROM EXCAVATIONS. THE DEWATERING PLAN SHALL BE SUBMITTED TO THE CONSTRUCTION MANAGER FOR APPROVAL AND COORDINATION. DEWATERING PLANS SHALL INCLUDE CONTROL OF EROSION AND SEDIMENTATION FOR EACH PROJECT
- PHASE AND/OR WORK AREA. THE WATER FROM THE DEWATERING SYSTEM SHALL BE FREE OF SEDIMENT AND/OR DEBRIS BEFORE ANY DISPOSAL THE CONTRACTOR SHALL MAINTAIN THE DEWATERING SYSTEM UNTIL DEWATERING IS NO LONGER
- ELECTRICAL, COMMUNICATION, SANITARY AND POTABLE WATER SERVICE SHALL NOT BE INTERRUPTED
- DURING CONSTRUCTION. IF NECESSARY, A PROVISIONAL TEMPORARY SERVICE AND/OR BY-PASS SHALL BE INSTALLED TO MAINTAIN SERVICE. PROVISIONAL TEMPORARY SERVICE AND/OR BY-PASS SHALL BE SUBMITTED TO THE CONSTRUCTION MANAGER FOR APPROVAL AND COORDINATION PRIOR TO CONSTRUCTION. THE CONTRACTOR SHALL PREPARE AND SUBMIT THE MAINTENANCE OF SERVICE PLAN FOR ELECTRICAL, SANITARY AND POTABLE WATER FOR APPROVAL OF THE CONSTRUCTION MANAGER.
- THE CONTRACTOR SHALL NOTIFY THE CONSTRUCTION MANAGER IF ANY ELEMENT SUSPECTED OF CONTAINING HAZARDOUS MATERIAL IS ENCOUNTERED, PRIOR TO ANY RELATED WORK ACTIVITY. THE CONTRACTOR SHALL VISIT THE PROJECT AREA TO VERIFY THE SPACE LIMITATIONS FOR CONSTRUCTION
- PROCESS AND EQUIPMENT. THE CONTRACT PRICE SHALL CONSIDER THE REQUIRED CONSTRUCTION PROCESS AND/OR EQUIPMENTS. PRIOR TO COMMENCEMENT OF THE WORK, CONTRACTOR SHALL VERIFY ALL DIMENSIONS AND EXISTING CONDITIONS AT PROJECT SITE AND SHALL NOTIFY THE CONSTRUCTION MANAGER OF ANY DISCREPANCIES BETWEEN EXISTING CONDITIONS AND CONTRACT DOCUMENTS THAT COULD AFFECT CONSTRUCTION WORK
- SCHEDULE AND /OR PERFORMANCE. ALL DETAILS, SECTIONS AND NOTES SHOWN ON DRAWINGS ARE INTENDED TO BE TYPICAL AND SHALL APPLY TO SIMILAR SITUATIONS ELSEWHERE UNLESS OTHERWISE NOTED.
- THE CONTRACTOR SHALL REPAIR OR REPLACE EXISTING FACILITIES DAMAGED DURING CONSTRUCTION PRIOR TO SUBSTANTIAL COMPLETION
- THE CONTRACTOR SHALL MAINTAIN IN OPERATION EXISTING FACILITIES UNTIL NEW FACILITIES ARE IN OPERATION.

STRUCTURAL BUILDING AND DESIGN CODES:

- PUERTO RICO BUILDING CODE 2018 AND ITS BINDING REFERENCED STANDARDS, INCLUDING BUT NOT LIMITED TO:
 - THE INTERNATIONAL BUILDING CODE 2018 AMERICAN INSTITUTE FOR STEEL CONSTRUCTION (AISC), STEEL CONSTRUCTION MANUAL, 15 TH EDITION AMERICAN CONCRETE INSTITUTE (ACI), BUILDING CODE REQUIREMENTS FOR STRUCTURAL CONCRETE, ACI 318-14
- AMERICAN SOCIETY OF CIVIL ENGINEERS, MINIMUM DESIGN LOADS AND ASSOCIATED CRITERIA FOR BUILDINGS AND OTHER STRUCTURES, ASCE/SEI 7-16

STRUCTURAL NOTES ON CONCRETE REPAIR:

- ALL CONCRETE REPAIR WORKS SHALL BE PERFORMED FOLLOWING THE GUIDELINES OF THE INTERNATIONAL CONCRETE REPAIR INSTITUTE (ICRI). HIRING A PROFESSIONAL EXPERIENCED IN THIS TYPE OF REPAIR IS RECOMMENDED TO ENSURE A PROPER
- FOR THE REPAIR OF AREAS AFFECTED BY CORROSION, ICRI NO. 03730 GUIDELINE FOR SURFACE PREPARATION FOR THE REPAIR OF DETERIORATED CONCRETE RESULTING FROM REINFORCING STEEL CORROSION SHOULD BE FOLLOWED BEFORE COMMENCING ANY CONCRETE REPAIR WORK, THE CONTRACTOR SHALL REVIEW THE REPAIR DETAILS PRESENTED IN THE DRAWINGS. IN CASE OF DOUBT WITH THE REPAIR DETAILS PRESENTED, THE CONTRACTOR SHOULD CONTACT THE ARCHITECT OR ENGINEER OF RECORD TO CLARIFY THEM.
- IT IS IMPORTANT TO FOLLOW THE MANUFACTURER'S RECOMMENDATIONS FOR EACH PRODUCT UTILIZED FOR THIS JOB, IN ORDER TO GUARANTEE THAT THE REPAIR WORKS ARE CARRIED OUT ADEQUATELY.

STRUCTURAL NOTES ON CAST-IN-PLACE CONCRETE:

PORTLAND CEMENT SHALL BE TYPE II. ALL CONCRETE SHALL BE OF REGULAR WEIGHT (145 POUNDS PER CUBIC FOOT).

THE FOLLOWING CONCRETE MIX PARAMETERS SHALL BE USED UNLESS OTHERWISE NOTED:

- CONCRETE STRENGTH AT 28 DAYS 3,000 PSI MAX. WATER/CEMENT RATIO - 0.65 RECOMMENDED SLUMP – 3 INCHES
- MAX. AGGREGATE SIZE (ASTM C33) 1 INCH PROVIDE CONCRETE MIXES DESIGNED BY A QUALIFIED TESTING LABORATORY FOR REVIEW AND APPROVAL BY THE STRUCTURAL ENGINEER. CONCRETE MIX DESING SHALL BE SIGNED AND SEALED BY A PROFESSIONAL ENGINEER AUTHORIZED TO

NOTE ON REINFORCING STEEL BARS:

- ALL REINFORCING STEEL SHALL BE NEW STOCK DEFORMED BARS CONFORMING TO ASTM A615, GRADE 60 (FY = 60 KSI). MAINTAIN THE FOLLOWING CONCRETE COVERAGE FOR REINFORCING STEEL UNLESS NOTED OTHERWISE:
- CONCRETE CAST AGAINST EARTH: 3 INCHES

EXERCISE THE PROFESSION IN THE COMMOM WEALTH OF PUERTO RICO.

- CONCRETE IN CONTACT WITH THE GROUND: 2 INCHES
- CONCRETE SLAB AND WALLS WITHOUT CONTACT WITH GROUND: 1 INCHES
- CONCRETE BEAMS AND COLUMNS: 1 1/2 INCHES

STRUCTURAL STEEL

- DESIGN, DETAIL AND ERECT STRUCTURAL STEEL ELEMENTS IN ACCORDANCE WITH THE FOLLOWING:
- AISC SPECIFICATION FOR THE DESIGN, FABRICATION, AND ERECTION OF STRUCTURAL STEEL FOR BUILDINGS.
- AISC MANUAL OF STEEL CONSTRUCTION, ALLOWABLE STRESS DESIGN. AISC CODE OF STANDARD PRACTICE FOR STEEL BUILDINGS AND BRIDGES.
- AWS STRUCTURAL WELDING CODE, D1.1.
- STRUCTURAL STEEL SHALL CONFORM TO THE FOLLOWING GRADES: W SHAPES: ASTM A992 (FY = 50 KSI, FU = 65 KSI)
- STEEL ANGLE, CHANNELS, PLATES: ASTM A36
- BOLTS, NUTS AND WASHERS: HIGH-STRENGTH BOLTS, INCLUDING NUTS AND WASHERS: ASTM A325
- STEEL PLATES FOR LANDINGS AND THREADS: 1/4" ANTI-SLIP DIAMOND TYPE STEEL PLATE A36
- WELDING ELECTRODE FOR STEEL SHALL BE E70XX.

- PROVIDE DESIGN, FABRICATION, AND ERECTION OF METAL DECK CONFORMING TO THE STEEL DECK INSTITUTE'S "CODE OF RECOMMENDED STANDARD PRACTICE AND BASIC DESIGN SPECIFICATIONS"
- FORM ROOF DECK FROM STEEL SHEETS CONFORMING TO ASTM A 611 GRADE C AND D OR A 653 OR HIGHER SPECIFICATIONS WITH A MINIMUM YIELD STRENGTH OF 33 KSI. ATTACH SHEETS TO STEEL SUPPORT MEMBERS AS INDICATED AND IN ACCORDANCE WITH THE MANUFACTURER'S INSTRUCTIONS
- FOR INSTALLATION. WHEN DECK IS SCHEDULED TO BEEXPOSED, DE-SLAG, CLEAN AND TOUCH UP WELDS WITH A ZINC-RICH LAP ROOF AND FLOOR DECK ENDS MINIMUM OF 2 INCHES. WHEN FASTENING DECK TO SUPPORT MEMBERS PROVIDE WELDING MATERIALS INSTALLATION PROCEDURES TO PREVENT BURNING OF HOLES IN DECK.
- AT ENDS OF DECKS OR WHERE CHANGES OF DECK DIRECTION OCCUR. FASTEN TO SUPPORTS AT EACH FLUTE. PROVIDE ADEQUATE CLOSURES AND FASTENERS TO SIDES AT EIGHTEEN INCHES ON CENTER. WHERE PARTIAL PANELS MAY BE REQUIRED TO COMPLETE DECK INSTALLATION AT PERIMETER OF STRUCTURE, PROVIDE WELDS IN EACH FLUTE TO STRUCTURAL MEMBERS. INSTALL DECK IN THREE CONTINUOUS SPAN LENGTHS. AT PERIMETER OF DECK, SECURE DECK TO STRUCTURAL MEMBERS WITH SAME ATTACHMENTAND SPACING SUPPORT
- ATTACHMENT AS INDICATED ON PLANS. HOT DIP GALVANIZE (G90) AFTER FABRICATION ALL METAL DECK AND TOUCH UP CONNECTIONS WITH A ZINC-RICH PRIMER.

NOTES (IF APPLICABLE):

TREE REMOVAL:

- REMOVE ALL TREES INDICATED BY THE DRAWINGS AND SPECIFICATIONS, AS REQUIRING REMOVAL, IN A MANNER THAT WILL NOT DAMAGE ADJACENT TREES OR STRUCTURES OR COMPACTS THE SOIL.
- REMOVE TREES THAT ARE ADJACENT TO TREES OR STRUCTURES TO REMAIN, IN SECTIONS, TO LIMIT THE OPPORTUNITY OF DAMAGE TO ADJACENT CROWNS, TRUNKS, GROUND PLANE ELEMENTS AND STRUCTURES.
- DO NOT DROP TREES WITH A SINGLE CUT UNLESS THE TREE WILL FALL IN AN AREA NOT INCLUDED IN THE TREE AND PLANT PROTECTION AREA. NO TREE TO BE REMOVED WITHIN 50 FEET OF THE TREE AND PLANT PROTECTION AREA SHALL BE PUSHED OVER OR UP-ROOTED USING A PIECE OF GRADING EQUIPMENT. PROTECT ADJACENT PAVING, SOIL, TREES, SHRUBS, GROUND COVER PLANTINGS AND UNDERSTORY PLANTS TO REMAIN FROM

DAMAGE DURING ALL TREE REMOVAL OPERATIONS, AND FROM CONSTRUCTION OPERATIONS. PROTECTION SHALL INCLUDE THE

- ROOT SYSTEM, TRUNK, LIMBS, AND CROWN FROM BREAKAGE OR SCARRING, AND THE SOIL FROM COMPACTION. REMOVE STUMPS AND IMMEDIATE ROOT PLATE FROM EXISTING TREES TO BE REMOVED. GRIND TRUNK BASES AND LARGE BUTTRESS ROOTS TO A DEPTH OF THE LARGEST BUTTRESS ROOT OR AT LEAST 18 INCHES BELOW THE TOP MOST ROOTS WHICH EVER IS LESS AND OVER THE AREA OF THREE TIMES THE DIAMETER OF THE TRUNK (DBH). FOR TREES WHERE THE STUMP WILL FALL UNDER NEW PAVED AREAS, GRIND ROOTS TO A TOTAL DEPTH OF 18 INCHES BELOW THE EXISTING GRADE. IF THE SIDES OF THE STUMP HOLE STILL HAVE GREATER THAN APPROXIMATELY 20% WOOD VISIBLE, CONTINUE GRINDING OPERATION DEEPER AND OR WIDER UNTIL THE RESULTING HOLE HAS LESS THAN 20% WOOD. REMOVE ALL WOOD CHIPS PRODUCED BY THE GRINDING OPERATION AND BACK FILL IN 8 INCH LAYERS WITH CONTROLLED FILL OF A QUALITY
- DENSITY STANDARD PROCTOR. THE OWNER'S REPRESENTATIVE SHALL APPROVE EACH HOLE AT THE END OF THE GRINDING OPERATION IN AREAS WHERE THE TREE LOCATION IS TO BE A PLANTING BED OR LAWN, REMOVE ALL WOODCHIPS AND BACKFILL STUMP HOLES WITH PLANTING SOIL AS DEFINED IN SPECIFICATION SECTION PLANTING SOIL, IN MAXIMUM OF 12 INCH LAYERS AND COMPACT TO 80 - 85% OF THE MAXIMUM DRY DENSITY STANDARD PROCTOR.

ACCEPTABLE TO THE SITE ENGINEER FOR FILL MATERIAL UNDER STRUCTURES, COMPACTED TO 95% OF THE MAXIMUM DRY

- WITHIN SIX MONTHS OF THE ESTIMATED DATE OF SUBSTANTIAL COMPLETION, PRUNE ALL DEAD OR HAZARDOUS BRANCHES
- LARGER THAN 2 INCH IN DIAMETER FROM ALL TREES TO REMAIN. IMPLEMENT ALL PRUNING RECOMMENDATIONS FOUND IN THE ARBORIST REPORT PRUNE ANY LOW, HANGING BRANCHES AND VINES FROM EXISTING TREES AND SHRUBS THAT OVERHANG WALKS, STREETS AND DRIVES, OR PARKING AREAS AS FOLLOWS:
 - 1. WALKS WITHIN 8 FEET VERTICALLY OF THE PROPOSED WALK ELEVATION.
 - 2. PARKING AREAS WITHIN 12 FEET VERTICALLY OF THE PROPOSED PARKING SURFACE ELEVATION.
 - 3. STREETS AND DRIVES WITHIN 14 FEET VERTICALLY OF THE PROPOSED DRIVING SURFACE ELEVATION.
- ALL PRUNING SHALL BE DONE IN ACCORDANCE WITH ANSI A300 (PART 1), ISA BMP TREE PRUNING (LATEST EDITION, AND THE "STRUCTURAL PRUNING: A GUIDE FOR THE GREEN INDUSTRY", EDWARD GILMAN, BRIAN KEMPF, NELDA MATHENY AND JIM CLARK,
- 2013 URBAN TREE FOUNDATION, VISALIA CA. PERFORM OTHER PRUNING TASK AS INDICATED ON THE DRAWINGS OR REQUESTED BY THE OWNER'S REPRESENTATIVE. WHERE TREE SPECIFIC DISEASE VECTORS REQUIRE, STERILIZE ALL PRUNING TOOLS BETWEEN THE WORK IN INDIVIDUAL TREES.

GENERAL DRAWING SYMBOLS:

ABBREVIATIONS:

ALUMINUM

CORRIDOR

CORROSION

ELEVATION

FLOOR DRAIN

HARDWARE

MASONRY

MECHANICAL

JANITOR CLOSE

NOT APPLICABLE

SMOOTH CEMENT PLASTER

UNLESS OTHERWISE NOTE

ROOF DRAIN

REQUIRED

STAINLESS STEEL

STORM SEWER

STRUCTURAL

T.O.S.

TOP OF MASONRY

DROP MANHOLE

VERIFY IN FIELD

TOP OF STEEL

TELEPHONE

HEIGHT


CENTER TO CENTER


CONCRETE MASONRY UNIT

FINISH FLOOR ELEVATIONS

FINISH FLOOR LEVEL

EXISTING WALL NEW CONCRETE BLOCK WALL 6" OR 8" NEW PLYCEM BOARD WALL

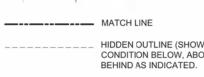

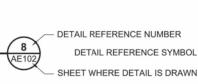



 SHEET WHERE SECTION IS DRAW! - WALL SECTION REFERENCE NUMBER WALL SECTION

- SHEET WHERE WALL SECTION IS DRAWN

- SHEET WHERE INT. ELEV. IS DRAWN

INTERIOR ELVATION SYMBOL

ELEVATION REFERENCE NUMBER



NORTH ARROW

KEY NOTE



RISER SYMBOL ROOM IDENTIFICATION

— ROOM NUMBER



HANDICAPPED SYMBOL

AIR CONDITIONING

THIS DOCUMENT REPRESENTS THE IDEAS AND EFFORTS OF CSA ARCHITECTS AND ENGINEERS. IT SHALL BE USED ONLY BY AUTHORIZED PERSONS AND SHALL NOT BE REPRODUCED OR EXHIBITED WITHOUT WRITTEN CONSENT OF

CSA ARCHITECTS AND ENGINEERS.

PUERTO RICO INDUSTRIAL DEVELOPMENT COMPANY PRIDCO

ISSUE FOR BID

FEBRUARY 21, 2024

- 1	REV	DATE	DESCRIPTION
F			
F			
H			
-			
L			
c [
	DISCIP	LINE INF	ORMATION:
		FESIONAL:	
	ANNET	TE ALFON	SO
P	ROFESSIO	ONAL OF RECO	RD:
/	ANNET	TE ALFONS	SO
S	TAFF DES	IGNER:	
_	INAHOL	NA SALCEI	DO
C	C. AUDIT	OR:	
	RINCIPAL	CAD TECHNICI	IAN:

PROFESSIONAL'S STATEMENT:

YO, ANNETTE ALFONSO

CERTIFICO QUE SOY EL PROFESIONAL QUE [CONFECCIONÓ, DISEÑÓ O PREPARÓ] ESTOS PLANOS TAMBIÉN, CERTIFICO QUE ENTIENDO QUE DICHOS PLANOS Y ESPECIFICACIONES CUMPLEN CON LAS DISPOSICIONES APLICABLES DEL REGLAMENTO CONJUNTO Y LAS DISPOSICIONES APLICABLES DE LOS REGLAMENTOS Y CÓDIGOS DE CONSTRUCCIÓN VIGENTES DE LAS AGENCIAS. JUNTAS REGLAMENTADORAS O CORPORACIONES PÚBLICAS CON JURISDICCIÓN. CERTIFICO, ADEMÁS, QUE EN LAPREPARACIÓN DE ESTOS PLANOS Y ESPECIFICACIONES SE HA CUMPLIDO CABALMENTE CON LO DISPUESTO EN LA LEY NÚM. 14 DE 8 DE ENERO DE 2004, SEGÚN ENMENDADA, CONOCIDA COMO LA "LEY PARA LA INVERSIÓN POR LA INDUSTRIA PUERTORRIQUEÑA" Y CON LA [LEY NÚM. 319 DE 15 DE MAYO DE 1938, SEGÚN ENMENDADA; LEY NÚM. 96 DE 6 DE JULIO DE 1978, SEGÚN ENMENDADA: SEGÚN APLIQUEI, RECONOZCO QUE CUALQUIER DECLARACIÓN FALSA O FALSIFICACIÓN DE LOS HECHOS QUE SE HAYA PRODUCIDO POR DESCONOCIMIENTO O POR NEGLIGENCIA YA SEA POR MÍ, MIS AGENTES O EMPLEADOS, O POR OTRAS PERSONAS CON MI CONOCIMIENTO. ME HACEN RESPONSABLE DE CUALQUIER ACCIÓN JUDICIAL Y

PRIDCO DAMAGE IMPROVEMENTS **NORTH REGION STAGE 1 BID PACKAGE N1-3**

PW: 8144 / ARECIBO

DISCIPLINARIA POR LA OGPE.

SHEET TITLE:

GENERAL NOTES, ABBREVIATIONS AND LEGEND

AS SHOWN


PROJECT NUMBER:

21-0258-02


BIM FILE NAME:

DELIVERY DATE PRINT DATE & TIME: 4/22/2024 3:28:58 PM


DRAWING / MODEL LOCATION:

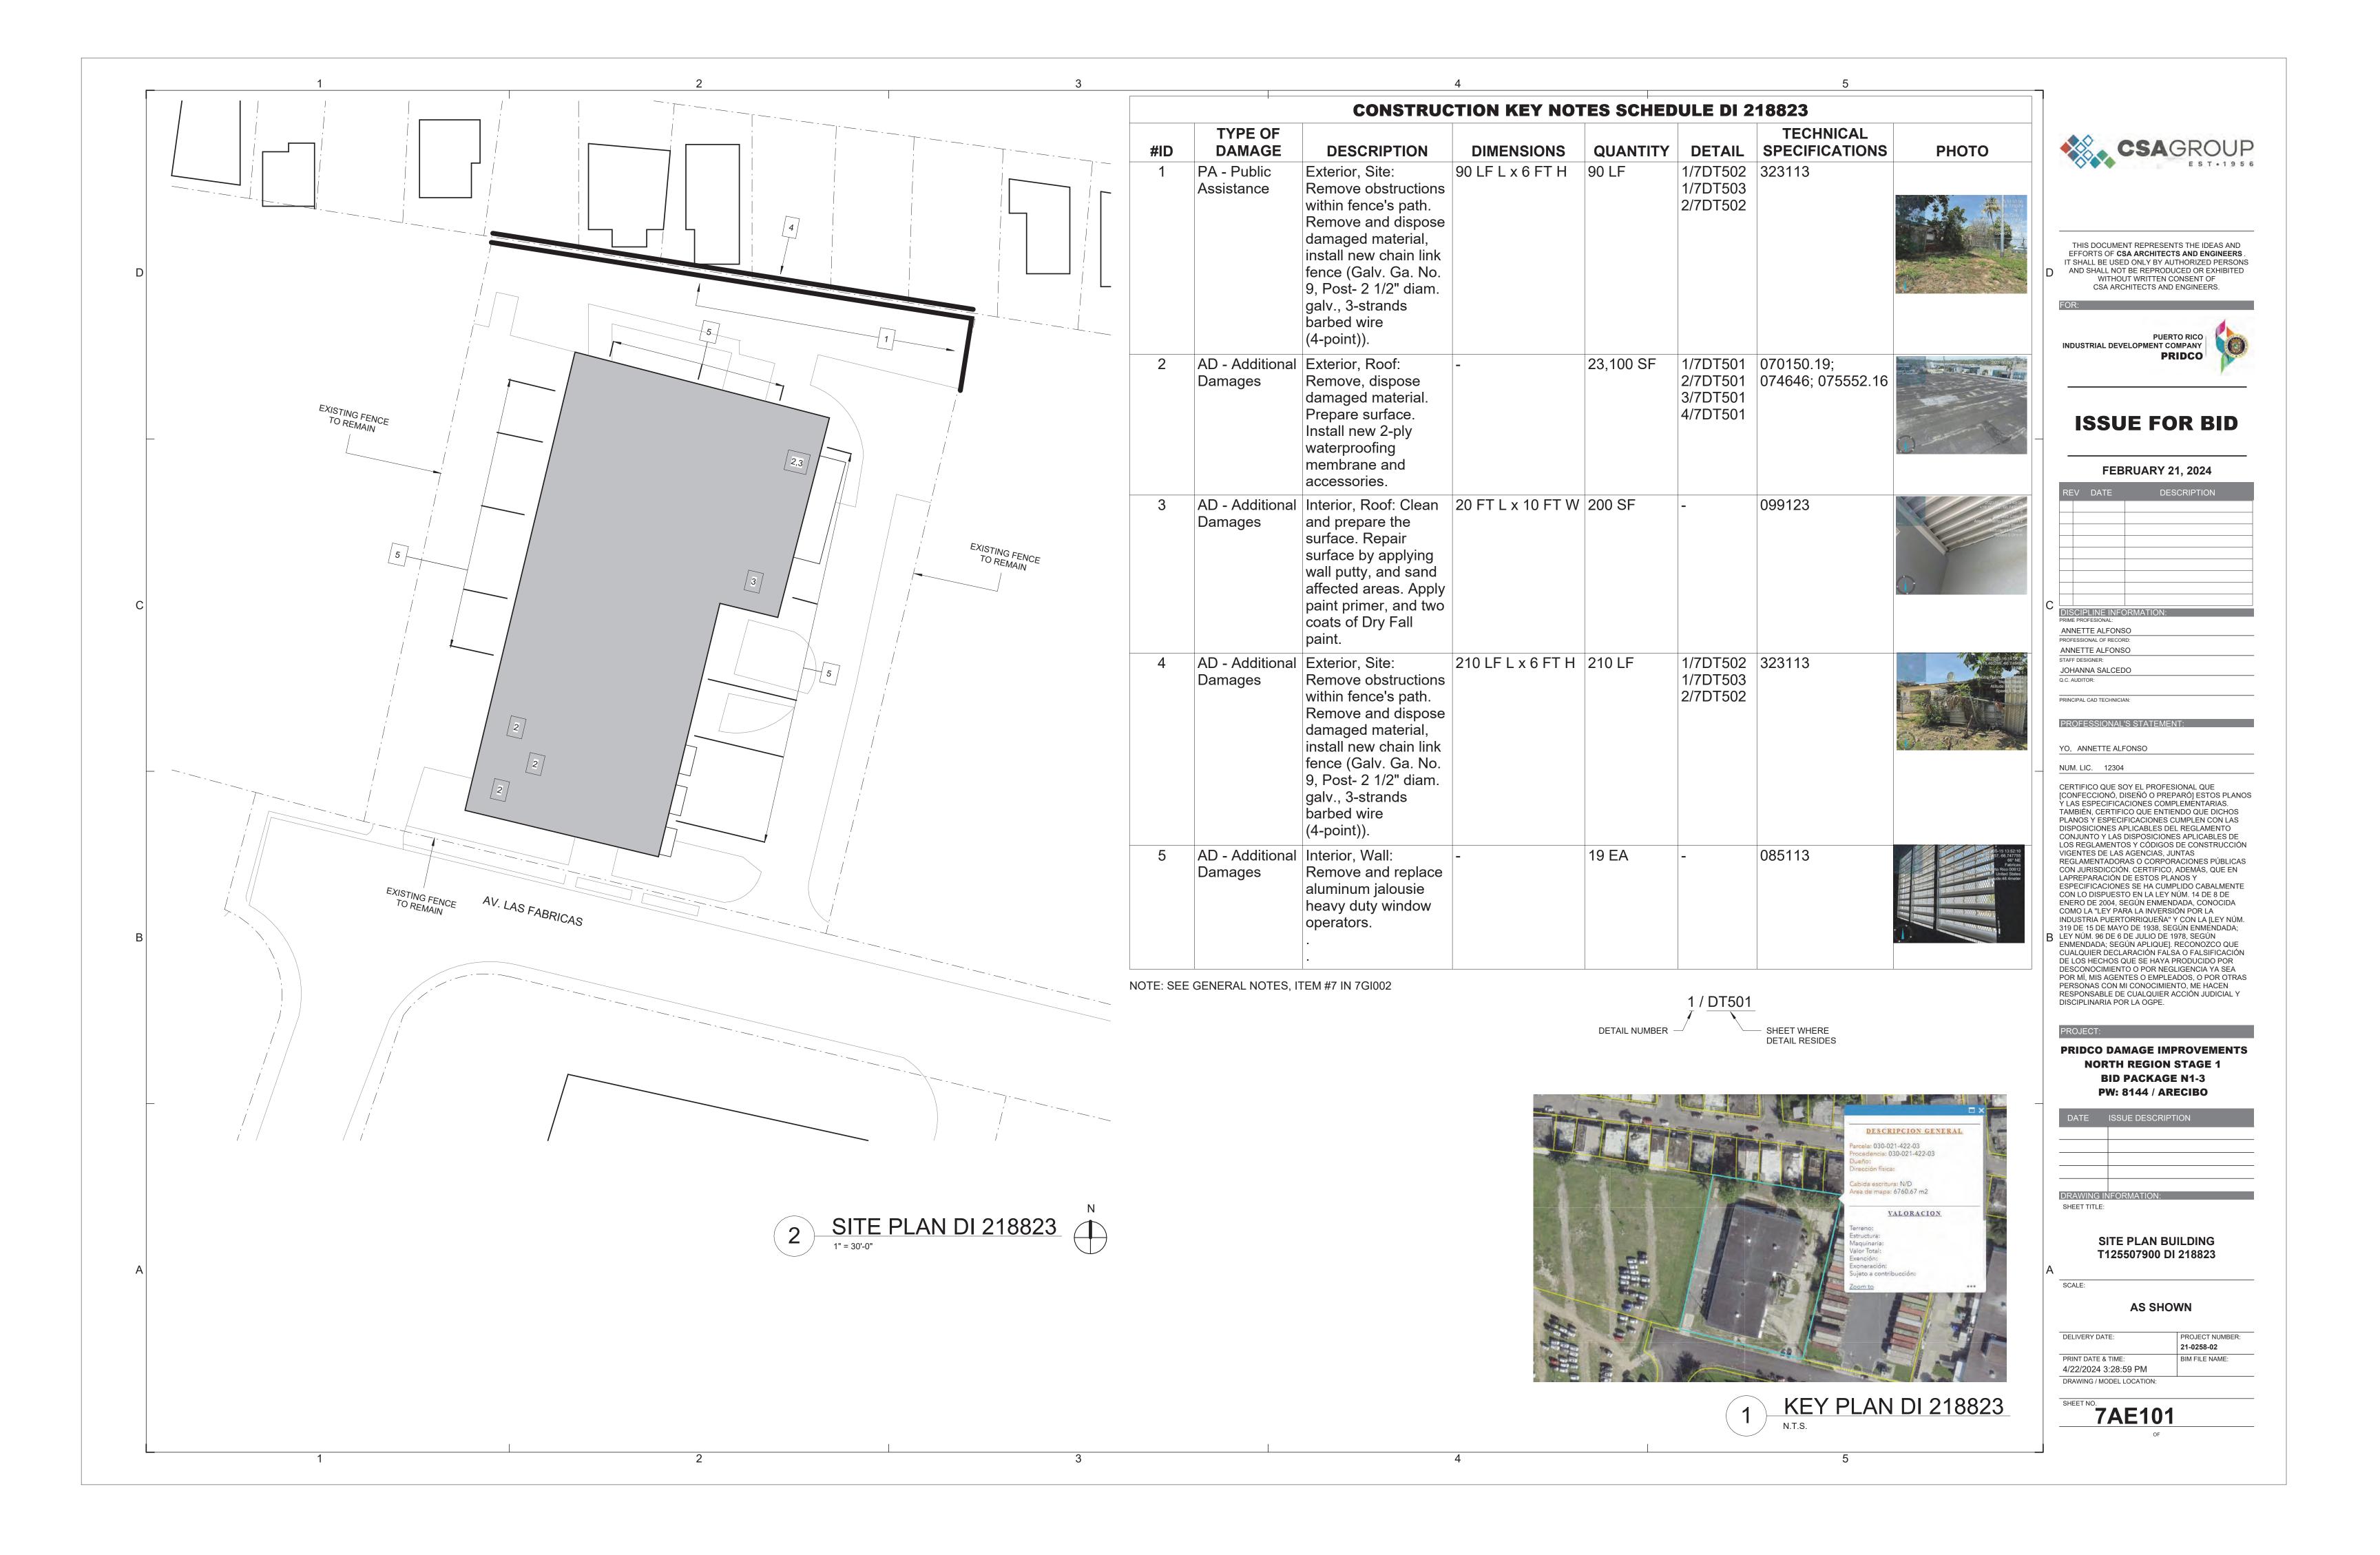

2 5

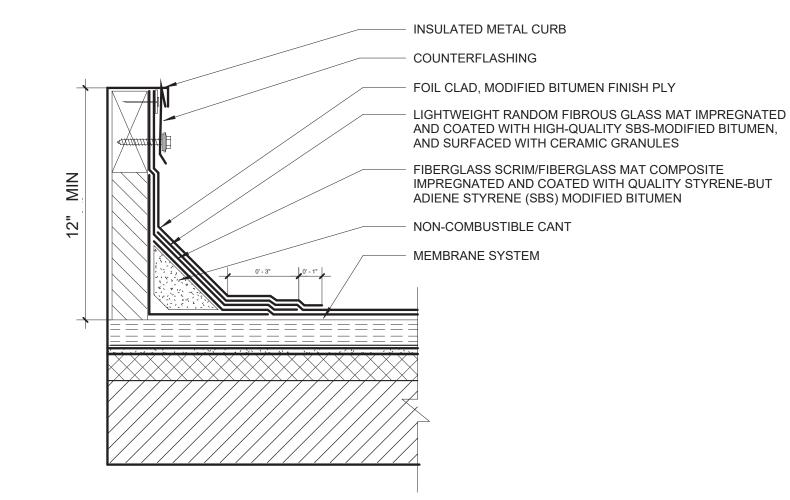


FLASHING AT EXHAUST FAN CURB DETAIL N.T.S.

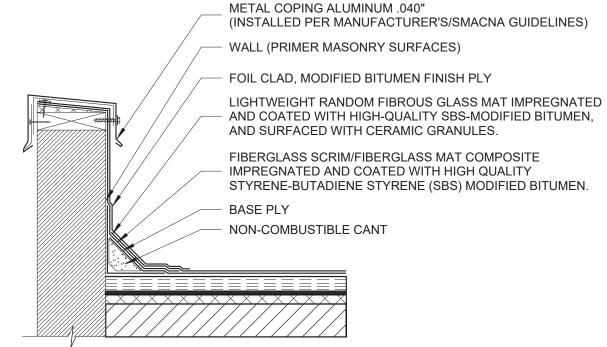

2 CAP FLASHING DETAIL

N.TS.

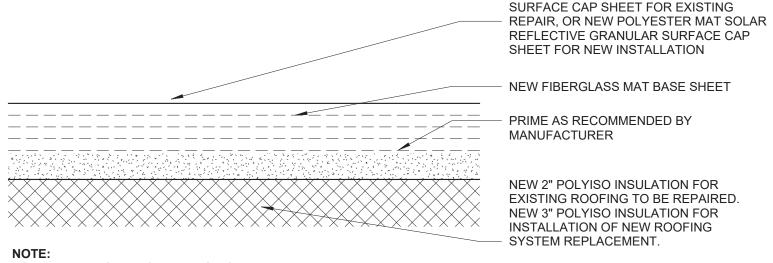

NOTE:
FOR REPAIR WORK INSTALLATION OF NEW MEMBRANE
MUST BEGIN AT LOWER PORTION OF ROOF MOVE UP
TOWARDS UPPER ROOF RIDGE. NEW MEMBRANE MUST
OVERLAP AT LEAST 3'-0" FROM REPAIRED PATCH PORTION
ON ALL SIDES. CONTRACTOR TO VERIFY IN FIELD.

2-PLY SBS BITUMINOUS

MEMBRANE SECTION

N.T.S.



THIS DOCUMENT REPRESENTS THE IDEAS AND EFFORTS OF **CSA ARCHITECTS AND ENGINEERS**. IT SHALL BE USED ONLY BY AUTHORIZED PERSONS AND SHALL NOT BE REPRODUCED OR EXHIBITED WITHOUT WRITTEN CONSENT OF CSA ARCHITECTS AND ENGINEERS.

PUERTO RICO INDUSTRIAL DEVELOPMENT COMPANY



ISSUE FOR BID

FEBRUARY 21, 2024

l .					
	REV	/ DATE		DESCRIPTION	
С					
	DISC	CIPLINE	INFC	ORMATION:	
	PRIME F	PROFESIONA	L:		
	ANNI	ETTE ALF	ONS	SO	
	PROFES	SSIONAL OF F	RECOR	RD:	
	ANNE	ETTE ALF	ONS	80	
l	CTAFF	DECICNED.			_

STAFF DESIGNER:

JOHANNA SALCEDO
Q.C. AUDITOR:

PRINCIPAL CAD TECHNICIAN:

PROFESSIONAL'S STATEMENT:

YO, ANNETTE ALFONSO

NUM. LIC. 12304


CERTIFICO QUE SOY EL PROFESIONAL QUE [CONFECCIONÓ, DISEÑÓ O PREPARÓ] ESTOS PLANOS TAMBIÉN, CERTIFICO QUE ENTIENDO QUE DICHOS PLANOS Y ESPECIFICACIONES CUMPLEN CON LAS DISPOSICIONES APLICABLES DEL REGLAMENTO CONJUNTO Y LAS DISPOSICIONES APLICABLES DE LOS REGLAMENTOS Y CÓDIGOS DE CONSTRUCCIÓN VIGENTES DE LAS AGENCIAS, JUNTAS REGLAMENTADORAS O CORPORACIONES PÚBLICAS CON JURISDICCIÓN. CERTIFICO, ADEMÁS, QUE EN LAPREPARACIÓN DE ESTOS PLANOS Y ESPECIFICACIONES SE HA CUMPLIDO CABALMENTE CON LO DISPUESTO EN LA LEY NÚM. 14 DE 8 DE ENERO DE 2004, SEGÚN ENMENDADA, CONOCIDA COMO LA "LEY PARA LA INVERSIÓN POR LA INDUSTRIA PUERTORRIQUEÑA" Y CON LA [LEY NÚM. 319 DE 15 DE MAYO DE 1938, SEGÚN ENMENDADA; LEY NÚM. 96 DE 6 DE JULIO DE 1978, SEGÚN ENMENDADA; SEGÚN APLIQUE]. RECONOZCO QUE CUALQUIER DECLARACIÓN FALSA O FALSIFICACIÓN DE LOS HECHOS QUE SE HAYA PRODUCIDO POR DESCONOCIMIENTO O POR NEGLIGENCIA YA SEA POR MÍ, MIS AGENTES O EMPLEADOS, O POR OTRAS PERSONAS CON MI CONOCIMIENTO, ME HACEN RESPONSABLE DE CUALQUIER ACCIÓN JUDICIAL Y

PROJECT:

NEW POLYESTER MAT GRANULAR

DISCIPLINARIA POR LA OGPE.

PRIDCO DAMAGE IMPROVEMENTS NORTH REGION STAGE 1 BID PACKAGE N1-3 PW: 7801 / QUEBRADILLAS

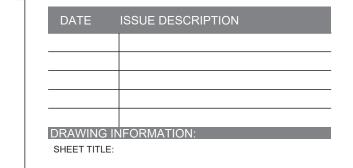

DETAILS AND SPECIFICATIONS

AS SHOWN


DELIVERY DATE:

PROJECT NUMBER:
21-0258-02

PRINT DATE & TIME:
4/22/2024 3:29:03 PM

DRAWING / MODEL LOCATION:

7DT501

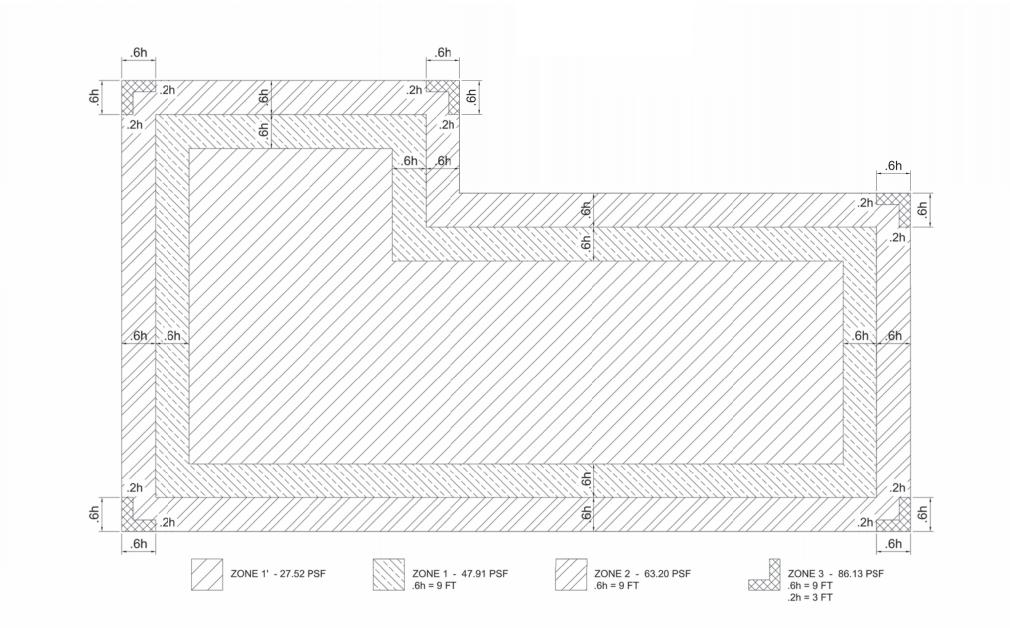

WIND PRESSURES - COMPONENTS & CLADDING

NOTES:

1. THE FOLLOWING PARAMETERS WERE USED TO COMPUTE THE WIND PRESSURES:

1.1. WIND SPEED = 152 MPH (AS PER PR BUILDING CODE 2018 AND ASCE 7-16)

1.2. COMPONENTS AND CLADDING (C&C) CALCULATIONS PER CH 30 PART 2

1.3. MEAN ROOF HEIGHT (h) = 15 FT

1.4. THE PRESSURES SHOWN ARE UNFACTORED (ASD).


2. THE CONTRACTOR IS RESPONSIBLE TO PROVIDE THIS INFORMATION TO THE ROOF INSULATION AND ROOF MEMBRANE MANUFACTURERS.

3. THE ROOF INSULATION AND ROOF MEMBRANE MANUFACTURERS ARE RESPONSIBLE TO PROVIDE THE REQUIRED ANCHORAGE RECOMMENDATIONS OF THEIR PRODUCTS TO THE ROOF METAL DECK BASED OF THE PROVIDED WIND PRESSURES.

WIND PRESSURES COMPONENTS & CLADDING
N.T.S.

3

* * * * * * * * * * ALUM TOP RAIL OR POSTS TIES RAIL OR BRACE END BRACE → □□ TENSION BAR BRACE ROD TURNBUCKLE FINISHED GRADE LINE

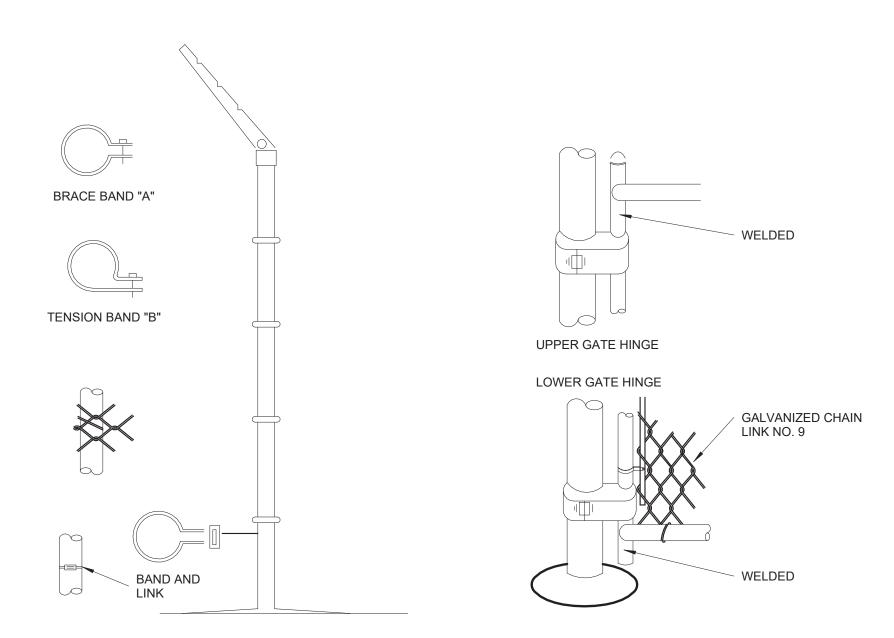


INSTALLATION DETAILS FOR 2 CHAIN LINK FENCE & GATES

N.T.S.

NOTES:

- 1. CHAIN LINK FENCE INDUSTRIAL TYPE NO.423
- 2. LINE POSTS 2 1/2" O.D. GALV. STD.WEIGHT PIPE-3.85 LBS. PER LIN. FT.
- 3. TOP RAIL 1 5/8" O.D. GALV. STD.WEIGHT PIPE-2.27 LBS. PER LIN. FT. (GATE FRAME IDEM.)
- 4. CORNER POST 3"Ø O.D. GALV. STD. WEIGHT PIPE 6.79 LBS. PER LIN. FT.
- 5. TENSION WIRE GA. NO.7 GALVANIZED
- 6. GATE POST 4"O.D. GALV. STD. WEIGHT PIPE 9.10 LBS. PER LIN. FT.
- 7. GALVANIZED CHAIN LINK GA. 9-2"X2"-1.2 OUNCES GALVANIZED AFTER WOOVEN.
- 8. STD. WEIGHT PIPE, SCHEDULE 40A. 120
- 9. TUBULAR STEEL PIPE SHALL BE INSTALL EVERY 50'-0" PANEL SPAN (SPAN=10'-0')
- TUBULAR STEEL PIPE SHALL BE INSTAL EVERY DIRECTIONS CHANGE IN THE FENCE. TUBULAR STEEL PIPE SHALL BE INSTALL AT EACH FENCE END PANEL.
- 10. ALL FITTINGS EXTRA HEAVY DUTY.
- 11. MILL CERTIFICATE SHALL BE SUBMITTED.

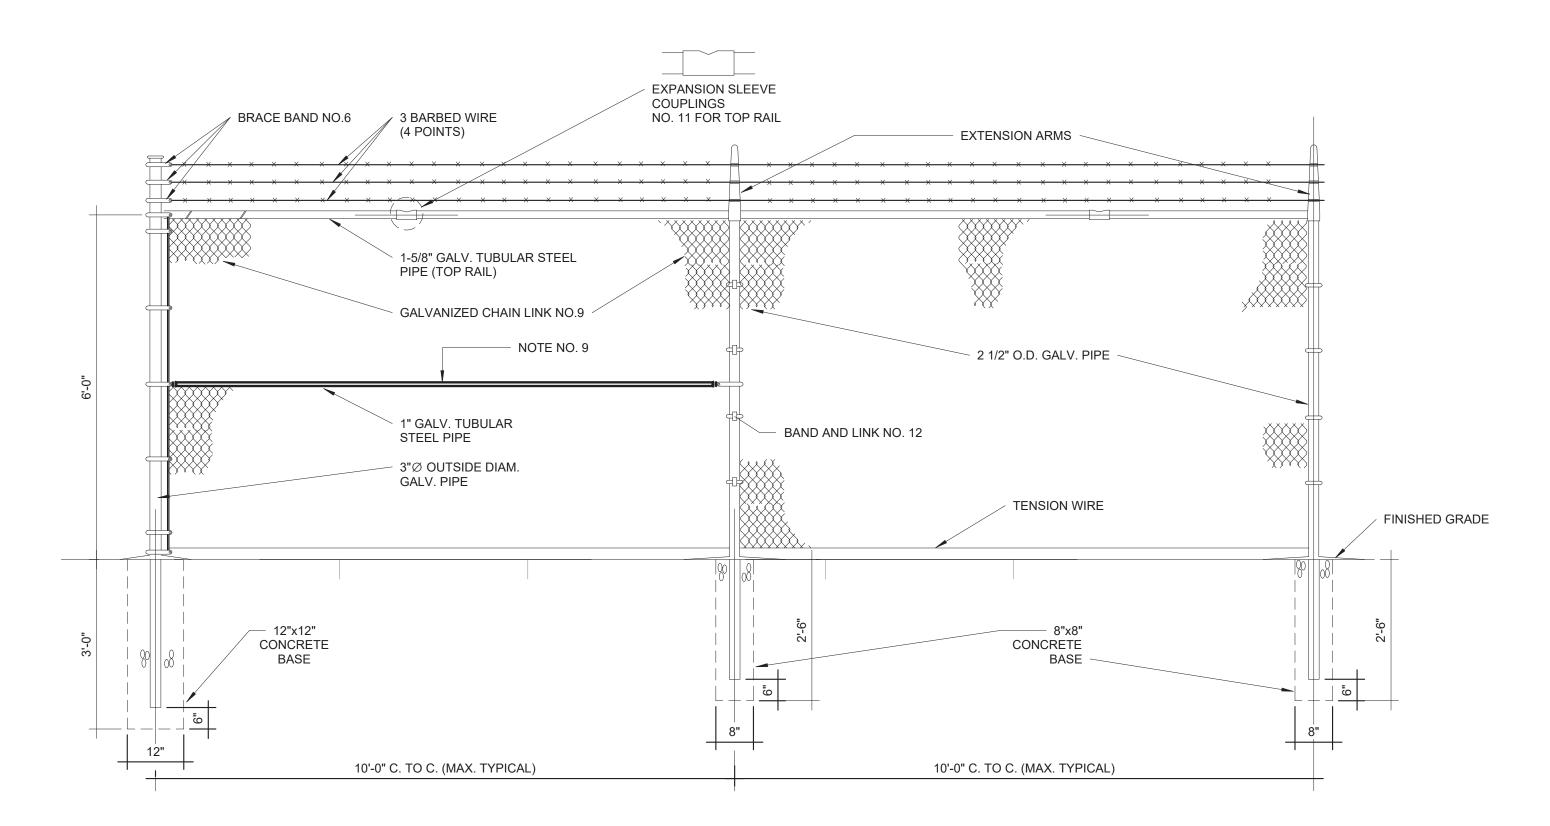

CHAIN LINK FENCE WITH BARBED WIRE PARTIAL ELEVATION 1 (ALONG PROPERTY LIMITS)

N.T.S.



THIS DOCUMENT REPRESENTS THE IDEAS AND EFFORTS OF CSA ARCHITECTS AND ENGINEERS. IT SHALL BE USED ONLY BY AUTHORIZED PERSONS AND SHALL NOT BE REPRODUCED OR EXHIBITED WITHOUT WRITTEN CONSENT OF

CSA ARCHITECTS AND ENGINEERS.

PUERTO RICO INDUSTRIAL DEVELOPMENT COMPANY PRIDCO



FEBRUARY 21, 2024

| | RE | V | DAT | ГΕ | DESCRIPTION | |
|---|-----|--------------|------|------|-------------|--|
| | | | | | | |
| | | | | | | |
| | | | | | | |
| | | | | | | |
| | | | | | | |
| | | | | | | |
| С | | | | | | |
| U | DIS | CIP
E PRO | LINE | INFO | ORMATION: | |

ANNETTE ALFONSO

JOHANNA SALCEDO

PRINCIPAL CAD TECHNICIAN:


PROFESSIONAL'S STATEMENT:

YO, ANNETTE ALFONSO

NUM. LIC. 12304

CERTIFICO QUE SOY EL PROFESIONAL QUE [CONFECCIONÓ, DISEÑÓ O PREPARÓ] ESTOS PLANOS TAMBIÉN, CERTIFICO QUE ENTIENDO QUE DICHOS PLANOS Y ESPECIFICACIONES CUMPLEN CON LAS DISPOSICIONES APLICABLES DEL REGLAMENTO CONJUNTO Y LAS DISPOSICIONES APLICABLES DE LOS REGLAMENTOS Y CÓDIGOS DE CONSTRUCCIÓN VIGENTES DE LAS AGENCIAS, JUNTAS REGLAMENTADORAS O CORPORACIONES PÚBLICAS CON JURISDICCIÓN. CERTIFICO, ADEMÁS, QUE EN LAPREPARACIÓN DE ESTOS PLANOS Y ESPECIFICACIONES SE HA CUMPLIDO CABALMENTE CON LO DISPUESTO EN LA LEY NÚM. 14 DE 8 DE ENERO DE 2004, SEGÚN ENMENDADA, CONOCIDA COMO LA "LEY PARA LA INVERSIÓN POR LA INDUSTRIA PUERTORRIQUEÑA" Y CON LA [LEY NÚM. 319 DE 15 DE MAYO DE 1938, SEGÚN ENMENDADA; LEY NÚM. 96 DE 6 DE JULIO DE 1978, SEGÚN ENMENDADA; SEGÚN APLIQUE]. RECONOZCO QUE CUALQUIER DECLARACIÓN FALSA O FALSIFICACIÓN DE LOS HECHOS QUE SE HAYA PRODUCIDO POR DESCONOCIMIENTO O POR NEGLIGENCIA YA SEA POR MÍ, MIS AGENTES O EMPLEADOS, O POR OTRAS PERSONAS CON MI CONOCIMIENTO, ME HACEN RESPONSABLE DE CUALQUIER ACCIÓN JUDICIAL Y DISCIPLINARIA POR LA OGPE.


PRIDCO DAMAGE IMPROVEMENTS NORTH REGION STAGE 1 BID PACKAGE N1-3 PW: 8144 / ARECIBO

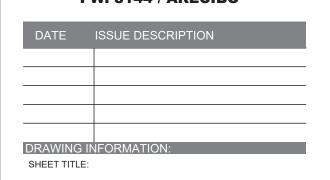

DETAILS AND SPECIFICATIONS


AS SHOWN

DELIVERY DATE: PROJECT NUMBER: 21-0258-02 PRINT DATE & TIME: BIM FILE NAME: 4/22/2024 3:29:04 PM DRAWING / MODEL LOCATION:

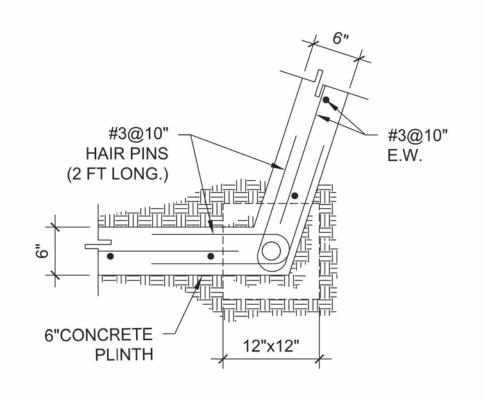


TOP VIEW

ADDITIONAL REINFORCEMENT AT FENCE POLE LOCATION (AT CORNERS)

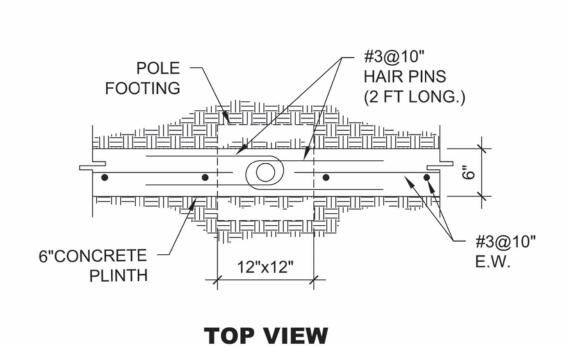


ADDITIONAL REINFORCEMENT AT FENCE POLE LOCATION

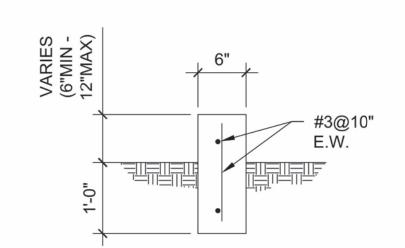

TYPICAL 6" CONCRETE
PLINTH SECTION

NOTES:

- 1. CHAIN LINK FENCE INDUSTRIAL TYPE NO.423
- 2. LINE POSTS 2 7/8" O.D. GALV. STD.WEIGHT PIPE.
- 3. TOP RAIL 1 5/8" O.D. GALV. STD.WEIGHT PIPE. PER LIN. FT. (GATE FRAME IDEM.)
- 4. CORNER POST 2 7/8" Ø O.D. GALV. STD. WEIGHT PIPE
- 5. TENSION WIRE GA. NO.7 GALVANIZED
- 6. GATE POST 4"O.D. GALV. STD. WEIGHT PIPE 9.10 LBS. PER LIN. FT.
- 7. GALVANIZED CHAIN LINK GA. 9-2"X2"-1.2 OUNCES GALVANIZED AFTER WOOVEN.
- 8. STD. WEIGHT PIPE, SCHEDULE 40A. 120
- 9. TUBULAR STEEL PIPE SHALL BE INSTALL EVERY 50'-0" PANEL SPAN (SPAN=10'-0')
 TUBULAR STEEL PIPE SHALL BE INSTAL EVERY DIRECTIONS CHANGE IN THE FENCE.
 TUBULAR STEEL PIPE SHALL BE INSTALL AT EACH FENCE END PANEL.
- 10. ALL FITTINGS EXTRA HEAVY DUTY.
- 11. MILL CERTIFICATE SHALL BE SUBMITTED.

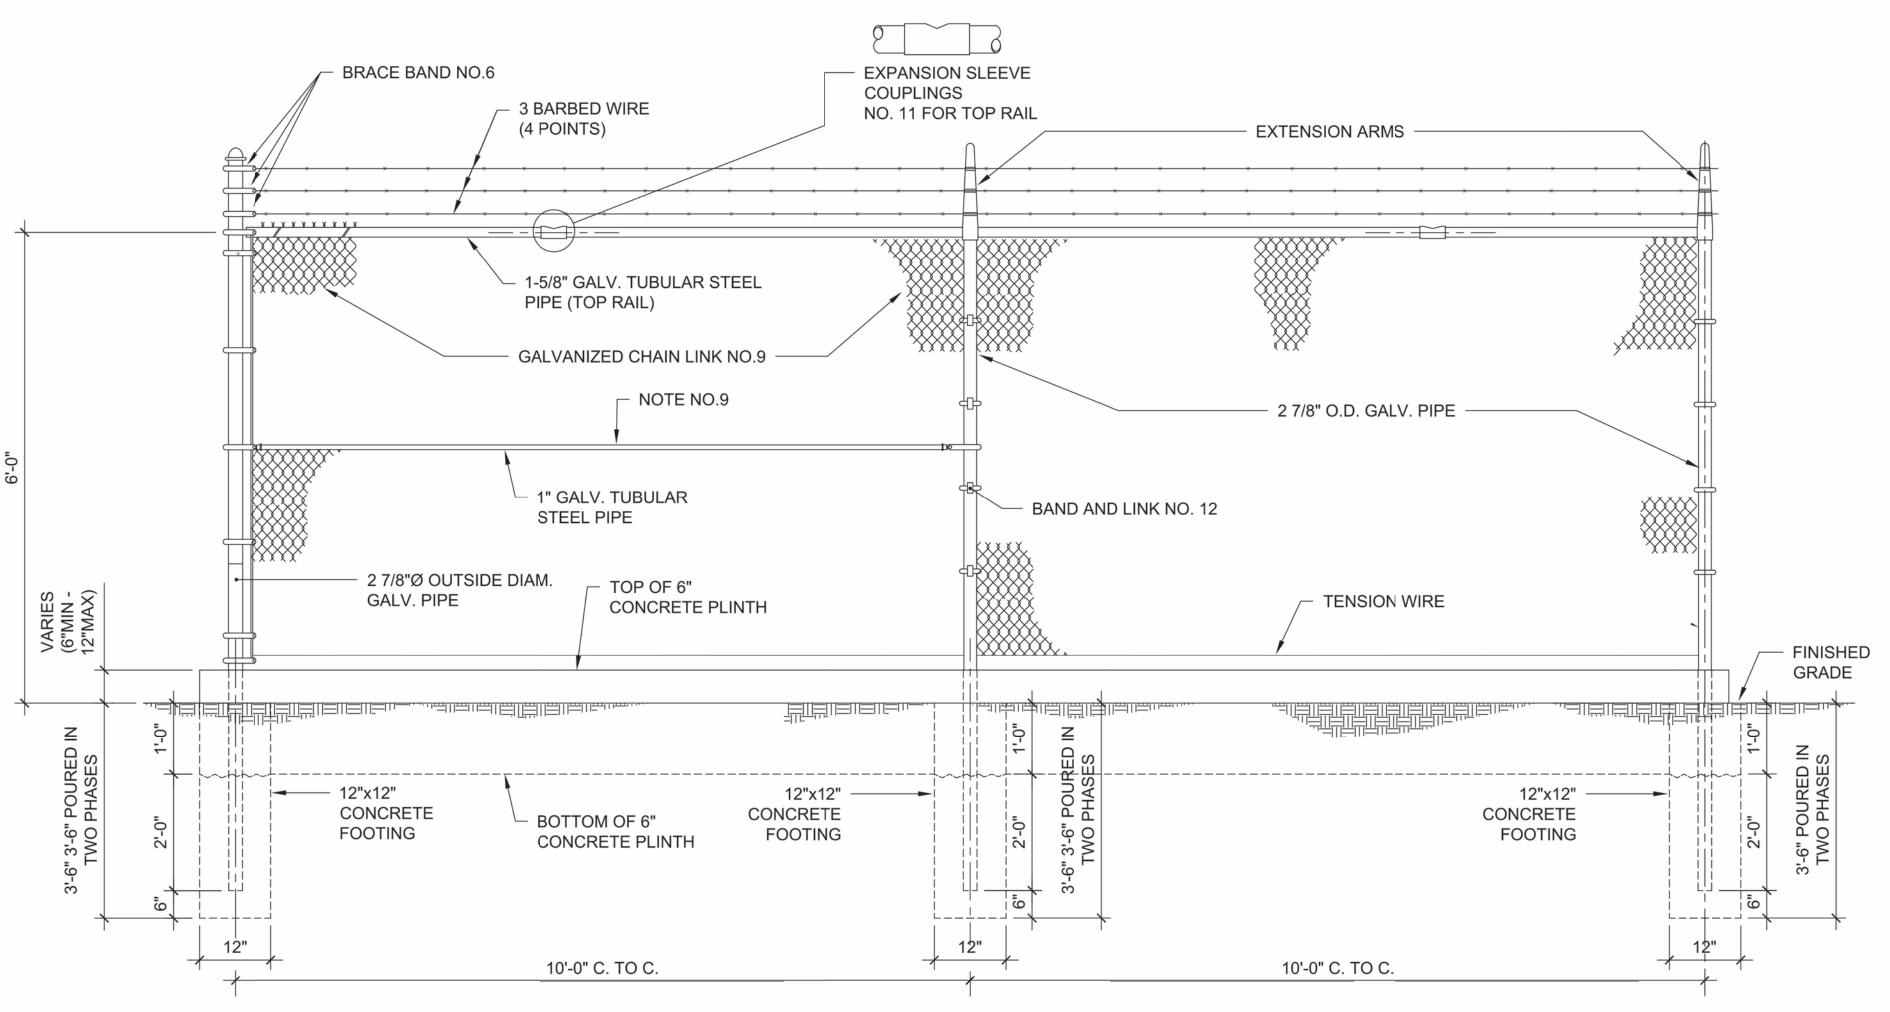

CHAIN LINK FENCE PARTIAL ELEVATION (ALONG PROPERTY LIMITS)

CHAIN LINK FENCE WITH BARBED

WIRE AND CONCRETE PLINTH

N.T.S.



THIS DOCUMENT REPRESENTS THE IDEAS AND EFFORTS OF **CSA ARCHITECTS AND ENGINEERS**. IT SHALL BE USED ONLY BY AUTHORIZED PERSONS AND SHALL NOT BE REPRODUCED OR EXHIBITED WITHOUT WRITTEN CONSENT OF CSA ARCHITECTS AND ENGINEERS.

PUERTO RICO
INDUSTRIAL DEVELOPMENT COMPANY
PRIDCO

ISSUE FOR BID

FEBRUARY 21, 2024

| | RE | V | DATE | DESCRIPTION | |
|---|-------------------------|-------------------------|------|-------------|--|
| С | | | | | |
| | | | | | |
| | | | | | |
| | | | | | |
| | | | | | |
| | | | | | |
| | | | | | |
| | | | | | |
| | | | | | |
| | DISCIPLINE INFORMATION: | | | | |
| | PRIME PROFESIONAL: | | | | |
| | ANNETTE ALFONSO | | | | |
| | PROF | PROFESSIONAL OF RECORD: | | | |

ANNETTE ALFONSO
PROFESSIONAL OF RECORD:
ANNETTE ALFONSO
STAFF DESIGNER:

JOHANNA SALCEDO

PRINCIPAL CAD TECHNICIAN:

PROFESSIONAL'S STATEMENT:

YO, ANNETTE ALFONSO

NUM. LIC. 12304

CERTIFICO QUE SOY EL PROFESIONAL QUE [CONFECCIONÓ, DISEÑÓ O PREPARÓ] ESTOS PLANOS

TAMBIÉN, CERTIFICO QUE ENTIENDO QUE DICHOS PLANOS Y ESPECIFICACIONES CUMPLEN CON LAS DISPOSICIONES APLICABLES DEL REGLAMENTO CONJUNTO Y LAS DISPOSICIONES APLICABLES DE LOS REGLAMENTOS Y CÓDIGOS DE CONSTRUCCIÓN VIGENTES DE LAS AGENCIAS, JUNTAS REGLAMENTADORAS O CORPORACIONES PÚBLICAS CON JURISDICCIÓN. CERTIFICO, ADEMÁS, QUE EN LAPREPARACIÓN DE ESTOS PLANOS Y ESPECIFICACIONES SE HA CUMPLIDO CABALMENTE CON LO DISPUESTO EN LA LEY NÚM. 14 DE 8 DE ENERO DE 2004, SEGÚN ENMENDADA, CONOCIDA COMO LA "LEY PARA LA INVERSIÓN POR LA 319 DE 15 DE MAYO DE 1938, SEGÚN ENMENDADA; LEY NÚM. 96 DE 6 DE JULIO DE 1978, SEGÚN ENMENDADA; SEGÚN APLIQUE]. RECONOZCO QUE CUALQUIER DECLARACIÓN FALSA O FALSIFICACIÓN DE LOS HECHOS QUE SE HAYA PRODUCIDO POR DESCONOCIMIENTO O POR NEGLIGENCIA YA SEA POR MÍ, MIS AGENTES O EMPLEADOS, O POR OTRAS PERSONAS CON MI CONOCIMIENTO, ME HACEN RESPONSABLE DE CUALQUIER ACCIÓN JUDICIAL Y DISCIPLINARIA POR LA OGPE.

PROJECT: PRIDCO DAMAGE IMPROVEMENTS NORTH REGION STAGE 1 BID PACKAGE N1-3

DATE ISSUE DESCRIPTION

DRAWING INFORMATION:
SHEET TITLE:

DETAILS AND SPECIFICATIONS

AS SHOWN

DELIVERY DATE:

PROJECT NUMBER:
21-0258-02

PRINT DATE & TIME:
4/22/2024 3:29:07 PM

DRAWING / MODEL LOCATION: