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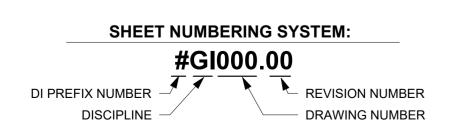
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METRO REGION STAGE 1 BID PACKAGE M1-4 PRIDCO-FEMA 4339 DR PROGRAM


REPAIR AND IMPROVEMENTS OF PUERTO RICO INDUSTRIAL BUILDINGS OF THE INDUSTRIAL DEVELOPMENT COMPANY FOR THE:


- 1. PW: 9522/ DI: 407776 / Bldg: #S075606600 / Mun: PR 778 KM 0.9, Vega Redonda, Comerio, PR 00782
- 2. PW: 8583 / DI: 407866 / Bldg: #T13940861 / Mun: Carr. #860, Bo. Las Cuevas, Trujillo Alto, Puerto Rico 00976
- 3. PW: 8583 / DI: 407868 / Bldg: #T142908800 / Mun: Carr. #860, Bo. Las Cuevas, Trujillo Alto, Puerto Rico 00976









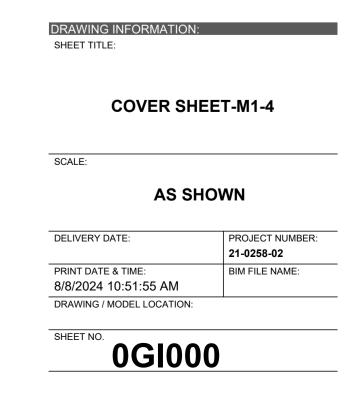


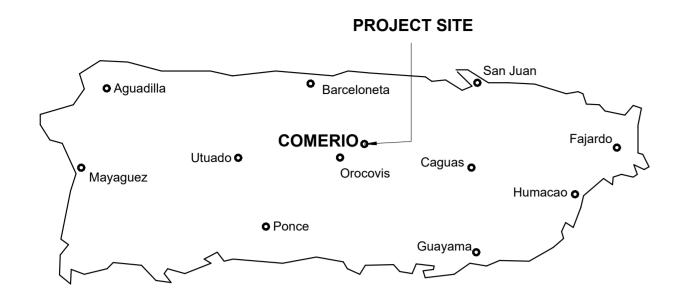

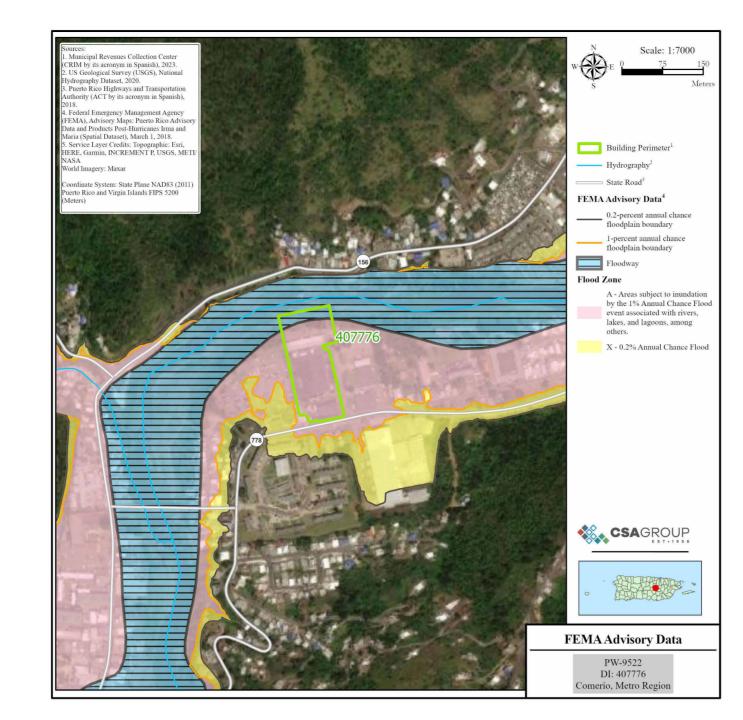

FLOOD MAP

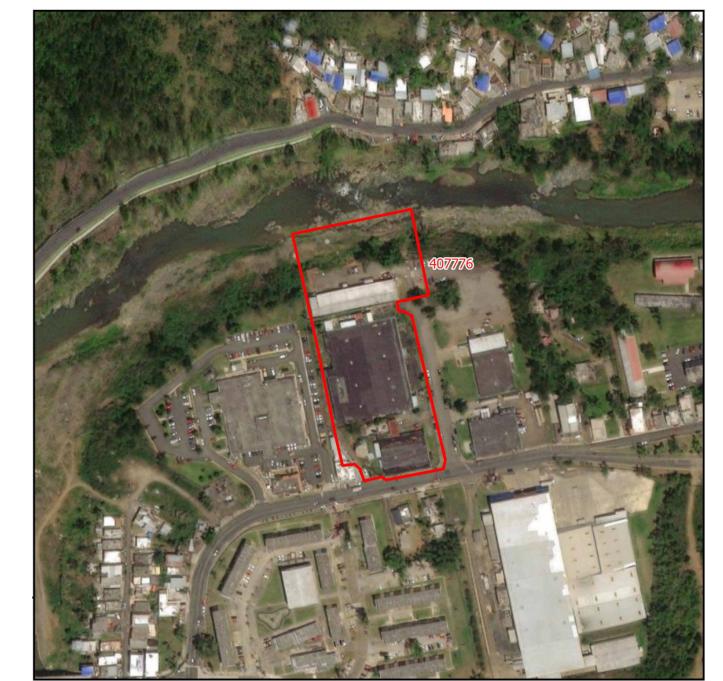

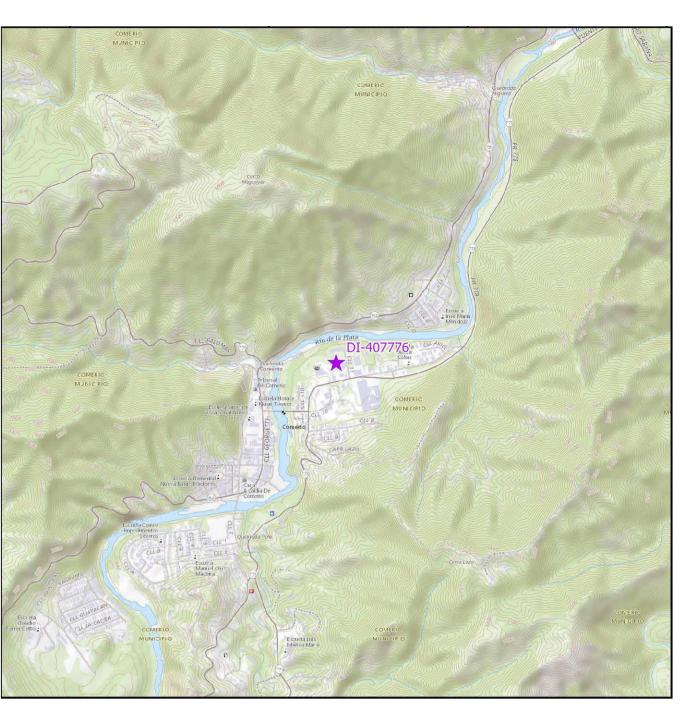

AERIAL PHOTO


LOCATION MAP
SCALE 1:20,000

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05DETAILS	1DT503		DETAILS AND SPECIFICATIONS				
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PRIDCO-FEMA 4339 DR PROGRAM METRO REGION STAGE 1 BID PACKAGE [M1-4]


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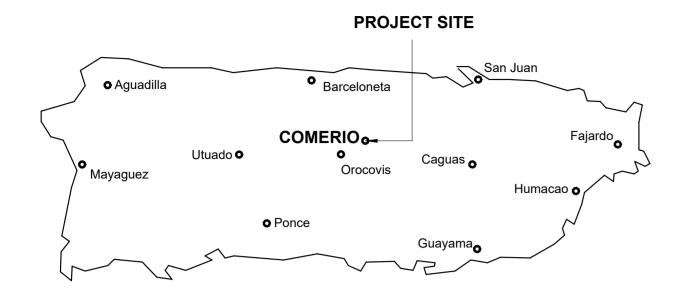
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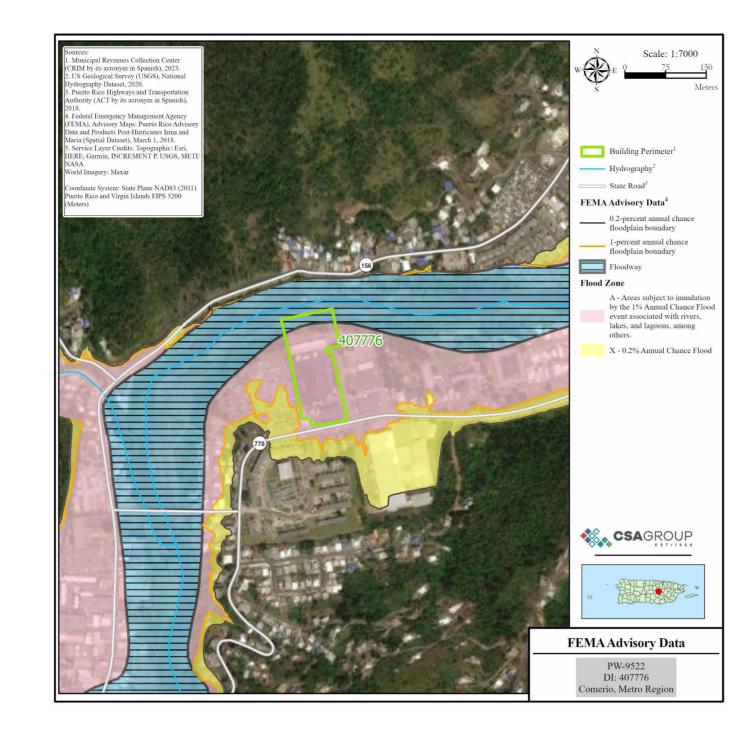








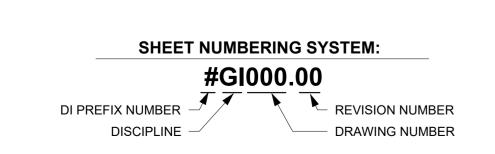



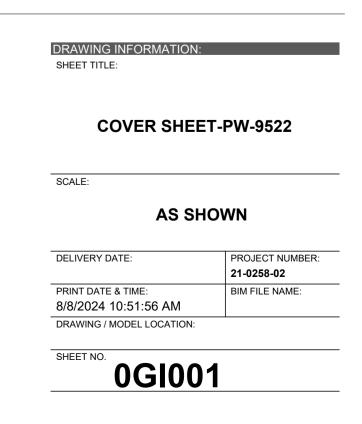

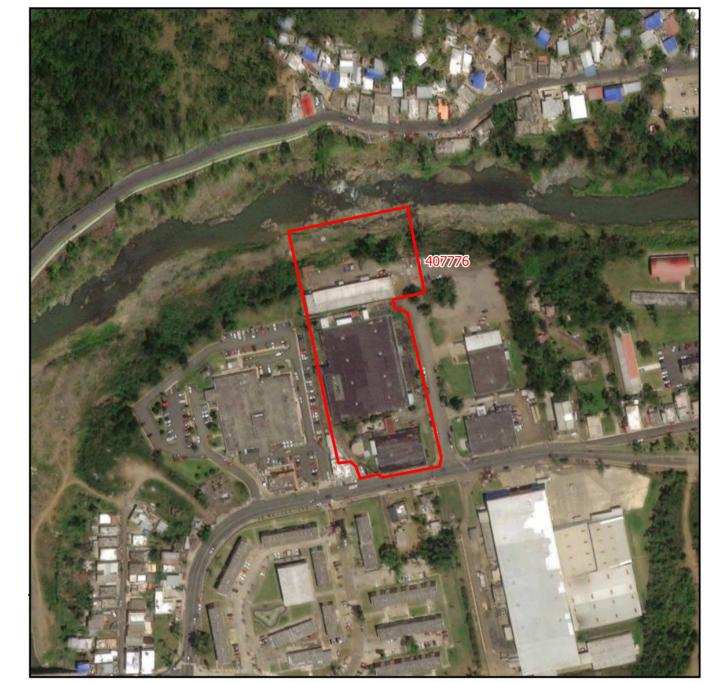

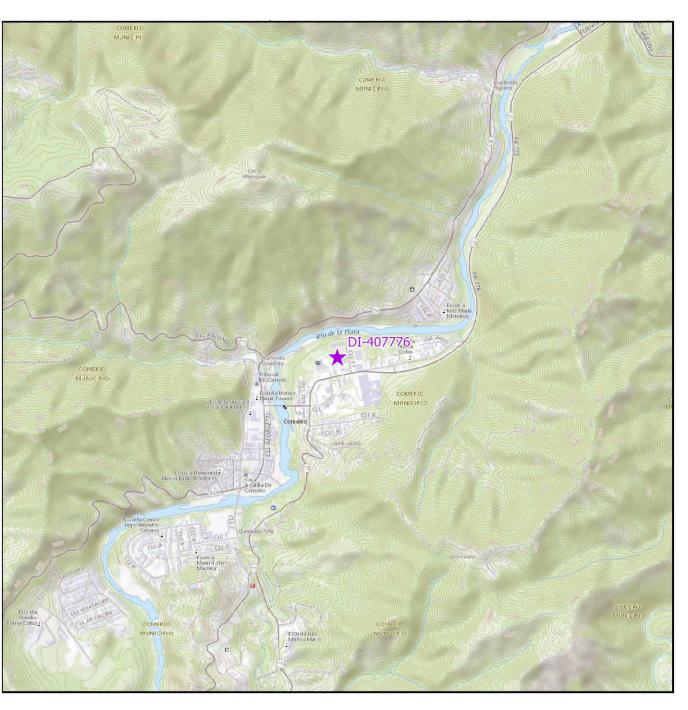


AERIAL PHOTO LOCATION MAP SCALE 1:20,000 18.223329, -66.222110

FLOOD MAP

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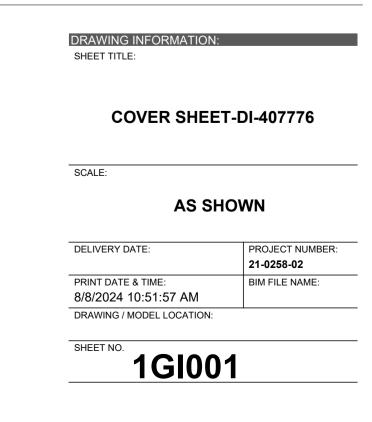
PRIDCO-FEMA 4339 DR PROGRAM METRO REGION STAGE 1 BID PACKAGE [M1-4]

1. PW: 9522/ DI: 407776 / Bldg: #S075606600 / Mun: PR 778 KM 0.9, Vega Redonda, Comerio, PR 00782



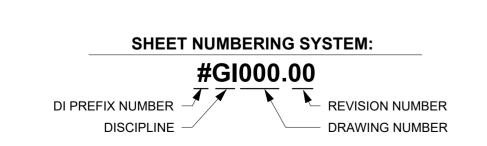





PERFORM WORK IN ACCORDANCE WITH OSHA RULES AND REGULATIONS.

COMPLY WITH THE REQUIREMENTS SET FORTH BY THE PR BUILDING CODE 2018,

PR FIRE CODE 2018, PR MECHANICAL CODE 2018, PR PLUMBING CODE 2018, PR

DE EMERGENCIA JUNE 16, 2023 AND WITH OTHER CODES, STANDARDS, AND

PERFORM WORK IN ACCORDANCE WITH ACCESSIBILITY COMPLIANCE AS PER

COMPLY WITH APPLICABLE RULES AND REGULATIONS FOR OBTAINING

NECESSARY TO PERFORM WORK AND SERVICES FOR THE PROJECT.

EXECUTE WORK IN ACCORDANCE WITH THE BEST ACCEPTED TRADE

NECESSARY AND REQUIRED INSPECTIONS, APPROVALS AND PERMITS

REGULATIONS CALLED FOR IN SAID CODES.

DISTURBANCE TO OCCUPANTS.

PER OSHA REQUIREMENTS

EXISTING BUILDING CODE 2018, ICC SUITE CODES 2018, REGLAMENTO CONJUNTO

PRACTICES, AS PER MANUFACTURER'S WRITTEN RECOMMENDATIONS, AND IN A

CAREFUL AND ORDERLY MANNER WITH THE LEAST POSSIBLE NOISE, DUST, OR

DAILY REMOVE DEBRIS RESULTING FROM DEMOLITION/CONSTRUCTION AND

DO NOT SCALE DRAWINGS. VERIFY DIMENSIONS IN THE FIELD BEFORE

PROCEDING WITH ANY PORTION OF THE WORK. ADVISE IN WRITING TO

COORDINATE CIVIL, MECHANICAL, ELECTRICAL, ARCHITECTURAL AND

SLEEVES, INSERTS, OPENINGS AND ROUGH-IN REQUIRED

CONSTRUCTION MANAGER AND ARCHITECT OF DISCREPANCY BETWEEN

TRANSPORT IT OUT OF PROJECT LIMITS. PERFORM DISPOSAL OPERATION IN

ACCORDANCE WITH GOVERNMENT APPROVALS AND REGULATIONS. SITE AND

STRUCTURE SHALL BE LEFT BROOM CLEANED FOR SUBSTANTIAL COMPLETION.

EXISTING CONDITIONS AND DRAWINGS PRIOR TO COMMENCING RELATED WORK.

REPORT TO CONSTRUCTION MANAGER AND ARCHITECT DISCREPANCIES IN THE

CONTRACT DRAWINGS, SPECIFICATIONS OR DETAILS PRIOR TO COMMENCING

STRUCTURAL REQUIREMENTS FOR PROPER LOCATION AND PROVISIONS OF

INTERFERENCE WITH ROADS, STREETS, SIDEWALKS AND OTHER ADJACENT

THE USE OF A BRAND NAME AND/OR MODEL NUMBER TO DENOTE PRODUCTS,

DO NOT COMMENCE ANY DEMOLITION OF SITE ELEMENTS OR STRUCTURE UNTIL

SPECIFIED TREE PRUNING OR CUTTING OR INCIDENTAL TO OTHER REPAIR WORK

THE HAZARDOUS MATERIAL ABATEMENT IS DONE AND EPA CERTIFICATION IS OBTAINED. STATING THAT THE SITE ELEMENTS AND STRUCTURES ARE FREE OF

HAZARDOUS MATERIALS. PRIOR TO COMMENCEMENT OF THE HAZARDOUS

IF APPLICABLE CONTRACTOR SHALL BE RESPONSIBLE FOR THE REMOVAL OR ENCAPSULATION OF LEAD/ASBESTOS FOUND IN THE PROJECT SITE, AS FOUND

SPECIALIZED COMPANY THAT WILL SUBMIT A MITIGATION PLAN, PERFORM AS

IN THE SITE STUDIES. CONTRACTOR SHALL ENGAGE THE SERVICES OF A

MAY REQUIRE A DRNA PERMIT. THE CONTRACTOR IS RESPONSIBLE FOR

CONDUCT DEMOLITION/CONSTRUCTION OPERATION TO INSURE MINIMUM

EQUIPMENTS, MATERIALS, OR PROCESS, IS INTENDED TO ESTABLISH A

STANDARD OF QUALITY AND SHALL NOT BE CONSTRUED AS LIMITING

MATERIAL ABATEMENT THE BUILDING AND SITE SHALL BE VACANT.

PROVIDE DOCUMENTATION ON PROCEDURES AND EXECUTION.

PRESSURE WASH, MINIMUM 3,000 PSI, EXISTING BUILDING EXTERIOR

OF MAJOR IMPERFECTIONS ON WALLS AND FINISHES IN GENERAL

CLEAN, REPAIR AND VERIFY STRUCTURAL INTEGRITY OF ROOF DECK

MEMBRANE TO VALIDATE THE WARRANTY.

NO CONDUIT SHALL BE SMALLER THAN 3/4".

ALL WIRE SHALL BE COPPER, INSULATED AS NOTED.

ELECTRICAL GENERAL NOTES

ENVELOPE

DEPARTMENT.

18.

EXPANSION JOINTS.

ALL LOADS SHALL BE BALANCED.

SLAB, WALLS AND OVERHANGS.

SPACED NOT FURTHER THAN 7'-6" APART

SHALL BE COLOR CODED AS PER N.E.C.

INDUSTRIAL DEVELOPMENT COMPANY.

INSTALLATION SHALL BE "FS" TYPE.

MATERIALS AND/OR EQUIPMENT.

REGULATIONS OF THE N.E.C. AND LUMA.

WALLS, WINDOWS, AND DOORS BEFORE BEGINNING SPECIFIED WORK

REPAIR INTERIOR AND EXTERIOR WALL SURFACES WITH CEMENT PLASTER

FULL TEAR-OFF OF ROOF WATERPROOFING SYSTEM INCLUDING MEMBRANE

INSULATION AND FLASHINGS WHERE SYSTEM REPLACEMENT IS SPECIFIED. A

PRIOR THE INSTALLATION OF THE WATERPROOFING SYSTEM. COMPLY WITH

THE MANUFACTURER RECOMMENDATIONS FOR THE INSTALLATION OF ROOF

COORDINATE WITH THE OWNER REPRESENTATIVE/CONSTRUCTION MANAGER

FOR INFORMATION REGARDING ROOFING MEMBRANE WARRANTIES PRIOR TO

THE INSTALLATION OF ANY ANCHORING DEVICES, INCLUDING BUT NOT LIMITED

WARRANTY. THE CONTRACTOR MUST VERIFY AND ENSURE THE INTEGRITY OF

THE WATERPROOFING SYSTEM DURING THE INSTALLATION OF EXHAUST FAN

ALL CONDUIT SHALL BE RIGID GALVANIZED EXCEPT OTHERWISE INDICATED.

ALL UNDERGROUND CONDUITS SHALL BE PROTECTED WITH 4" CONCRETE

EXPANSION FITTINGS SHALL BE USED FOR EVERY CONDUIT CROSSING BUILDING

PROVIDE A #12 GREEN THW BONDING JUMPER BETWEEN EACH OUTLET BOX

AND RECEPTACLE GROUNDING TERMINAL, USE 3/8" LONG 10-32 GROUNDING

EXPOSED CONDUITS SHALL BE SUPPORTED BY MEANS OF ONE BOLT CLAMP

ALL NON-GALVANIZED METAL PARTS SHALL BE GIVEN ONE COAT OF RED OXIDE

ALL GALVANIZED RIGID CONDUITS FOR TOGGLE SWITCHES AND RECEPTACLES

LOCATED AT DOORWAYS AND LEAN - TO SHALL BE CONCEALED WITHIN ROOF

PROVIDE ELECTRICAL SERVICE TO TEST ALL ELECTRICAL SYSTEM IN PRESENCE

ALL LIGHTING CIRCUITS SHALL HAVE ONE (1) PORCELAIN LIGHT SOCKET WITH A

THE NEUTRAL WIRES SHALL BE IDENTIFIED THROUGHT THE INSTALLATION BY

THE USE OF WHITE COLOR COVERED LIVE WIRES WITHIN THE SAME CONDUIT

ALL OVERHANGS AND LEAN - TO'S SHALL BE PROVIDED WITH LIGHT SOCKETS.

CONTACT THE DISTRICT ENGINEER OF LUMA PRIOR TO THE BEGINNING OF THE

ALL INSTALLATIONS SHALL BE IN ACCORDANCE WITH THE LATEST RULES AND

NUMBERS AND COMPLETE SPECIFICATIONS AND DRAWINGS FOR APPROVAL OF

VERIFY LENGTH OF FEEDERS IN THE FIELD BEFORE SUBMITTING BIDS.

OVERHANGS SHALL BE PROVIDED WITH STAINLESS STEEL COVERS.

ALL SWITCHES AND RECEPTACLES THAT ARE CONCEALED IN WALLS AND

WORK AND COORDINATE WITH THEM FOR THE EXECUTION OF THE WORK

CONCERNING THE SERVICE ENTRANCE AND SUBSTATION IF REQUIRED. IN

ADDITION, A CERTIFICATE OF INSPECTION SHALL BE OBTAINED AT THE

COMPLETION OF THE WORK AND FORWARDED TO THE PUERTO RICO

ALL BOXES FOR RECEPTACLES & LIGHTING SWITCHES FOR EXPOSED

A LIST OF MATERIALS AND EQUIPMENT GIVING MANUFACTURER CATALOG

P.R.I.D.C.O. SHALL BE SUBMITTED PRIOR TO THE PURCHASING OF SAID

ALL INSTALLATIONS SHALL BE EXPOSED UNLESS OTHERWISE INDICATED.

AN EXPOSED WORK CONDULET SHALL BE USED FOR ALL 90 BENDS.

OF THE REPRESENTATIVE FROM THE MECHANICAL AND ELECTRICAL

LED TYPE BULB, EQUIVALENT TO 100W INCANDESCENT LUMENS.

SWITCHES AND RECEPTACLES SHALL BE INSTALLED 4'-0" A.F.F.

CONNECTED TO 20 AMP BREAKERS AT THE PANELBOARD.

AND TWO COATS OF METALLIC GRAY PRIOR TO INSTALLATION.

TO THE EXHAUST FAN ANCHORING SYSTEM, TO AVOID INVALIDATING THE

ANCHORS, PROPERLY SEAL ANY PENETRATIONS, AND ACCEPT

NO WIRE SHALL BE SMALLER THAN # 12 AWG THHN, 600 VOLTS.

LEAVE A #12 AWG GALVANIZED FISH WIRE IN ALL EMPTY CONDUITS.

RESPONSIBILITY FOR MAINTAINING THE MEMBRANE'S WARRANTY

ROOF MOISTURE SURVEY MAY BE REQUIRED PRIOR TO INSTALLATION OF NEW

PRIOR TO APPLYING PAINT FINISH. REPAIR WORK INCLUDES, BUT IS NOT LIMITED

TO CUT AND PATCHING, REMOVAL OF NAILS AND SCREWS FROM WALLS, REPAIR

OBTAINING PERMIT BEFORE PERFORMING THE WORK.

THE PLUMBING DRAWING IS GENERALLY DIAGRAMATTIC AND INDICATIVE OF THE WORK TO BE INSTALLED. RUN ALL PIPING CONCEALED WHEREVER POSSIBLE UNLESS OTHERWISE NOTED.

VENT, HOT, AND COLD WATER LINES, THESE SLEEVES SHALL BE AS SPECIFIED OR REQUIRED BY THE

SIZES SHOWN IN FIXTURE SCHEDULE ARE MINIMUM AND SHALL BE INCREASED AS NECESSARY TO COMPLY

BEFORE CONSTRUCTION VERIFY EXISTING ELEVATIONS AGAINST PROPOSED SLOPES. ANY DISCREPANCIES SHALL BE BROUGHT TO THE ATTENTION OF THE ARCHITECT.

IMPLEMENT SAFETY CONTROLS DURING DEMOLITION/CONSTRUCTION WORK, AS 6. CLEANOUT SHALL BE OF SAME SIZE AS THE PIPES TO WHICH THEY ARE CONNECTED UP TO 4", FOR LARGE

> UNLESS OTHERWISE INDICATED, ALL DRAINAGE PIPING 3" AND SMALLER SHALL BE SLOPED 1/4" PER FT., LARGER PIPES SHALL BE SLOPED 1/8"PER FOOT.

CLEANOUT SHALL BE NOT MORE THAN 50 FEET AP-ART IN HORIZONTAL DRAINAGE LINES OF 4" NOMINAL DIAMETER OR LESS AND NOT MORE THAN 100 FEET APART FOR LARGER PIPES.

FOR FIXTURES AND EQUIPMENT NOT LISTED IN SCHEDULE, SEE CONTRACT SPECIFICATIONS.

WITH CODE REQUIREMENTS OR AS SHOWN ON DRAWINGS.

DETERMINE EXACT LOCATION OF THE PIPING TO AVOID ANY INTERFERENCE WITH PIPING AND/OR EQUIPMENT BEING INSTALLED BY ANOTHER SUB-CONTRACTOR.

SANITARY TEES (SINGLE AND DOUBLE) AND QUARTER BENDS SHALL BE ACCEPTABLE ONLY FOR CHANGES OF DIRECTION FROM HORIZONTAL TO VERTICAL

12. USE LONG SWEEPING FITTINGS AND/OR LONG SWEEP BENDS AT BASE OF ALL STACKS.

PROVIDE ROUGHING-IN AND INSTALL ALL PLUMBING FIXTURES AND/OR EQUIPMENT WHICH ARE SUPPLIED BY

FOR ALL UNDERGROUND SANITARY AND STORM DRAINAGE USE: PVC POLYVINYL CHLORIDE) SEWER PIPE AND FITTING: ASTM D 3034, SDR-35, FOR SOLVENT CEMENT OR ELASTOMERIC GASKET JOINTS. A. SOLVENT CEMENT: ASTM D 2564 B. GASKETS: ASTM F 477, ELASTOMERIC SEAL.

PROVIDE ALL PIPE OPENINGS THROUGH SLABS WITH SLEEVES HAVING AN INTERNAL DIAMETER AT LEAST 1" LARGER THAN THE OUTSIDE DIAMETER OF UN-INSULATED PIPES OR OF THE INSULATION FOR INSULATION SERVICES. FLOOR SLEEVES ARE TO PROJECT 2" ABOVE FINISHED FLOORS.

SLEEVES SHALL BE SCHEDULES 40 GALVANIZED STEEL PIPE

BOTTOM OF THE WATER SERVICES LINE SHALL BE 12 INCHES ABOVE THE HIGHEST POINT OF THE SEWER LINE WHENEVER THE HORIZONTAL DISTANCE BETWEEN THEM IS LESS THAN 5 FT.

PER PLAN CONSIDERING ALL LOCAL AND FEDERAL ENVIRONMENTAL LAWS. AND 18. PROVIDE DOWNSPOUT NOZZLES (SIMILAR TO JAY R. SMITH FIG 1770) AT THE OVERFLOW RAIN WATER OUTLETS,

SUPPLY AND INSTALL 1/4 TURN SHUT OFF VALVES AT EVERY PLUMBING FIXTURE.

ALL PLUMBING FIXTURES, COLORS AND FINISHES, SELECTION BY ARCHITECT

HVAC GENERAL NOTES:

SUPPLY AND INSTALL ALL ELECTRICAL CONTROLS, SAFETY SWITCHES AND ACCESSORIES NOT INDICATED IN THE ELECTRICAL DRAWING AND NECESSARY FOR THE PROPER OPERATION OF THE EQUIPMENT IN ACCORDANCE WITH THE MECHANICAL EQUIPMENT RECOMMENDATIONS AND THE NATIONAL ELECTRIC CODE.

PERFORM ALL WIRING AND CONNECTION (POWER AND CONTROL) NOT INDICATED IN THE ELECTRICAL DRAWINGS AND NECESSARY FOR THE PROPER OPERATION OF THE MECHANICAL EQUIPMENT IN STRICT ACCORDANCE WITH THE NATIONAL ELECTRIC CODE.

TAKE EVERY PRECAUTION IN ORDER TO MINIMIZE OR ELIMINATE THE TRANSMISSION OF NOISE OR VIBRATION FROM THE EQUIPMENT, PIPING SYSTEM OR DUCT SYSTEM TO THE CONDITIONING SPACE.

EQUIPMENT, MATERIALS AND ACCESSORIES SHALL BE SIMILAR TO THE INDICATED SPECIFICATION AND/OR MANUFACTURER MODEL OR CATALOG NUMBER.

UNLESS OTHERWISE NOTED IN DRAWINGS AND/OR SPECIFICATIONS ALL EQUIPMENT AND ACCESSORIES SHALL BE FURNISHED AND INSTALLED BY THE CONTRACTOR.

CIVIL SITE GENERAL NOTES

ALL DISTANCES AND ELEVATIONS ARE EXPRESSED IN METERS UNLESS OTHERWISE SPECIFIED.

ELEVATIONS ARE REFERRED TO MEAN SEA LEVEL. COORDINATES ARE BASED ON THE LAMBERT PROJECTION FOR PUERTO RICO AND THE US VIRGIN ISLAND AND REFERENCED TO THE NORTH AMERICAN DATUM OF 1983 (NAD83 NA2011) EPOCH 2010.00 ADJUSTED IN

METERS COORDINATE WITH THE CONSTRUCTION MANAGER BEFORE CUTTING OR TRIMMING EXISTING TREES AFFECTED BY THE CONSTRUCTION.

PREPARE AND SUBMIT FOR EACH PROJECT AREA, THE CONTROL OF EROSION AND SEDIMENTATION (CES) PLAN

FOR APPROVAL BY THE PERTINENT AGENCY AND THE CONSTRUCTION MANAGER. PROVIDE AND MAINTAIN A DEWATERING SYSTEM TO KEEP SUBGRADES DRY ANDCONVEY GROUND WATER AWAY FROM EXCAVATIONS. THE DEWATERING PLAN SHALL BE SUBMITTED TO THE CONSTRUCTION MANAGER

FOR APPROVAL AND COORDINATION DEWATERING PLANS SHALL INCLUDE CONTROL OF EROSION AND SEDIMENTATION FOR EACH PROJECT

PHASE AND/OR WORK AREA. THE WATER FROM THE DEWATERING SYSTEM SHALL BE FREE OF SEDIMENT AND/OR DEBRIS BEFORE ANY DISPOSAL MAINTAIN THE DEWATERING SYSTEM UNTIL DEWATERING IS NO LONGER REQUIRED.

ELECTRICAL, COMMUNICATION, SANITARY AND POTABLE WATER SERVICE SHALL NOT BE INTERRUPTED DURING CONSTRUCTION. IF NECESSARY, A PROVISIONAL TEMPORARY SERVICE AND/OR BY-PASS SHALL BE INSTALLED TO MAINTAIN SERVICE. PROVISIONAL TEMPORARY SERVICE AND/OR BY-PASS SHALL BE SUBMITTED TO THE CONSTRUCTION MANAGER FOR APPROVAL AND COORDINATION PRIOR TO CONSTRUCTION.

PREPARE AND SUBMIT THE MAINTENANCE OF SERVICE PLAN FOR ELECTRICAL, SANITARY AND POTABLE WATER FOR APPROVAL OF THE CONSTRUCTION MANAGER. NOTIFY THE CONSTRUCTION MANAGER IF ANY ELEMENT SUSPECTED OF CONTAINING HAZARDOUS MATERIAL IS

ENCOUNTERED, PRIOR TO ANY RELATED WORK ACTIVITY. VISIT THE PROJECT AREA TO VERIFY THE SPACE LIMITATIONS FOR CONSTRUCTION PROCESS AND EQUIPMENT. THE CONTRACT PRICE SHALL CONSIDER THE REQUIRED CONSTRUCTION PROCESS AND/OR EQUIPMENTS. PRIOR TO COMMENCEMENT OF THE WORK, ALL DIMENSIONS AND EXISTING CONDITIONS AT PROJECT SITE

SHALL BE VERIFIED AND ANY DISCREPANCIES BETWEEN EXISTING CONDITIONS AND CONTRACT DOCUMENTS THAT COULD AFFECT CONSTRUCTION WORK SCHEDULE AND /OR PERFORMANCE SHALL BE NOTIFIED TO CONSTRUCTION MANAGER. ALL DETAILS, SECTIONS AND NOTES SHOWN ON DRAWINGS ARE INTENDED TO BE TYPICAL AND SHALL APPLY TO

RECEPTACLES AND LIGHTING CIRCUITS SHALL BE #12 THHN WIRE AND SHALL BE SIMILAR SITUATIONS ELSEWHERE UNLESS OTHERWISE NOTED. REPAIR OR REPLACE EXISTING FACILITIES DAMAGED DURING CONSTRUCTION PRIOR TO SUBSTANTIAL

COMPLETION.

MAINTAIN IN OPERATION EXISTING FACILITIES UNTIL NEW FACILITIES ARE IN OPERATION.

GENERAL STRUCTURAL NOTES

STRUCTURAL BUILDING AND DESIGN CODES:

PUERTO RICO BUILDING CODE 2018 AND ITS BINDING REFERENCED STANDARDS, INCLUDING BUT NOT LIMITED TO:

THE INTERNATIONAL BUILDING CODE 2018 AMERICAN INSTITUTE FOR STEEL CONSTRUCTION (AISC), STEEL CONSTRUCTION MANUAL, 15 [™] EDITION

AMERICAN CONCRETE INSTITUTE (ACI), BUILDING CODE REQUIREMENTS FOR STRUCTURAL CONCRETE, ACI 318-14. AMERICAN SOCIETY OF CIVIL ENGINEERS, MINIMUM DESIGN LOADS AND ASSOCIATED CRITERIA FOR BUILDINGS AND OTHER STRUCTURES, ASCE/SEI 7-16

STRUCTURAL NOTES ON CONCRETE REPAIR

FOR CLARIFICATION

ALL CONCRETE REPAIR WORKS SHALL BE PERFORMED FOLLOWING THE GUIDELINES OF THE INTERNATIONAL CONCRETE REPAIR INSTITUTE (ICRI). HIRING A PROFESSIONAL EXPERIENCED IN THIS TYPE OF REPAIR IS RECOMMENDED TO ENSURE A

FOR THE REPAIR OF AREAS AFFECTED BY CORROSION, ICRI NO. 03730 GUIDELINE FOR SURFACE PREPARATION FOR THE REPAIR OF DETERIORATED CONCRETE RESULTING FROM REINFORCING STEEL CORROSION SHOULD BE FOLLOWED. BEFORE COMMENCING ANY CONCRETE REPAIR WORK, THE REPAIR DETAILS PRESENTED IN THE DRAWINGS SHALL BE REVIEWED. IN CASE OF DOUBT WITH THE REPAIR DETAILS PRESENTED, CONTACT THE ARCHITECT OR ENGINEER OF RECORD

IT IS IMPORTANT TO FOLLOW THE MANUFACTURER'S RECOMMENDATIONS FOR EACH PRODUCT UTILIZED FOR THIS JOB, IN ORDER TO GUARANTEE THAT THE REPAIR WORKS ARE CARRIED OUT ADEQUATELY.

STRUCTURAL NOTES ON CAST-IN-PLACE CONCRETE:

PORTLAND CEMENT SHALL BE TYPE II.

ALL CONCRETE SHALL BE OF REGULAR WEIGHT (145 POUNDS PER CUBIC FOOT) THE FOLLOWING CONCRETE MIX PARAMETERS SHALL BE USED UNLESS OTHERWISE NOTED:

CONCRETE STRENGTH AT 28 DAYS - 3,000 PSI MAX. WATER/CEMENT RATIO - 0.65 RECOMMENDED SLUMP – 4 INCHES MAX. AGGREGATE SIZE (ASTM C33) - 1 INCH

PROVIDE CONCRETE MIXES DESIGNED BY A QUALIFIED TESTING LABORATORY FOR REVIEW AND APPROVAL BY THE STRUCTURAL ENGINEER. CONCRETE MIX DESIGN SHALL BE SIGNED AND SEALED BY A PROFESSIONAL ENGINEER AUTHORIZED TO EXERCISE THE PROFESSION IN THE COMMOM WEALTH OF PUERTO RICO.

NOTE ON REINFORCING STEEL BARS:

ALL REINFORCING STEEL SHALL BE NEW STOCK DEFORMED BARS CONFORMING TO ASTM A615, GRADE 60 (FY = 60 KSI).

MAINTAIN THE FOLLOWING CONCRETE COVERAGE FOR REINFORCING STEEL UNLESS NOTED OTHERWISE: CONCRETE CAST AGAINST EARTH: 3 INCHES

CONCRETE IN CONTACT WITH THE GROUND: 2 INCHES

CONCRETE SLAB AND WALLS WITHOUT CONTACT WITH GROUND: 1 INCHES

CONCRETE BEAMS AND COLUMNS: 1 1/2 INCHES

STRUCTURAL STEEL

DESIGN, DETAIL AND ERECT STRUCTURAL STEEL ELEMENTS IN ACCORDANCE WITH THE FOLLOWING:

AISC SPECIFICATION FOR THE DESIGN, FABRICATION, AND ERECTION OF STRUCTURAL STEEL FOR BUILDINGS.

AISC MANUAL OF STEEL CONSTRUCTION, ALLOWABLE STRESS DESIGN.

AISC CODE OF STANDARD PRACTICE FOR STEEL BUILDINGS AND BRIDGES.

AWS STRUCTURAL WELDING CODE, D1.1.

STRUCTURAL STEEL SHALL CONFORM TO THE FOLLOWING GRADES:

W SHAPES: ASTM A992 (FY = 50 KSI, FU = 65 KSI) STEEL ANGLE, CHANNELS, PLATES: ASTM A36

BOLTS, NUTS AND WASHERS: HIGH-STRENGTH BOLTS, INCLUDING NUTS AND WASHERS: ASTM A325

STEEL PLATES FOR LANDINGS AND THREADS: 1/4" ANTI-SLIP DIAMOND TYPE STEEL PLATE A36

WELDING ELECTRODE FOR STEEL SHALL BE E70XX.

METAL DECK

PROVIDE DESIGN, FABRICATION, AND ERECTION OF METAL DECK CONFORMING TO THE STEEL DECK INSTITUTE'S "CODE OF RECOMMENDED STANDARD PRACTICE AND BASIC DESIGN SPECIFICATIONS".

FORM ROOF DECK FROM STEEL SHEETS CONFORMING TO ASTM A 611 GRADE C AND D OR A 653 OR HIGHER SPECIFICATIONS

WITH A MINIMUM YIELD STRENGTH OF 33 KSI. ATTACH SHEETS TO STEEL SUPPORT MEMBERS AS INDICATED AND IN ACCORDANCE WITH THE MANUFACTURER'S INSTRUCTIONS FOR INSTALLATION. WHEN DECK IS SCHEDULED TO BEEXPOSED, DE-SLAG, CLEAN AND TOUCH UP WELDS WITH A

LAP ROOF AND FLOOR DECK ENDS MINIMUM OF 2 INCHES. WHEN FASTENING DECK TO SUPPORT MEMBERS PROVIDE WELDING

MATERIALS INSTALLATION PROCEDURES TO PREVENT BURNING OF HOLES IN DECK. AT ENDS OF DECKS OR WHERE CHANGES OF DECK DIRECTION OCCUR, FASTEN TO SUPPORTS AT EACH FLUTE. PROVIDE

ADEQUATE CLOSURES AND FASTENERS TO SIDES AT EIGHTEEN INCHES ON CENTER. WHERE PARTIAL PANELS MAY BE REQUIRED TO COMPLETE DECK INSTALLATION AT PERIMETER OF STRUCTURE, PROVIDE

WELDS IN EACH FLUTE TO STRUCTURAL MEMBERS. INSTALL DECK IN THREE CONTINUOUS SPAN LENGTHS. AT PERIMETER OF DECK, SECURE DECK TO STRUCTURAL MEMBERS WITH SAME ATTACHMENTAND SPACING SUPPORT ATTACHMENT AS INDICATED ON PLANS.

HOT DIP GALVANIZE (G90) AFTER FABRICATION ALL METAL DECK AND TOUCH UP CONNECTIONS WITH A ZINC-RICH PRIMER.

NOTES (IF APPLICABLE):

TREE REMOVAL:

REMOVE ALL TREES INDICATED BY DRAWINGS AND SPECIFICATIONS, AS REQUIRED, IN A MANNER THAT WILL NOT DAMAGE ADJACENT TREES OR STRUCTURES, OR COMPACT THE SOIL

REMOVE, IN SECTIONS, TREES THAT ARE ADJACENT TO REMAINING TREES OR STRUCTURES, TO LIMIT DAMAGE TO ADJACENT CROWNS, TRUNKS, GROUND PLANE ELEMENTS AND STRUCTURES.

DO NOT CUT TREES UNLESS THE TREE WILL FALL OUTSIDE THE TREE AND PLANT PROTECTION AREA. NO TREE TO BE REMOVED WITHIN 50 FEET OF THE TREE AND PLANT PROTECTION AREA SHALL BE PUSHED OVER OR UP-ROOTED USING GRADING FOUIPMENT

PROTECT FROM DAMAGE ADJACENT PAVING, SOIL, TREES, SHRUBS, GROUND COVER PLANTINGS AND UNDERSTORY PLANTS TO REMAIN, DURING ALL TREE REMOVAL, AND CONSTRUCTION OPERATIONS. PROTECTION SHALL INCLUDE ROOT SYSTEM, TRUNK, LIMBS, AND CROWN FROM BREAKAGE OR SCARRING, AND SOIL FROM COMPACTION

REMOVE STUMPS AND IMMEDIATE ROOT PLATE FROM EXISTING TREES TO BE REMOVED. GRIND TRUNK BASES AND LARGE BUTTRESS ROOTS EITHER TO THE DEPTH OF THE LARGEST BUTTRESS ROOT OR AT LEAST 18 INCHES BELOW THE TOP MOST ROOT, CHOOSE WHICH EVER IS LESS. GRIND OVER THE AREA OF THREE TIMES THE DIAMETER OF THE TRUNK (DBH).

FOR TREES WHERE THE STUMP WILL FALL UNDER NEW PAVED AREAS, GRIND ROOTS TO A TOTAL DEPTH OF 18 INCHES BELOW THE EXISTING GRADE. IF THE SIDES OF THE STUMP HOLE STILL HAVE GREATER THAN APPROXIMATELY 20% WOOD VISIBLE, CONTINUE GRINDING OPERATION DEEPER AND/OR WIDER UNTIL THE RESULTING HOLE HAS LESS THAN 20% WOOD. REMOVE ALL WOOD CHIPS PRODUCED BY THE GRINDING OPERATION AND BACK FILL IN 8 INCH LAYERS WITH CONTROLLED FILL OF A QUALITY ACCEPTABLE TO THE SITE ENGINEER FOR FILL MATERIAL UNDER STRUCTURES, COMPACTED TO 95% OF THE MAXIMUM DRY DENSITY STANDARD PROCTOR. THE OWNER'S REPRESENTATIVE SHALL APPROVE EACH HOLE AT THE END OF THE GRINDING OPERATION.

IN AREAS WHERE THE TREE LOCATION IS TO BE A PLANTING BED OR LAWN, REMOVE ALL WOODCHIPS AND BACKFILL STUMP HOLES WITH PLANTING SOIL AS DEFINED IN SPECIFICATION SECTION PLANTING SOIL, IN MAXIMUM OF 12 INCH LAYERS AND COMPACT TO 80 - 85% OF THE MAXIMUM DRY DENSITY STANDARD PROCTOR.

WITHIN SIX MONTHS OF THE ESTIMATED DATE OF SUBSTANTIAL COMPLETION, PRUNE ALL DEAD OR HAZARDOUS BRANCHES LARGER THAN 2 INCH IN DIAMETER FROM ALL TREES TO REMAIN.

IMPLEMENT ALL PRUNING RECOMMENDATIONS FOUND IN THE ARBORIST REPORT.

PRUNE ANY LOW, HANGING BRANCHES AND VINES FROM EXISTING TREES AND SHRUBS THAT OVERHANG WALKS, STREETS AND DRIVES, OR PARKING AREAS AS FOLLOWS:

1. WALKS - WITHIN 8 FEET VERTICALLY OF THE PROPOSED WALK ELEVATION.

2. PARKING AREAS - WITHIN 12 FEET VERTICALLY OF THE PROPOSED PARKING SURFACE ELEVATION.

3. STREETS AND DRIVES - WITHIN 14 FEET VERTICALLY OF THE PROPOSED DRIVING SURFACE ELEVATION.

ALL PRUNING SHALL BE DONE IN ACCORDANCE WITH ANSI A300 (PART 1), ISA BMP TREE PRUNING (LATEST EDITION, AND THE "STRUCTURAL PRUNING: A GUIDE FOR THE GREEN INDUSTRY", EDWARD GILMAN, BRIAN KEMPF, NELDA MATHENY AND JIM CLARK, 2013 URBAN TREE FOUNDATION, VISALIA CA.

PERFORM OTHER PRUNING TASK AS INDICATED ON THE DRAWINGS OR REQUESTED BY THE OWNER'S REPRESENTATIVE. WHERE TREE SPECIFIC DISEASE VECTORS REQUIRE, STERILIZE ALL PRUNING TOOLS BETWEEN THE WORK IN INDIVIDUAL

GENERAL DRAWING SYMBOLS: ABBREVIATIONS:

EXISTING WALL ALUMINUM NEW CONCRETE BLOCK WALL 6" OR 8" BOTTOM CENTER TO CENTER NEW PLYCEM BOARD WAL CONCRETE MASONRY UNI CORRIDOR CORROSION **ELEVATION EQUAL**

F.F.E.

T.O.M.


T.O.S

BEHIND AS INDICATED. DETAIL REFERENCE NUMBER DETAIL REFERENCE SYMBOL SHEET WHERE DETAIL IS DRAWN

HIDDEN OUTLINE (SHOWING


CONDITION BELOW, ABOVE OR

 ELEVATION REFERENCE NUMBER SHEET WHERE ELEVATION IS DRAWN

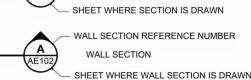

 SHEET WHERE INT. ELEV. IS DRAWN INTERIOR ELVATION SYMBOI **ELEVATION REFERENCE NUMBER**


GENERAL BUILDING SECTION

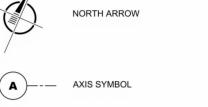

DOOR SYMBOL WINDOW SYMBOL



RISER SYMBOL ROOM IDENTIFICATION

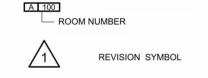

HANDICAPPED SYMBOI

THE ASBESTOS ABATEMENT SHALL INCLUDE, BUT NOT BE LIMITED TO THE

FOLLOWING (IF APPLICABLE. REFER TO GENERAL NOTES #15.):

CONSTRUCTION OF TEMPORARY CONTAINMENT

BARRIER/DECONTAMINATION ENCLOSURES

DECONTAMINATION AND CLEANING

PREPARATION FOR ABATEMENT OPERATIONS

APPLICATION OF LOCKDOWN ENCAPSULANTS

NOTIFICATION TO REGULATORY AGENCIES

WORKER HEALTH AND SAFETY PROGRAM

PREPARATION FOR ABATEMENT OPERATIONS

CONTAINMENT AND DECONTAMINATION UNIT

AND DECONTAMINATION UNIT

THE SAFETY OF ITS EMPLOYEES

NECESSARY FOR CONDUCTING THE

DECONTAMINATION AND CLEANING

FINAL JOB CLOSE-OUT

REGULATORY PERMITS, LICENSES, AND APPROVALS

REGULATORY PERMITS. LICENSES AND APPROVALS

REMOVAL OF EXISTING ASBESTOS-CONTAINING MATERIAL

TRANSPORT AND DISPOSAL OF ASBESTOS-CONTAINING MATERIAL

ABATEMENT OF LEAD-BASED PAINT AND LEAD-BASED PAINT HAZARDS GENERAL

ITEMS INCLUDE, BUT NOT LIMITED TO (IF APPLICABLE. REFER TO GENERAL

ABATEMENT OF EXISTING LEAD-BASED PAINT OWNER BUILDING

REMOVAL OF TEMPORARY CONTAINMENT BARRIER/DECONTAMINATION

ESTABLISHING ENGINEERING CONTROLS TO PREVENT MIGRATION OF LEAD

IN AIR FROM THE WORK AREA; INCLUDES CONSTRUCTION OF CONTAINMENT

PERSONAL AIR MONITORING AS REQUIRED BY REGULATORY AGENCIES FOR

TRANSPORT AND DISPOSAL OF LEAD-CONTAINING OR LEAD-CONTAMINATED

PERFORMANCE OF INCIDENTAL MECHANICAL AND ELECTRICAL WORK

REMOVAL OF ENGINEERING CONTROLS, INCLUDING TEARDOWN OF

NOTIFICATION TO REGULATORY AGENCIES

WORKER HEALTH AND SAFETY PROGRAM

AIR MONITORING

ENCLOSURES

MATERIAL

NOTES #15):

FINAL JOB CLOSE-OUT

ABOVE FINISHED FLOOR AIR CONDITIONING

FLOOR DRAIN

HARDWARE

INTERIOR

MASONRY

MINIMUM

MOUNTED

MECHANICAL

JANITOR CLOSET

NOT IN CONTRACT

NOT APPLICABLE

STAINLESS STEEL

STORM SEWER

STRUCTURAL

TOP OF STEEL

DROP MANHOLE

VERIFY IN FIELD

TELEPHONE

THICK

TYPICAL

MANHOLE

TOP OF MASONRY

UNLESS OTHERWISE NO

SMOOTH CEMENT PLASTER

ON CENTER

ROOF DRAIN

ROOM

REQUIRED

REVISION

FINISH FLOOR LEVEL

FINISH FLOOR ELEVATIONS THIS DOCUMENT REPRESENTS THE IDEAS AND **EFFORTS OF CSA ARCHITECTS AND ENGINEERS.** IT SHALL BE USED ONLY BY AUTHORIZED PERSONS

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PUERTO RICO INDUSTRIAL DEVELOPMENT COMPANY PRIDCO

ISSUE FOR BID

Issue Date

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		Q.C. A	UDITO	DR:			
		PRINC	IPAL (CAD TECHNIC	IAN:		
	I						

YO, ANNETTE ALFONSO CERTIFICO QUE SOY EL PROFESIONAL QUE [CONFECCIONÓ, DISEÑÓ O PREPARÓ] ESTOS PLANOS Y LAS ESPECIFICACIONES COMPLEMENTARIAS. TAMBIÉN, CERTIFICO QUE ENTIENDO QUE DICHOS

PROFESSIONAL'S STATEMENT:

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PRIDCO DAMAGE IMPROVEMENTS **METRO REGION STAGE 1**

BID PACKAGE M1-4

PW: 9522 / COMERIO

DESCONOCIMIENTO O POR NEGLIGENCIA YA SEA

PERSONAS CON MI CONOCIMIENTO, ME HACEN

DISCIPLINARIA POR LA OGPE.

POR MÍ, MIS AGENTES O EMPLEADOS, O POR OTRAS

RESPONSABLE DE CUALQUIER ACCIÓN JUDICIAL Y


DATE ISSUE DESCRIPTION

GENERAL NOTES. ABBREVIATIONS AND LEGEND

AS SHOWN

SHEET TITLE:

DELIVERY DATE: PROJECT NUMBER 21-0258-02 PRINT DATE & TIME BIM FILE NAME: 8/8/2024 10:51:59 AM DRAWING / MODEL LOCATION:

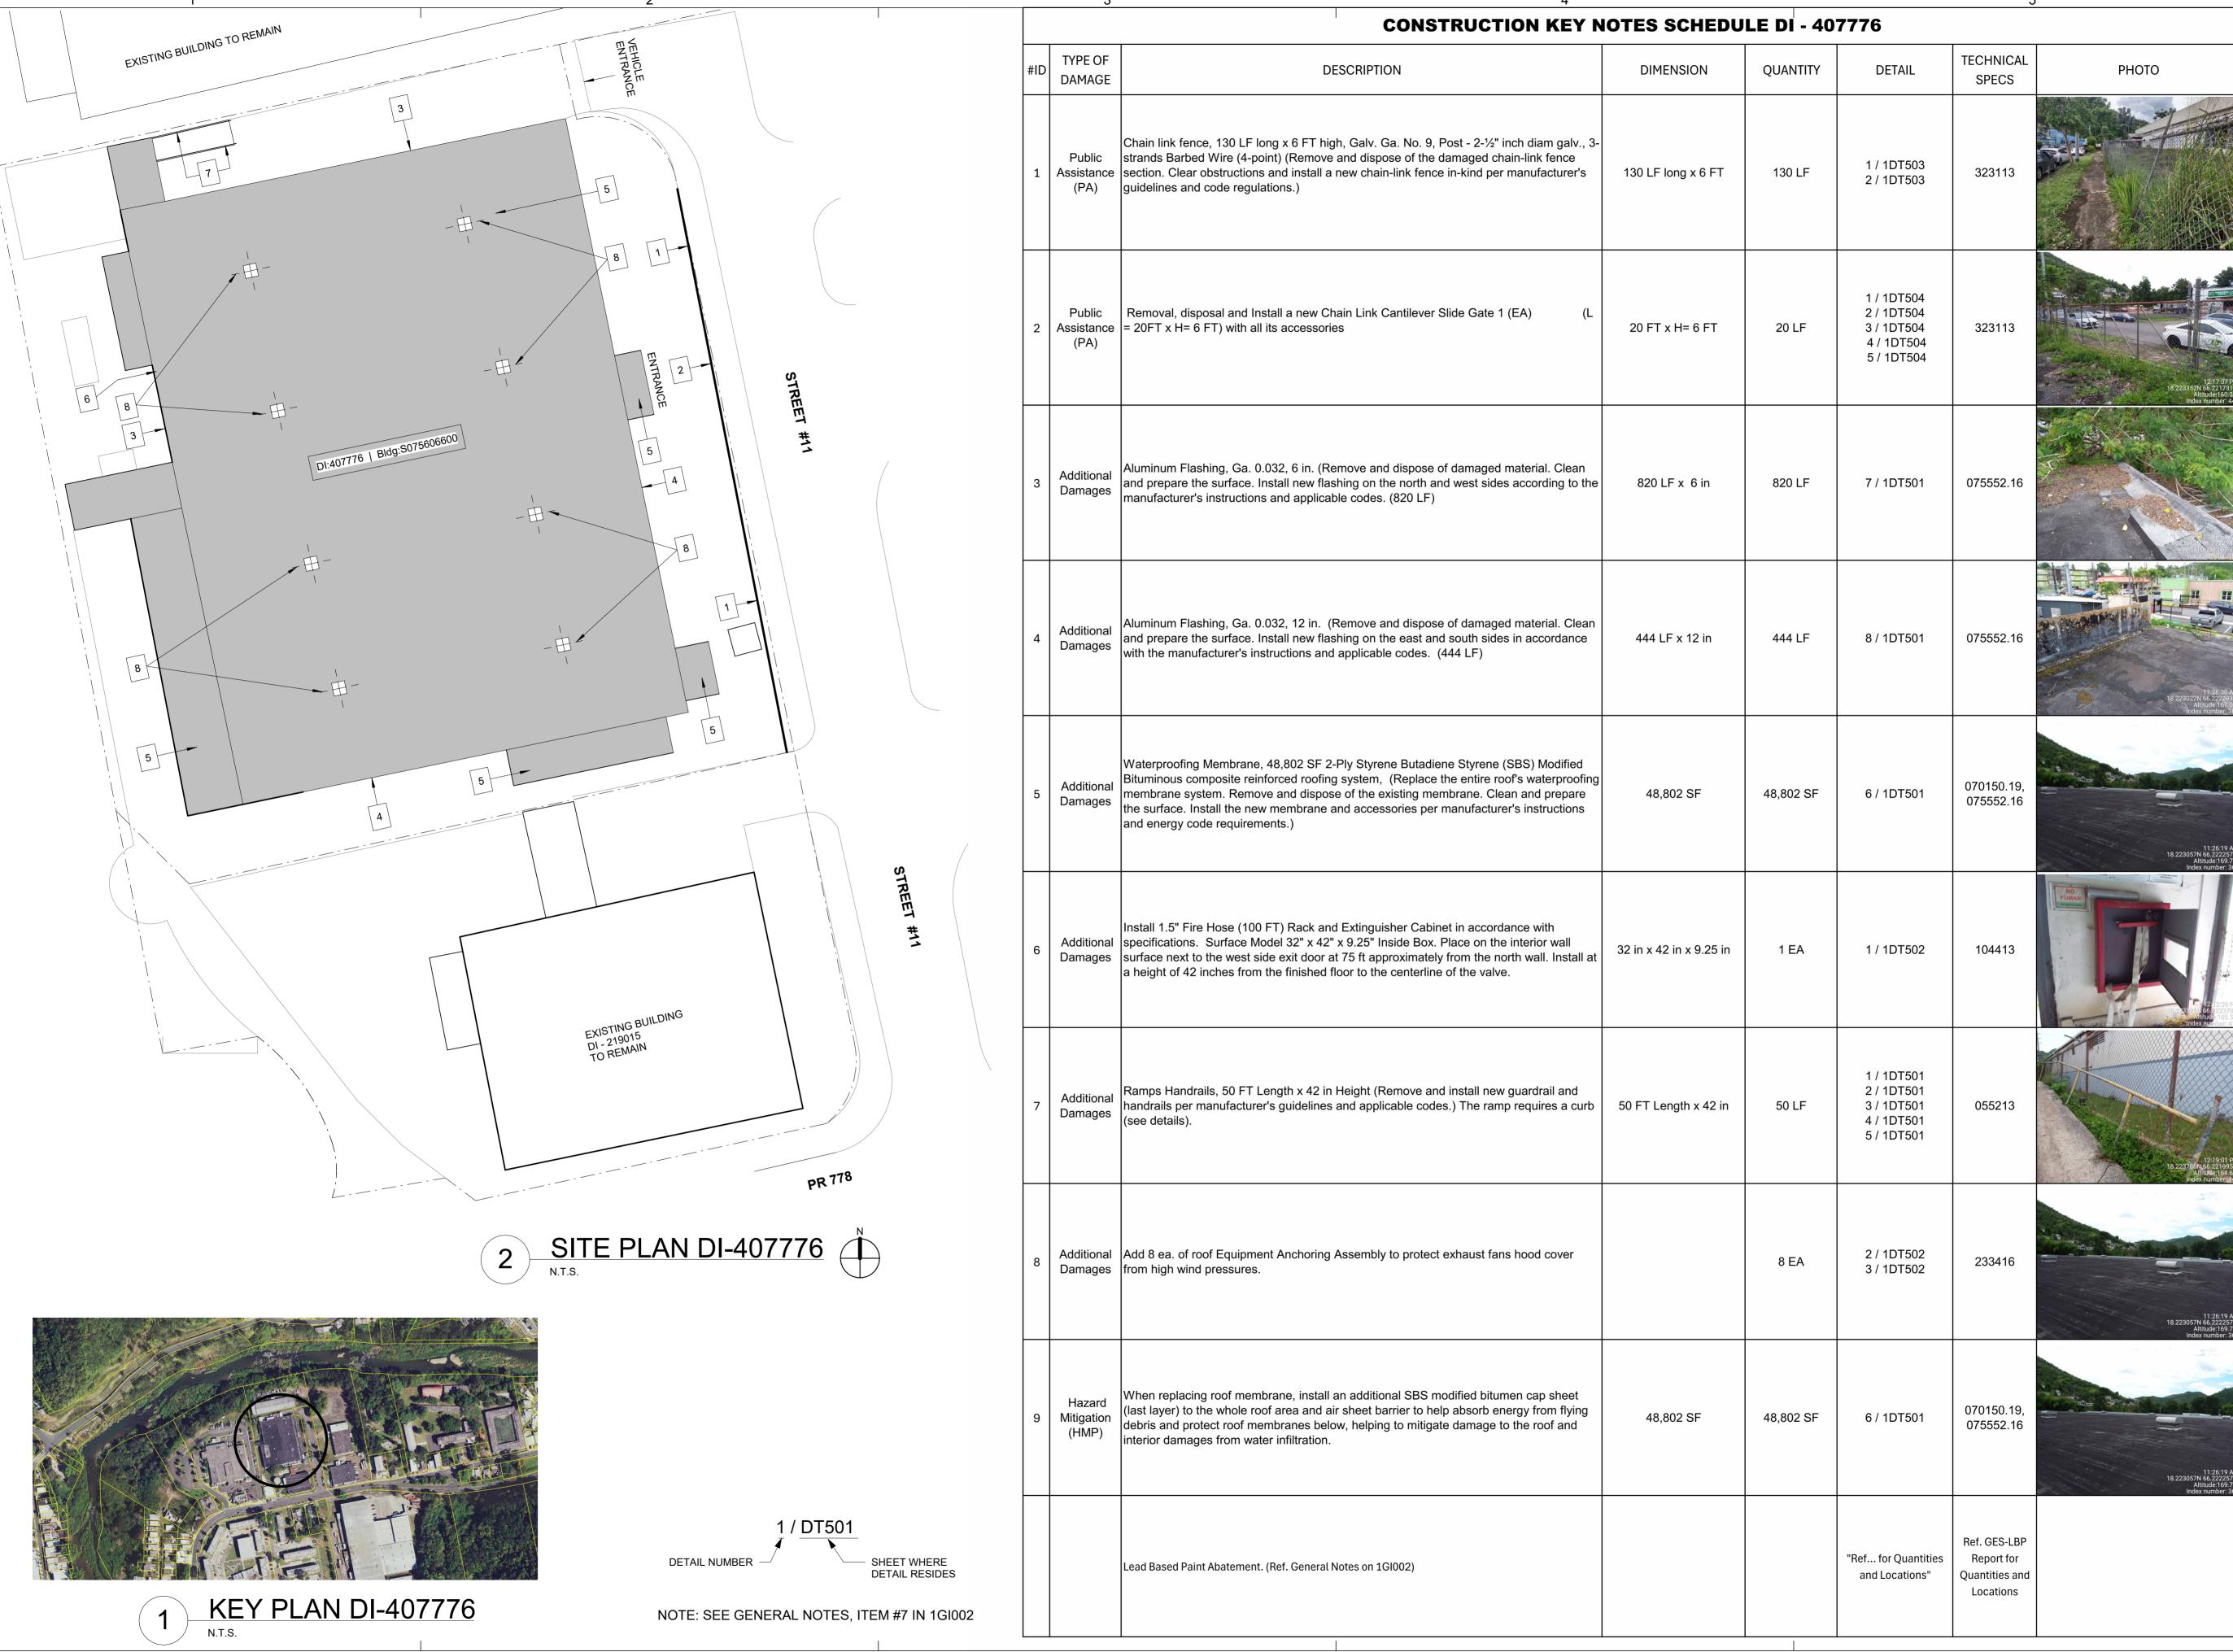



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PUERTO RICO INDUSTRIAL DEVELOPMENT COMPANY PRIDCO

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Issue Date

REV	DATE	DESCRIPTION

DISCIPLINE INFORMATION:

PROFESSIONAL OF RECORD:

ANNETTE ALFONSO

STAFF DESIGNER:

CARLOS COLON

ANNETTE ALFONSO

PRINCIPAL CAD TECHNICIAN:

PROFESSIONAL'S STATEMENT:

YO, ANNETTE ALFONSO

_____NUM. LIC. 12304

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ROJECT:

PRIDCO DAMAGE IMPROVEMENTS METRO REGION STAGE 1 BID PACKAGE M1-4 PW: 9522 / COMERIO

DATE	ISSUE DESCRIPTION
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SHEET TITLE:

SITE PLAN BUILDING # DI-407776

AS SHOWN

AS SHOWN

DELIVERY DATE:

PROJECT NUMBER:
21-0258-02

PRINT DATE & TIME:
8/8/2024 10:52:04 AM


DRAWING / MODEL LOCATION:

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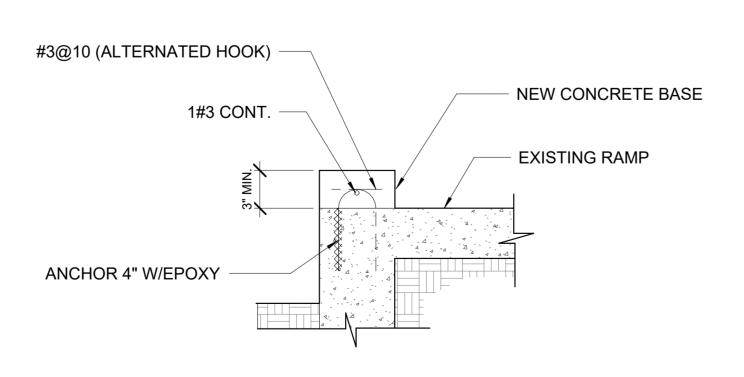
4

ONE (1) POLYESTER MAT SOLAR REFLECTIVE GRANULAR SURFACE CAP TWO (2) LAYER FIBERGLASS MAT BASE PRIME AS RECOMMENDED BY MANUFACTURER 3" MIN. POLYISO INSULATION R-VALUE 20 FOR INSTALLATION OF NEW ROOFING REPLACEMENT.


3 PLY SBS MODIFIED BITIMINOUS MEMBRANE SECTION DETAIL N.T.S.

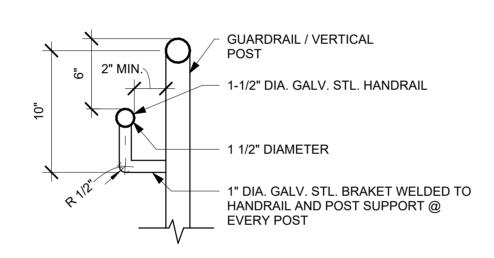


HANDRAIL BRACKET DETAIL




HANDRAIL CONCRETE BASE DETAIL

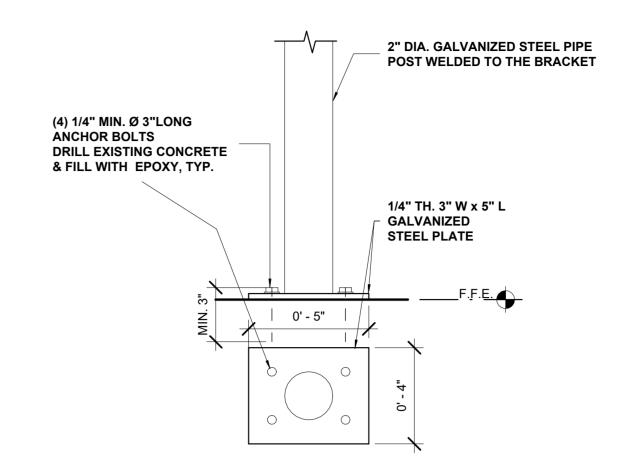

GUARDRAIL POST ANCHORAGE DETAIL

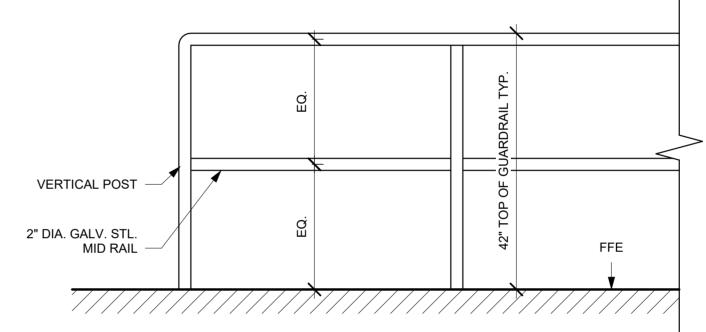

GUARDRAIL ELEVATION DETAIL

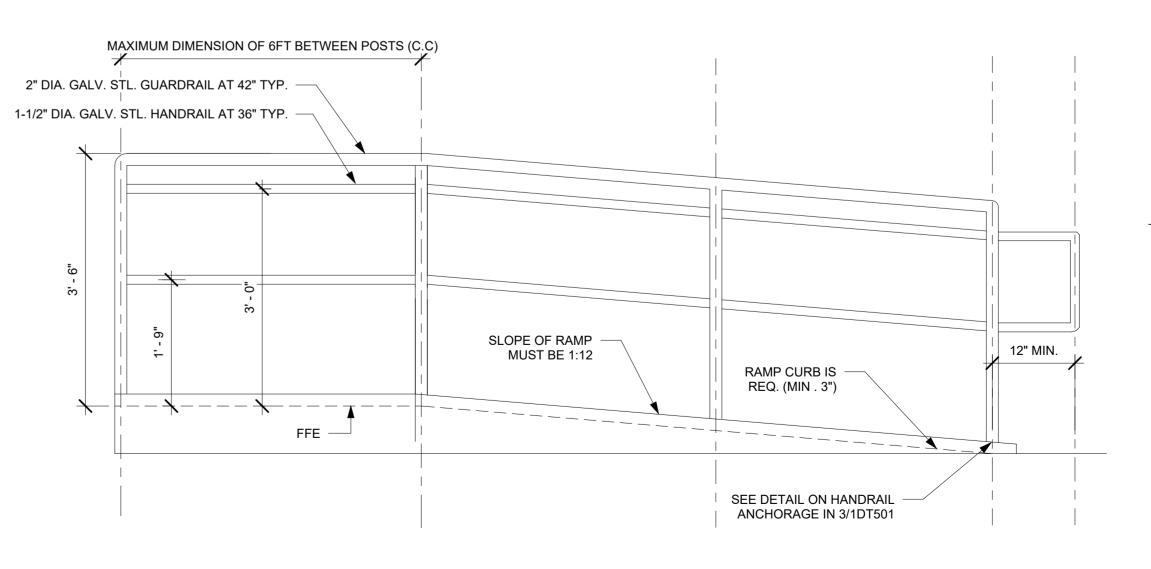

RAMP SIDE ELEVATION DETAIL



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ANNETTE ALFONSO PROFESSIONAL OF RECORD ANNETTE ALFONSO STAFF DESIGNER: CARLOS COLON

PRINCIPAL CAD TECHNICIAN:

Q.C. AUDITOR:

YO, ANNETTE ALFONSO

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PRIDCO DAMAGE IMPROVEMENTS **METRO REGION STAGE 1** BID PACKAGE M1-4 **PW: 9522 / COMERIO**

DATE ISSUE DESCRIPTION

SHEET TITLE:

SCALE:


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DETAILS AND SPECIFICATIONS

DELIVERY DATE: PROJECT NUMBER: 21-0258-02 PRINT DATE & TIME: BIM FILE NAME: 8/8/2024 10:52:04 AM

DRAWING / MODEL LOCATION:

1DT501

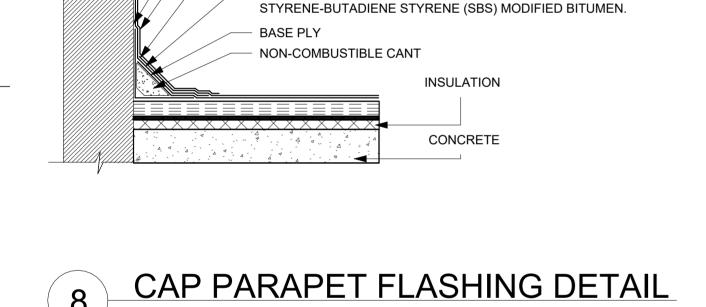

METAL COPING ALUMINUM .040"

WALL (PRIMER MASONRY SURFACES)

FOIL CLAD, MODIFIED BITUMEN FINISH PLY

AND SURFACED WITH CERAMIC GRANULES.


FIBERGLASS SCRIM/FIBERGLASS MAT COMPOSITE

IMPREGNATED AND COATED WITH HIGH QUALITY

(INSTALLED PER MANUFACTURER'S/SMACNA GUIDELINES)


LIGHTWEIGHT RANDOM FIBROUS GLASS MAT IMPREGNATED

AND COATED WITH HIGH-QUALITY SBS-MODIFIED BITUMEN,

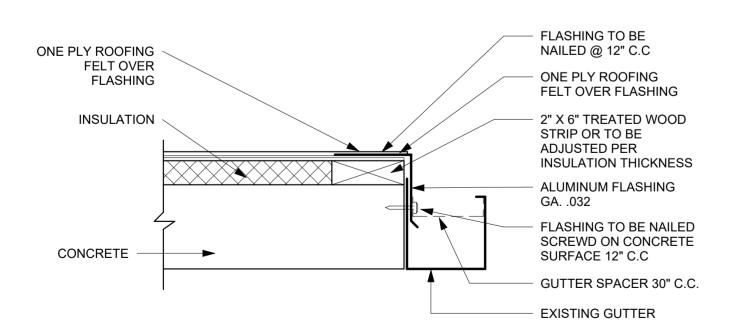


FLASHING TO BE NAILED IF WOODEN IS EMBEDED IN OVERHANG, IF NOT, FLASHING MUST BE SCREWD USING 3/16" X 1 1/4" TAPCON ANCHORS. (HEX. HEAD) IN EACH CASE SEPARATION OF NAILS OR SCREWS SHALL BE 12" C.C


ROOF EDGE FLASHING DETAIL

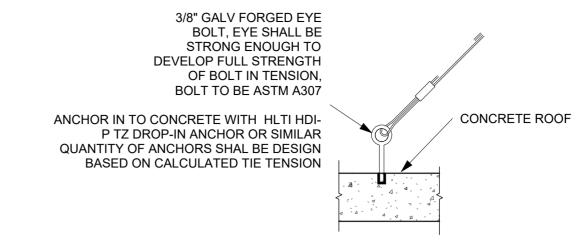

EXHAUST FAN ROOF TIE-DOWN 3 ANCHOR DETAIL - CONCRETE N.T.S.

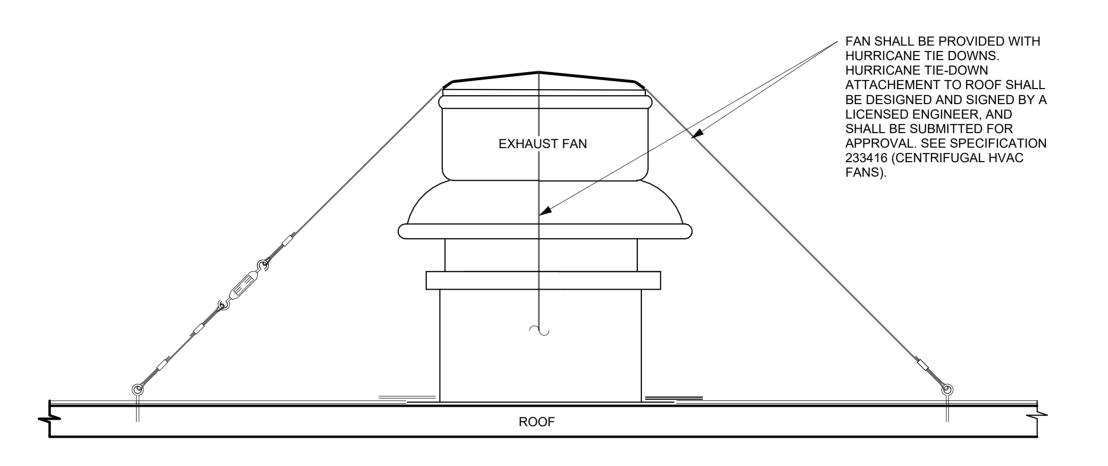

2 EXHAUST FAN ROOF TIE-DOWN N.T.S.

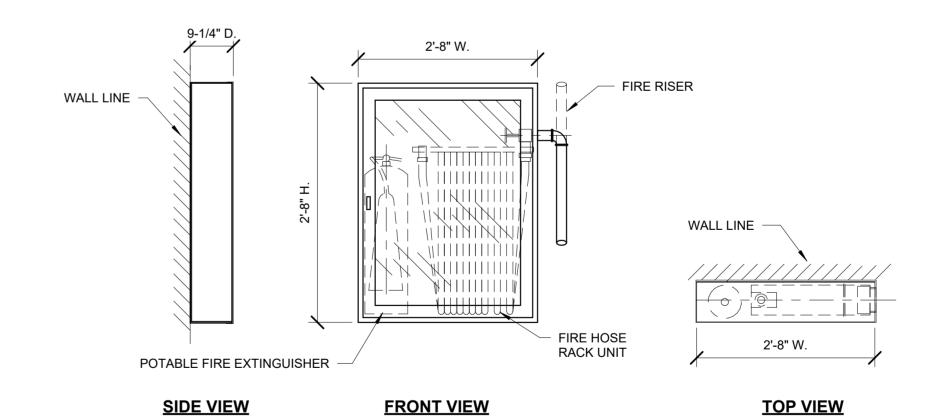

NOTE:

PROVIDE AND INSTALL WHERE INDICATED ON DRAWINGS POTTER ROEMER FIG. NO. AL-1452 SURFACE MOUNTED FIRE HOSE CABINET, WITH ALUMINUM DOOR AND FRAME WITH FULL GLASS DOOR STYLE, SUFFIX-A, CONTAINING FIG. NO. 2710-2-1/2"x2-1/2" HOSE RACK ASSEMBLY AND FIG. NO. 3010 PORTABLE FIRE EXTINGUISHER, OR APPROVED EQUAL EQUIPMENT.





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PUERTO RICO
INDUSTRIAL DEVELOPMENT COMPANY PRIDCO

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PRINCIPAL CAD TECHNICIAN:

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PRIDCO DAMAGE IMPROVEMENTS **METRO REGION STAGE 1** BID PACKAGE M1-4 **PW: 9522 / COMERIO**

DATE	ISSUE DESCRIPTION
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DETAILS AND SPECIFICATIONS

SCALE:

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DELIVERY DATE: PROJECT NUMBER: 21-0258-02 PRINT DATE & TIME: BIM FILE NAME: 8/8/2024 10:52:05 AM DRAWING / MODEL LOCATION:

1DT502

ACORN TOP

TOP RAIL


ALUM TOP
RAIL OR
POSTS TIES

RAIL OR BRACE END

BRACE ROD
AND
TURNBUCKLE

"A"

FINISHED GRADE LINE

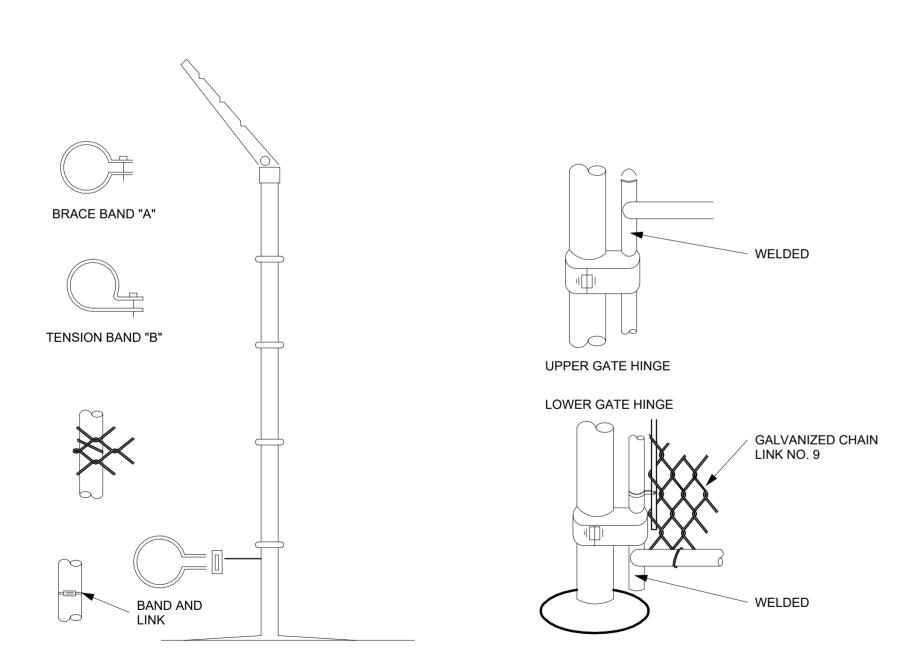


2 INSTALLATION DETAILS FOR CHAIN LINK FENCE & GATES

N.T.S.

NOTES:

- 1. CHAIN LINK FENCE INDUSTRIAL TYPE NO.423
- 2. LINE POSTS 2 1/2" O.D. GALV. STD.WEIGHT PIPE-3.85 LBS. PER LIN. FT.
- 3. TOP RAIL 1 5/8" O.D. GALV. STD.WEIGHT PIPE-2.27 LBS. PER LIN. FT. (GATE FRAME IDEM.)
- 4. CORNER POST 3"Ø O.D. GALV. STD. WEIGHT PIPE 6.79 LBS. PER LIN. FT.
- 5. TENSION WIRE GA. NO.7 GALVANIZED
- 6. GATE POST 4"O.D. GALV. STD. WEIGHT PIPE 9.10 LBS. PER LIN. FT.
- 7. GALVANIZED CHAIN LINK GA. 9-2"X2"-1.2 OUNCES GALVANIZED AFTER WOOVEN.
- 8. STD. WEIGHT PIPE, SCHEDULE 40A. 120 9. ALL FITTINGS EXTRA HEAVY DUTY 10. MILL CERTIFICATE SHALL BE SUBMITTED.
- TUBULAR STEEL PIPE SHALL BE INSTALL EVERY 50'-0" PANEL SPAN (SPAN=10'-0')
- TUBULAR STEEL PIPE SHALL BE INSTAL EVERY DIRECTIONS CHANGE IN THE FENCE.
- TUBULAR STEEL PIPE SHALL BE INSTALL AT EACH FENCE END PANEL.
- 10. ALL FITTINGS EXTRA HEAVY DUTY.
- 11. MILL CERTIFICATE SHALL BE SUBMITTED.

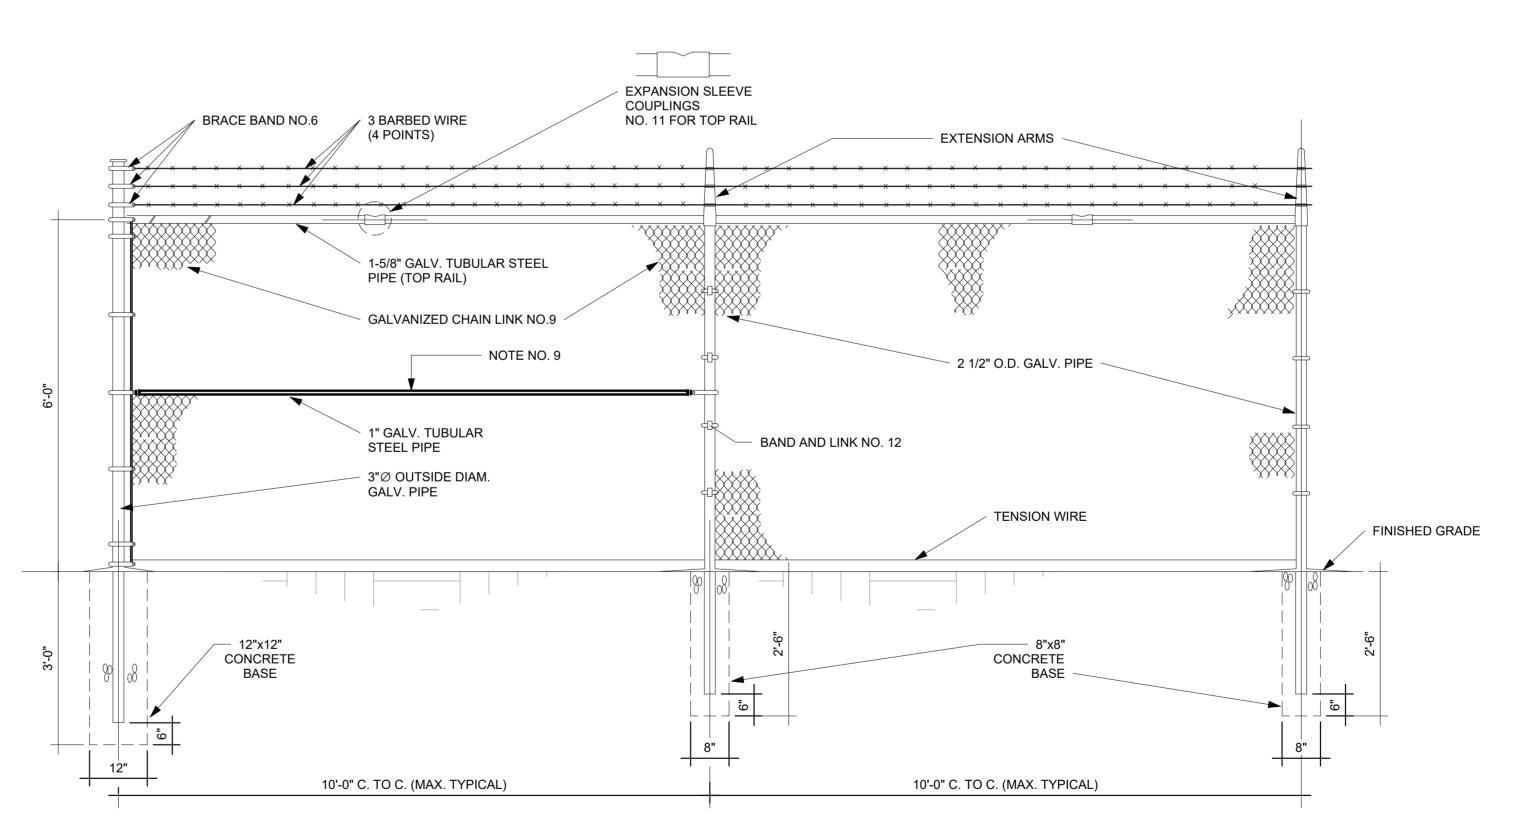

CHAIN LINK FENCE
PARTIAL ELEVATION
(ALONG PROPERTY LIMITS)

N.T.S.



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OR:

PUERTO RICO
INDUSTRIAL DEVELOPMENT COMPANY
PRIDCO

ISSUE FOR BID

Issue Date

	RE	V	DATE	DESCRIPTION
С				
0				DRMATION:
l	PRIM	E PRO	FESIONAL:	

ANNETTE ALFONSO
PROFESSIONAL OF RECORD:
ANNETTE ALFONSO
STAFF DESIGNER:

CARLOS COLON
Q.C. AUDITOR:

PRINCIPAL CAD TECHNICIAN:

PROFESSIONAL'S STATEMENT:

YO, ANNETTE ALFONSO

____ NUM. LIC. 12304

CERTIFICO QUE SOY EL PROFESIONAL QUE [CONFECCIONÓ, DISEÑÓ O PREPARÓ] ESTOS PLANOS Y LAS ESPECIFICACIONES COMPLEMENTARIAS. TAMBIÉN, CERTIFICO QUE ENTIENDO QUE DICHOS PLANOS Y ESPECIFICACIONES CUMPLEN CON LAS DISPOSICIONES APLICABLES DEL REGLAMENTO CONJUNTO Y LAS DISPOSICIONES APLICABLES DE LOS REGLAMENTOS Y CÓDIGOS DE CONSTRUCCIÓN VIGENTES DE LAS AGENCIAS, JUNTAS REGLAMENTADORAS O CORPORACIONES PÚBLICAS CON JURISDICCIÓN. CERTIFICO, ADEMÁS, QUE EN LAPREPARACIÓN DE ESTOS PLANOS Y ESPECIFICACIONES SE HA CUMPLIDO CABALMENTE CON LO DISPUESTO EN LA LEY NÚM. 14 DE 8 DE ENERO DE 2004, SEGÚN ENMENDADA, CONOCIDA COMO LA "LEY PARA LA INVERSIÓN POR LA INDUSTRIA PUERTORRIQUEÑA" Y CON LA [LEY NÚM 319 DE 15 DE MAYO DE 1938, SEGÚN ENMENDADA; LEY NÚM. 96 DE 6 DE JULIO DE 1978, SEGÚN ENMENDADA; SEGÚN APLIQUE]. RECONOZCO QUE CUALQUIER DECLARACIÓN FALSA O FALSIFICACIÓN DE LOS HECHOS QUE SE HAYA PRODUCIDO POR DESCONOCIMIENTO O POR NEGLIGENCIA YA SEA POR MÍ, MIS AGENTES O EMPLEADOS, O POR OTRAS PERSONAS CON MI CONOCIMIENTO, ME HACEN RESPONSABLE DE CUALQUIER ACCIÓN JUDICIAL Y DISCIPLINARIA POR LA OGPE.

PRIDCO DAMAGE IN

PRIDCO DAMAGE IMPROVEMENTS METRO REGION STAGE 1 BID PACKAGE M1-4 PW: 9522 / COMERIO

DATE ISSUE DESCRIPTION

DETAILS AND SPECIFICATIONS

SCALE:

SHEET TITLE:

AS SHOWN

DELIVERY DATE:


PROJECT NUMBER:
21-0258-02

PRINT DATE & TIME:
8/8/2024 10:52:06 AM

1DT50

DRAWING / MODEL LOCATION:

1DT503

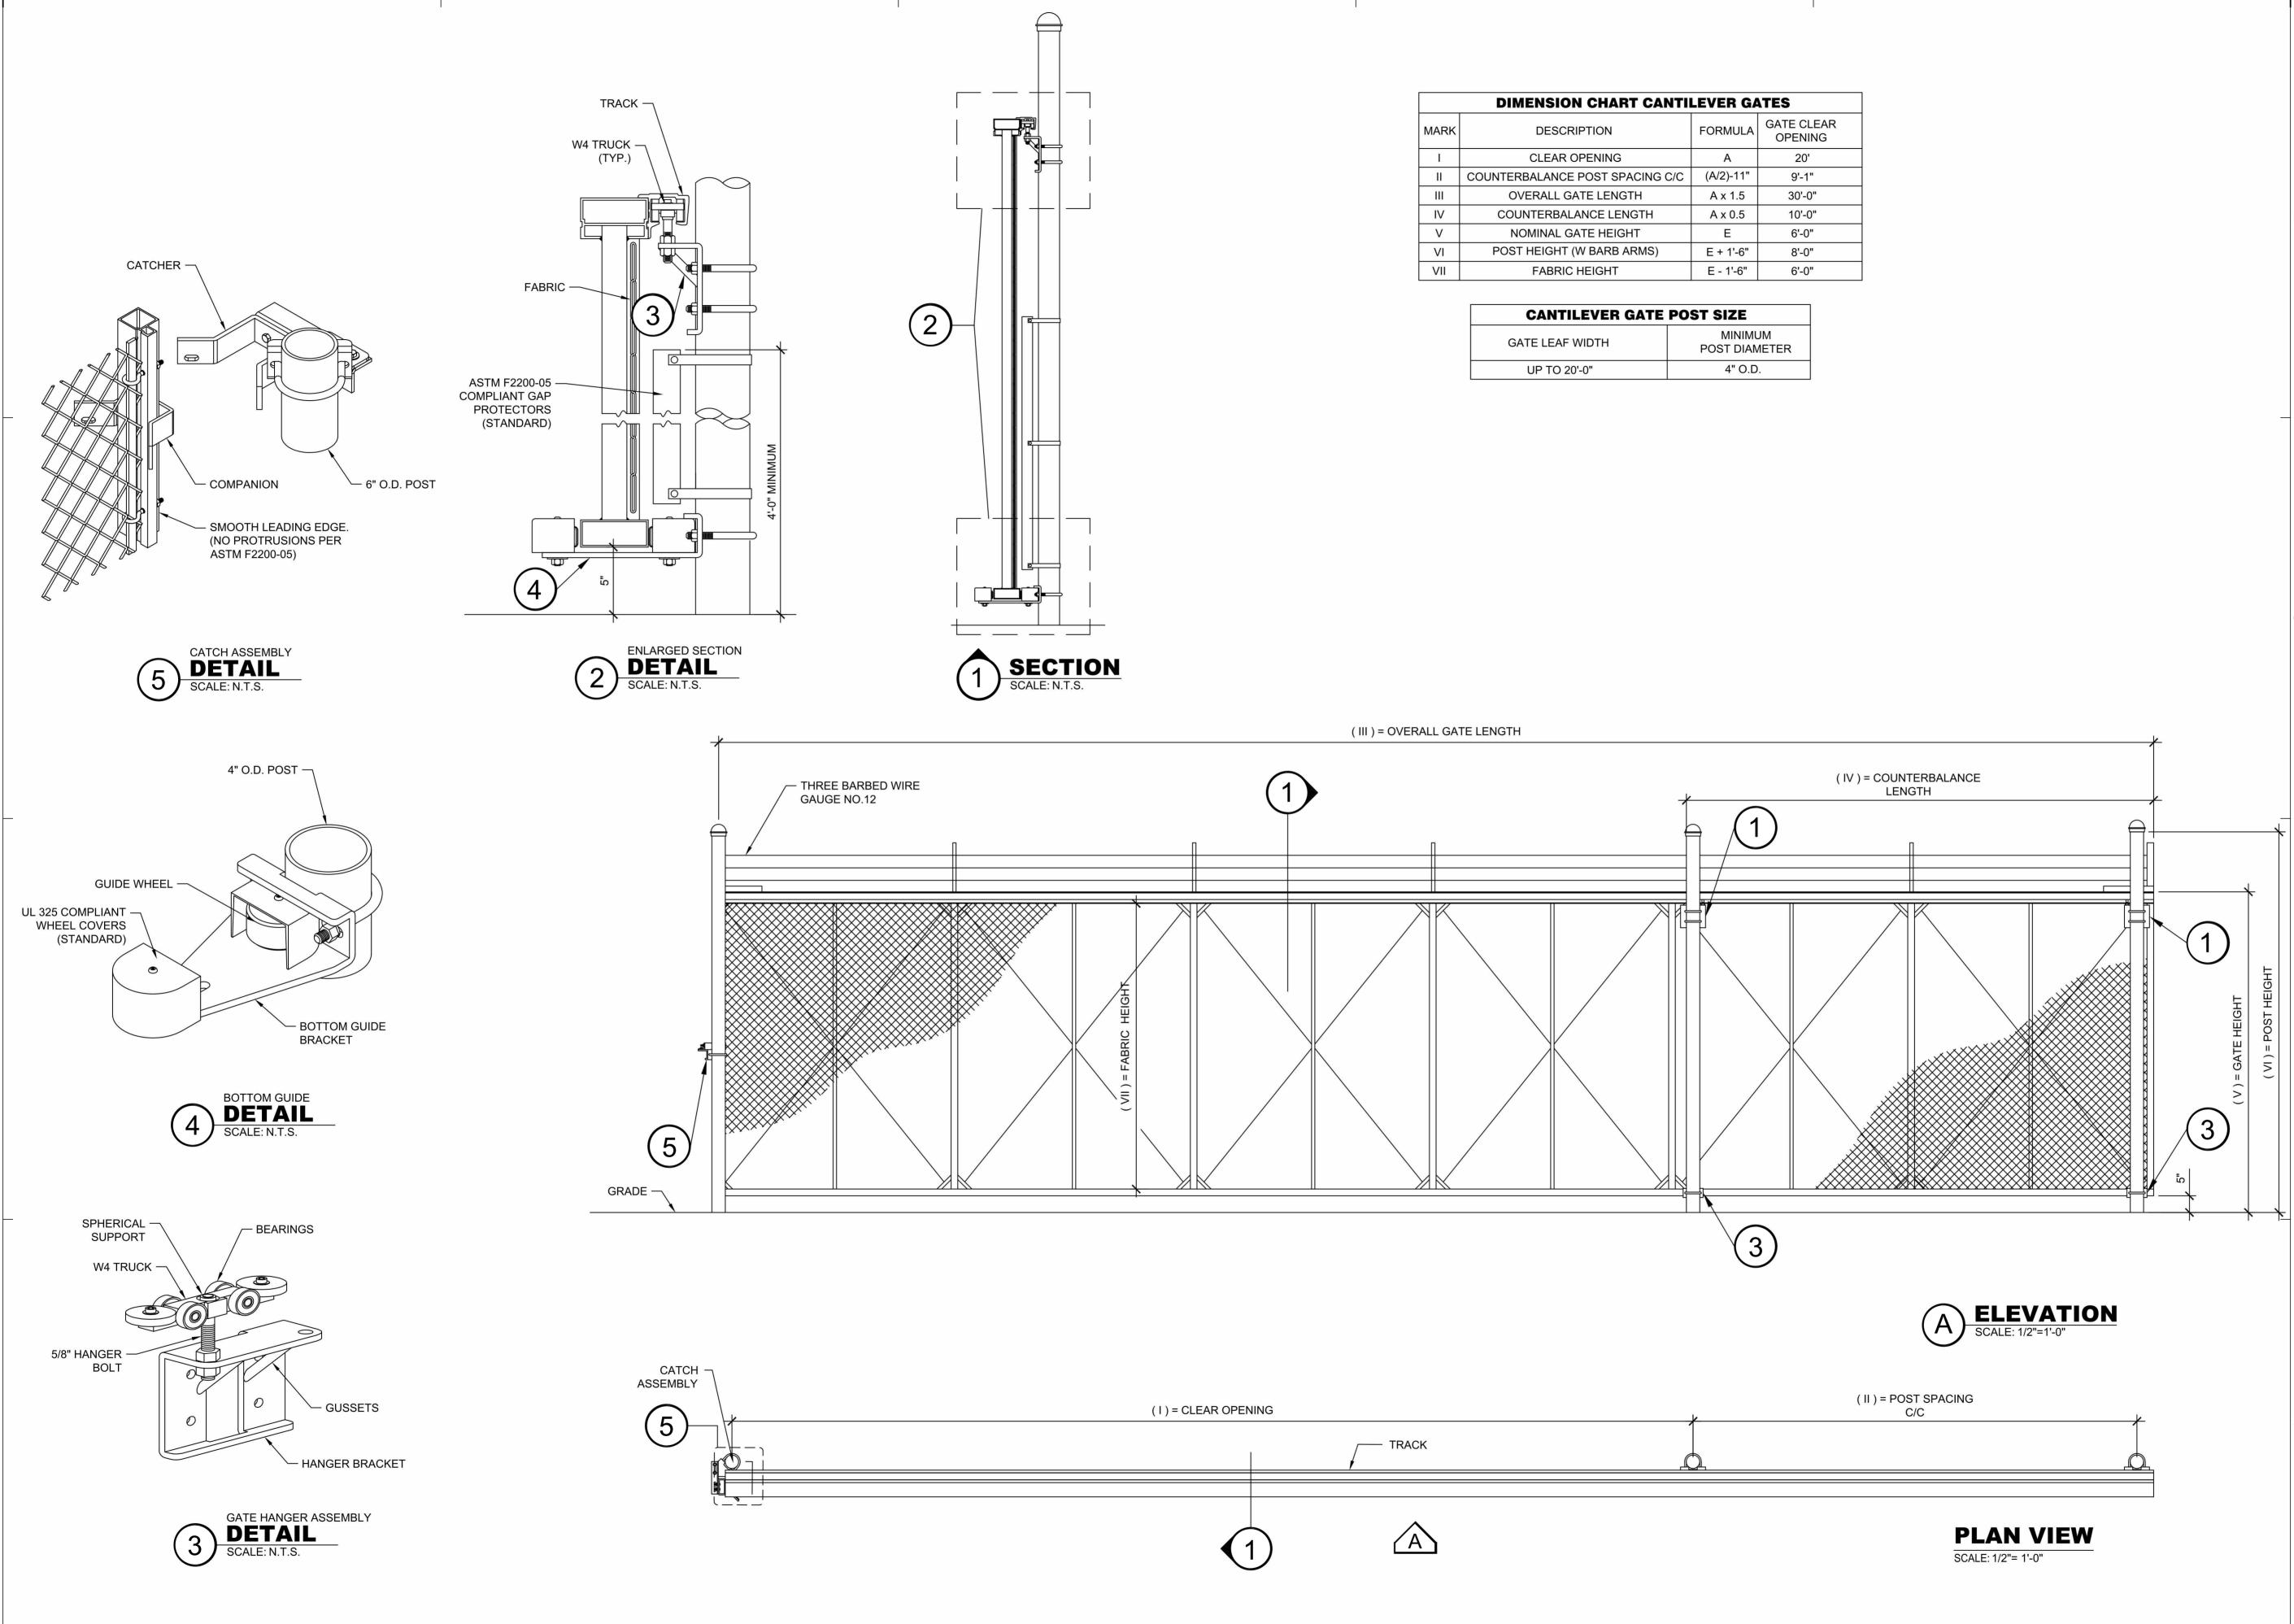



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INDUSTRIAL DEVELOPMENT COMPANY

ISSUE FOR BID

PRIDCO

Issue Date

	REV	DATE	DESCRIPTION
С			

ANNETTE ALFONSO PROFESSIONAL OF RECORD: ANNETTE ALFONSO STAFF DESIGNER: CARLOS COLON

Q.C. AUDITOR: PRINCIPAL CAD TECHNICIAN:

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PERSONAS CON MI CONOCIMIENTO, ME HACEN RESPONSABLE DE CUALQUIER ACCIÓN JUDICIAL Y

DISCIPLINARIA POR LA OGPE.

PRIDCO DAMAGE IMPROVEMENTS METRO REGION STAGE 1

BID PACKAGE M1-4 **PW: 9522 / COMERIO**

SHEET TITLE:


DETAILS AND SPECIFICATIONS


AS SHOWN


DELIVERY DATE: PROJECT NUMBER: 21-0258-02 PRINT DATE & TIME: BIM FILE NAME: 8/8/2024 10:52:08 AM


1DT504

DRAWING / MODEL LOCATION:

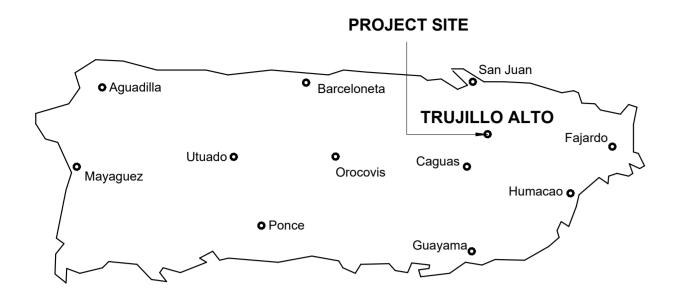

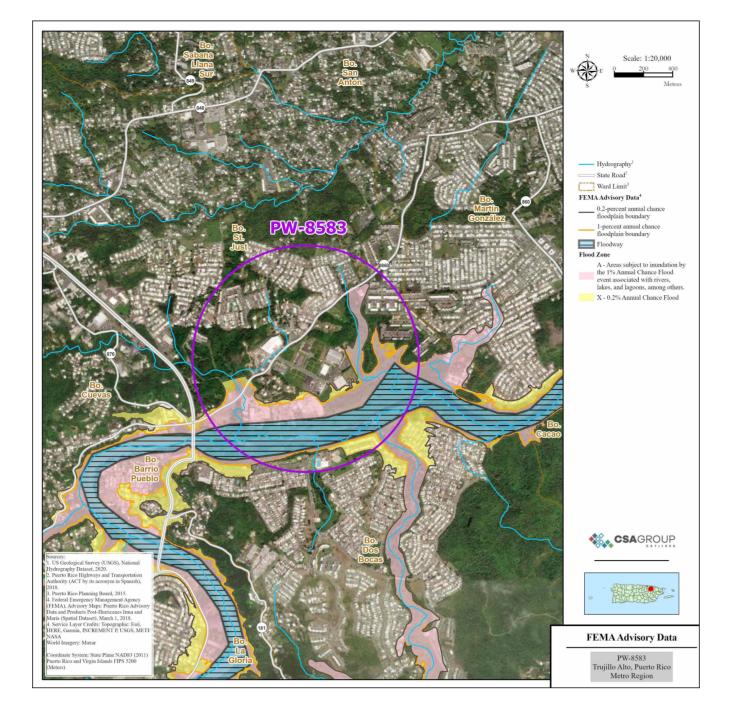

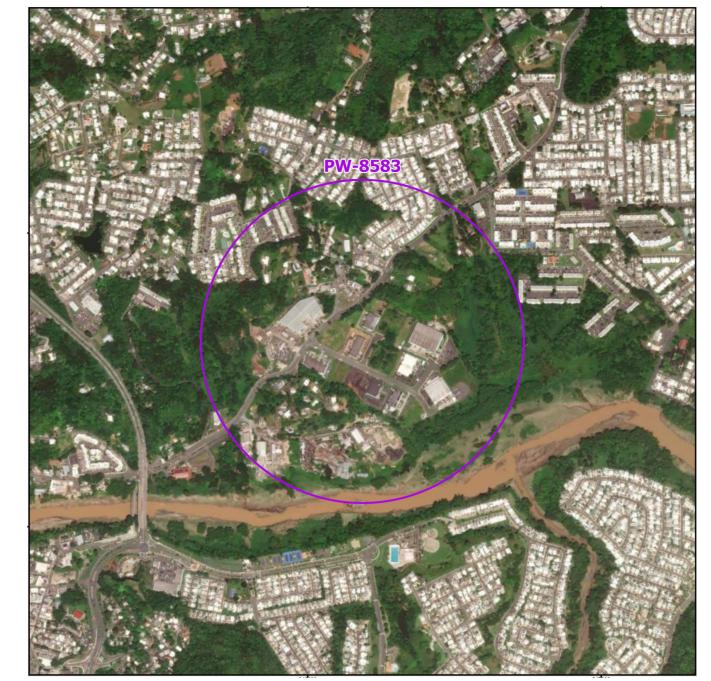

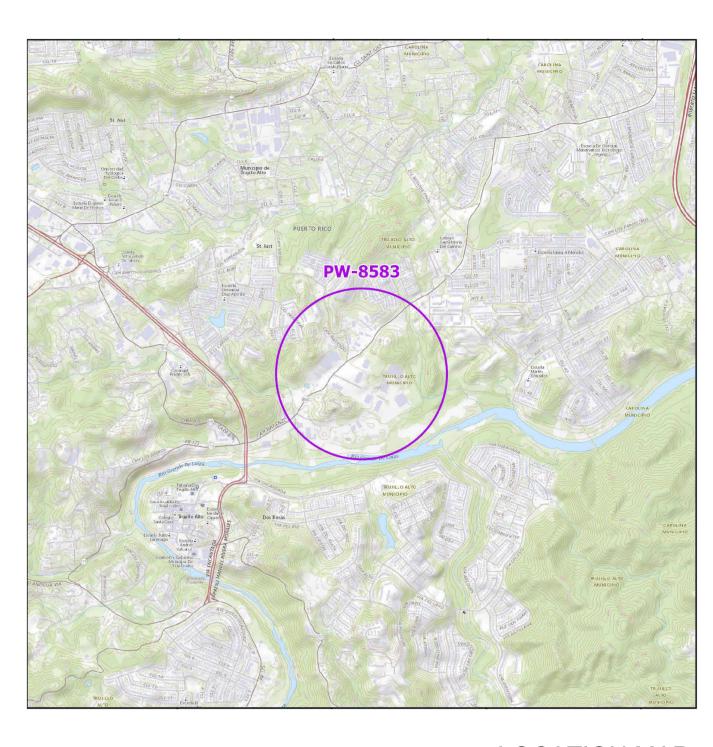

FLOOD MAP

AERIAL PHOTO

LOCATION MAP SCALE 1:20,000

INDEX OF DRAWINGS - PW 8583, DI 407866 Sheet Current Number Revision Discipline **Sheet Name** 00GENERAL 2GI001 COVER SHEET-DI-407866 **100GENERAL** 2GI002 GENERAL NOTES, ABBREVIATIONS AND LEGEND 03ARCHITECTURAL 2AE101 SITE PLAN BUILDING # DI-407866 05DETAILS 2DT501 DETAILS AND SPECIFICATIONS


INDEX OF DRAWINGS - PW 8583, DI 407868							
Discipline	Sheet Number	Current Revision	Sheet Name				
00GENERAL	3GI001		COVER SHEET-DI-407868				
00GENERAL	3GI002		GENERAL NOTES, ABBREVIATIONS AND LEGEND				
03ARCHITECTURAL	3AE101		SITE PLAN BUILDING # DI-407868				
05DETAILS	3DT501		DETAILS AND SPECIFICATIONS				

PRIDCO-FEMA 4339 DR PROGRAM METRO REGION STAGE 1 BID PACKAGE [M1-4]

REPAIR AND IMPROVEMENTS OF INDUSTRIAL BUILDINGS OF THE PUERTO RICO INDUSTRIAL DEVELOPMENT COMPANY FOR THE:


2. PW: 8583 / DI: 407866 / Bldg: #T13940861 / Mun: Carr. #860, Bo. Las Cuevas, Trujillo Alto, Puerto Rico 00976

3. PW: 8583 / DI: 407868 / Bldg: #T142908800 / Mun: Carr. #860, Bo. Las Cuevas, Trujillo Alto, Puerto Rico 00976

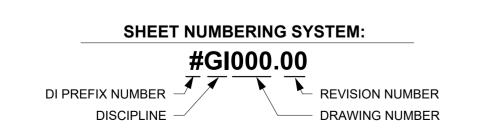







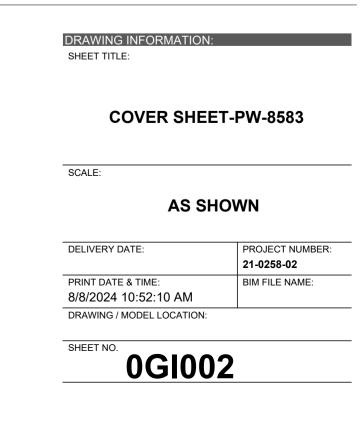

PROJECT SITE Aguadilla Barceloneta TRUJILLO ALTO Fajardo Orocovis Humacao Guayama Guayama

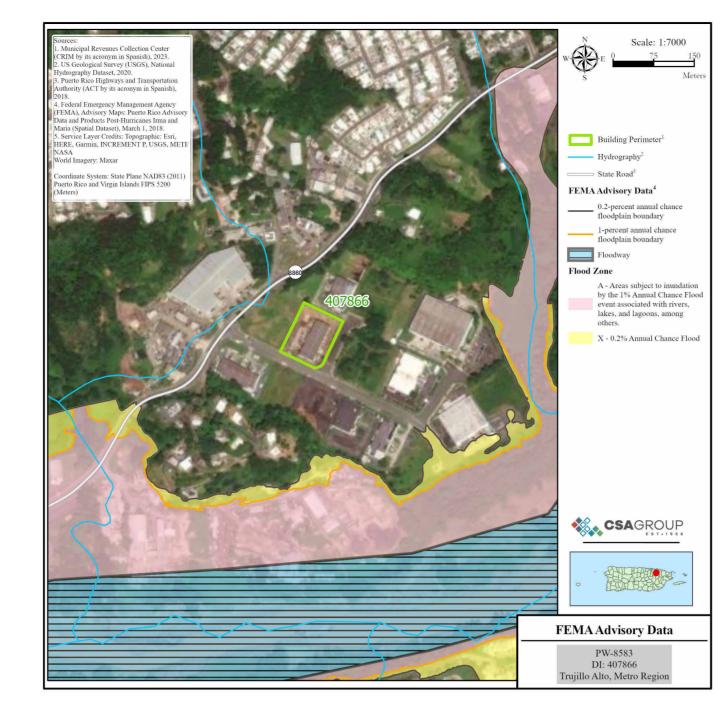



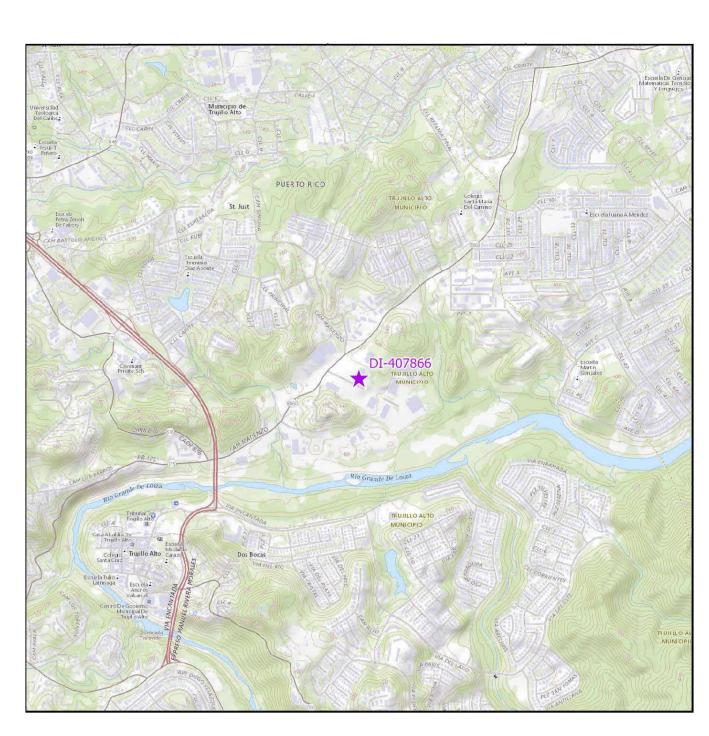

LOCATION MAP SCALE 1:20,000


FLOOD MAP

AERIAL PHOTO 18.362220, -65.996540

INDEX OF DRAWINGS - PW 8583, DI 407866 Sheet Current Number Revision Discipline **Sheet Name** 00GENERAL 2GI001 COVER SHEET-DI-407866 GENERAL NOTES, ABBREVIATIONS AND LEGEND 00GENERAL 2GI002 03ARCHITECTURAL 2AE101 SITE PLAN BUILDING # DI-407866 2DT501 05DETAILS DETAILS AND SPECIFICATIONS


PRIDCO-FEMA 4339 DR PROGRAM METRO REGION STAGE 1 BID PACKAGE [M1-4]

2. PW: 8583 / DI: 407866 / Bldg: #T13940861 / Mun: Carr. #860, Bo. Las Cuevas, Trujillo Alto, Puerto Rico 00976

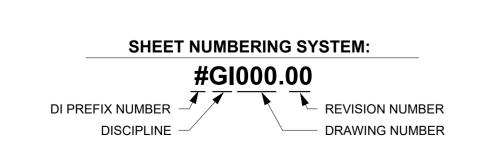





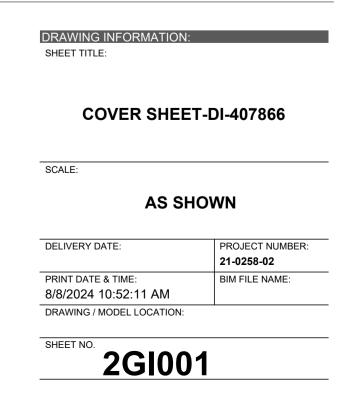

PERFORM WORK IN ACCORDANCE WITH OSHA RULES AND REGULATIONS.

COMPLY WITH THE REQUIREMENTS SET FORTH BY THE PR BUILDING CODE 2018,

PR FIRE CODE 2018, PR MECHANICAL CODE 2018, PR PLUMBING CODE 2018, PR

DE EMERGENCIA JUNE 16, 2023 AND WITH OTHER CODES, STANDARDS, AND

PERFORM WORK IN ACCORDANCE WITH ACCESSIBILITY COMPLIANCE AS PER

COMPLY WITH APPLICABLE RULES AND REGULATIONS FOR OBTAINING

NECESSARY TO PERFORM WORK AND SERVICES FOR THE PROJECT.

EXECUTE WORK IN ACCORDANCE WITH THE BEST ACCEPTED TRADE

NECESSARY AND REQUIRED INSPECTIONS, APPROVALS AND PERMITS

REGULATIONS CALLED FOR IN SAID CODES.

DISTURBANCE TO OCCUPANTS.

PER OSHA REQUIREMENTS

FACILITIES.

EXISTING BUILDING CODE 2018, ICC SUITE CODES 2018, REGLAMENTO CONJUNTO

PRACTICES, AS PER MANUFACTURER'S WRITTEN RECOMMENDATIONS, AND IN A

CAREFUL AND ORDERLY MANNER WITH THE LEAST POSSIBLE NOISE, DUST, OR

DAILY REMOVE DEBRIS RESULTING FROM DEMOLITION/CONSTRUCTION AND

DO NOT SCALE DRAWINGS. VERIFY DIMENSIONS IN THE FIELD BEFORE

PROCEDING WITH ANY PORTION OF THE WORK. ADVISE IN WRITING TO

COORDINATE CIVIL, MECHANICAL, ELECTRICAL, ARCHITECTURAL AND

SLEEVES, INSERTS, OPENINGS AND ROUGH-IN REQUIRED

CONSTRUCTION MANAGER AND ARCHITECT OF DISCREPANCY BETWEEN

TRANSPORT IT OUT OF PROJECT LIMITS. PERFORM DISPOSAL OPERATION IN

ACCORDANCE WITH GOVERNMENT APPROVALS AND REGULATIONS. SITE AND

STRUCTURE SHALL BE LEFT BROOM CLEANED FOR SUBSTANTIAL COMPLETION.

EXISTING CONDITIONS AND DRAWINGS PRIOR TO COMMENCING RELATED WORK.

REPORT TO CONSTRUCTION MANAGER AND ARCHITECT DISCREPANCIES IN THE

CONTRACT DRAWINGS, SPECIFICATIONS OR DETAILS PRIOR TO COMMENCING

STRUCTURAL REQUIREMENTS FOR PROPER LOCATION AND PROVISIONS OF

INTERFERENCE WITH ROADS, STREETS, SIDEWALKS AND OTHER ADJACENT

THE USE OF A BRAND NAME AND/OR MODEL NUMBER TO DENOTE PRODUCTS,

DO NOT COMMENCE ANY DEMOLITION OF SITE ELEMENTS OR STRUCTURE UNTIL

THE HAZARDOUS MATERIAL ABATEMENT IS DONE AND EPA CERTIFICATION IS

HAZARDOUS MATERIALS. PRIOR TO COMMENCEMENT OF THE HAZARDOUS

IF APPLICABLE CONTRACTOR SHALL BE RESPONSIBLE FOR THE REMOVAL OR ENCAPSULATION OF LEAD/ASBESTOS FOUND IN THE PROJECT SITE, AS FOUND

SPECIALIZED COMPANY THAT WILL SUBMIT A MITIGATION PLAN, PERFORM AS

IN THE SITE STUDIES. CONTRACTOR SHALL ENGAGE THE SERVICES OF A

MAY REQUIRE A DRNA PERMIT. THE CONTRACTOR IS RESPONSIBLE FOR

OBTAINED, STATING THAT THE SITE ELEMENTS AND STRUCTURES ARE FREE OF

CONDUCT DEMOLITION/CONSTRUCTION OPERATION TO INSURE MINIMUM

EQUIPMENTS, MATERIALS, OR PROCESS, IS INTENDED TO ESTABLISH A

STANDARD OF QUALITY AND SHALL NOT BE CONSTRUED AS LIMITING

MATERIAL ABATEMENT THE BUILDING AND SITE SHALL BE VACANT.

PROVIDE DOCUMENTATION ON PROCEDURES AND EXECUTION.

PRESSURE WASH, MINIMUM 3,000 PSI, EXISTING BUILDING EXTERIOR

OF MAJOR IMPERFECTIONS ON WALLS AND FINISHES IN GENERAL

CLEAN, REPAIR AND VERIFY STRUCTURAL INTEGRITY OF ROOF DECK

MEMBRANE TO VALIDATE THE WARRANTY.

NO CONDUIT SHALL BE SMALLER THAN 3/4".

ALL WIRE SHALL BE COPPER, INSULATED AS NOTED.

ELECTRICAL GENERAL NOTES

ENVELOPE

DEPARTMENT

18.

EXPANSION JOINTS.

ALL LOADS SHALL BE BALANCED.

SLAB, WALLS AND OVERHANGS.

SPACED NOT FURTHER THAN 7'-6" APART

SHALL BE COLOR CODED AS PER N.E.C.

INDUSTRIAL DEVELOPMENT COMPANY.

INSTALLATION SHALL BE "FS" TYPE.

MATERIALS AND/OR EQUIPMENT.

REGULATIONS OF THE N.E.C. AND LUMA.

WALLS, WINDOWS, AND DOORS BEFORE BEGINNING SPECIFIED WORK

REPAIR INTERIOR AND EXTERIOR WALL SURFACES WITH CEMENT PLASTER

FULL TEAR-OFF OF ROOF WATERPROOFING SYSTEM INCLUDING MEMBRANE

INSULATION AND FLASHINGS WHERE SYSTEM REPLACEMENT IS SPECIFIED. A

PRIOR THE INSTALLATION OF THE WATERPROOFING SYSTEM. COMPLY WITH

THE MANUFACTURER RECOMMENDATIONS FOR THE INSTALLATION OF ROOF

COORDINATE WITH THE OWNER REPRESENTATIVE/CONSTRUCTION MANAGER

FOR INFORMATION REGARDING ROOFING MEMBRANE WARRANTIES PRIOR TO

THE INSTALLATION OF ANY ANCHORING DEVICES, INCLUDING BUT NOT LIMITED

WARRANTY. THE CONTRACTOR MUST VERIFY AND ENSURE THE INTEGRITY OF

THE WATERPROOFING SYSTEM DURING THE INSTALLATION OF EXHAUST FAN

ALL CONDUIT SHALL BE RIGID GALVANIZED EXCEPT OTHERWISE INDICATED.

ALL UNDERGROUND CONDUITS SHALL BE PROTECTED WITH 4" CONCRETE

PROVIDE A #12 GREEN THW BONDING JUMPER BETWEEN EACH OUTLET BOX

AND RECEPTACLE GROUNDING TERMINAL, USE 3/8" LONG 10-32 GROUNDING

EXPOSED CONDUITS SHALL BE SUPPORTED BY MEANS OF ONE BOLT CLAMP

ALL NON-GALVANIZED METAL PARTS SHALL BE GIVEN ONE COAT OF RED OXIDE

ALL GALVANIZED RIGID CONDUITS FOR TOGGLE SWITCHES AND RECEPTACLES

LOCATED AT DOORWAYS AND LEAN - TO SHALL BE CONCEALED WITHIN ROOF

PROVIDE ELECTRICAL SERVICE TO TEST ALL ELECTRICAL SYSTEM IN PRESENCE

ALL LIGHTING CIRCUITS SHALL HAVE ONE (1) PORCELAIN LIGHT SOCKET WITH A

THE NEUTRAL WIRES SHALL BE IDENTIFIED THROUGHT THE INSTALLATION BY

THE USE OF WHITE COLOR COVERED LIVE WIRES WITHIN THE SAME CONDUIT

ALL OVERHANGS AND LEAN - TO'S SHALL BE PROVIDED WITH LIGHT SOCKETS.

CONTACT THE DISTRICT ENGINEER OF LUMA PRIOR TO THE BEGINNING OF THE

ALL INSTALLATIONS SHALL BE IN ACCORDANCE WITH THE LATEST RULES AND

NUMBERS AND COMPLETE SPECIFICATIONS AND DRAWINGS FOR APPROVAL OF

VERIFY LENGTH OF FEEDERS IN THE FIELD BEFORE SUBMITTING BIDS.

OVERHANGS SHALL BE PROVIDED WITH STAINLESS STEEL COVERS.

ALL SWITCHES AND RECEPTACLES THAT ARE CONCEALED IN WALLS AND

WORK AND COORDINATE WITH THEM FOR THE EXECUTION OF THE WORK

CONCERNING THE SERVICE ENTRANCE AND SUBSTATION IF REQUIRED. IN

ADDITION, A CERTIFICATE OF INSPECTION SHALL BE OBTAINED AT THE

COMPLETION OF THE WORK AND FORWARDED TO THE PUERTO RICO

ALL BOXES FOR RECEPTACLES & LIGHTING SWITCHES FOR EXPOSED

A LIST OF MATERIALS AND EQUIPMENT GIVING MANUFACTURER CATALOG

P.R.I.D.C.O. SHALL BE SUBMITTED PRIOR TO THE PURCHASING OF SAID

ALL INSTALLATIONS SHALL BE EXPOSED UNLESS OTHERWISE INDICATED.

AN EXPOSED WORK CONDULET SHALL BE USED FOR ALL 90 BENDS.

OF THE REPRESENTATIVE FROM THE MECHANICAL AND ELECTRICAL

LED TYPE BULB, EQUIVALENT TO 100W INCANDESCENT LUMENS.

SWITCHES AND RECEPTACLES SHALL BE INSTALLED 4'-0" A.F.F.

CONNECTED TO 20 AMP BREAKERS AT THE PANELBOARD.

AND TWO COATS OF METALLIC GRAY PRIOR TO INSTALLATION.

TO THE EXHAUST FAN ANCHORING SYSTEM. TO AVOID INVALIDATING THE

ANCHORS, PROPERLY SEAL ANY PENETRATIONS, AND ACCEPT

NO WIRE SHALL BE SMALLER THAN # 12 AWG THHN, 600 VOLTS.

LEAVE A #12 AWG GALVANIZED FISH WIRE IN ALL EMPTY CONDUITS.

RESPONSIBILITY FOR MAINTAINING THE MEMBRANE'S WARRANTY

ROOF MOISTURE SURVEY MAY BE REQUIRED PRIOR TO INSTALLATION OF NEW

PRIOR TO APPLYING PAINT FINISH. REPAIR WORK INCLUDES, BUT IS NOT LIMITED

TO CUT AND PATCHING, REMOVAL OF NAILS AND SCREWS FROM WALLS, REPAIR

OBTAINING PERMIT BEFORE PERFORMING THE WORK.

THE PLUMBING DRAWING IS GENERALLY DIAGRAMATTIC AND INDICATIVE OF THE WORK TO BE INSTALLED. RUN ALL PIPING CONCEALED WHEREVER POSSIBLE UNLESS OTHERWISE NOTED.

VENT, HOT, AND COLD WATER LINES, THESE SLEEVES SHALL BE AS SPECIFIED OR REQUIRED BY THE

SIZES SHOWN IN FIXTURE SCHEDULE ARE MINIMUM AND SHALL BE INCREASED AS NECESSARY TO COMPLY WITH CODE REQUIREMENTS OR AS SHOWN ON DRAWINGS.

BEFORE CONSTRUCTION VERIFY EXISTING ELEVATIONS AGAINST PROPOSED SLOPES. ANY DISCREPANCIES

SHALL BE BROUGHT TO THE ATTENTION OF THE ARCHITECT.

UNLESS OTHERWISE INDICATED, ALL DRAINAGE PIPING 3" AND SMALLER SHALL BE SLOPED 1/4" PER FT., LARGER

IMPLEMENT SAFETY CONTROLS DURING DEMOLITION/CONSTRUCTION WORK, AS 6. CLEANOUT SHALL BE OF SAME SIZE AS THE PIPES TO WHICH THEY ARE CONNECTED UP TO 4", FOR LARGE

PIPES SHALL BE SLOPED 1/8"PER FOOT.

CLEANOUT SHALL BE NOT MORE THAN 50 FEET AP-ART IN HORIZONTAL DRAINAGE LINES OF 4" NOMINAL DIAMETER OR LESS AND NOT MORE THAN 100 FEET APART FOR LARGER PIPES.

FOR FIXTURES AND EQUIPMENT NOT LISTED IN SCHEDULE, SEE CONTRACT SPECIFICATIONS.

DETERMINE EXACT LOCATION OF THE PIPING TO AVOID ANY INTERFERENCE WITH PIPING AND/OR EQUIPMENT BEING INSTALLED BY ANOTHER SUB-CONTRACTOR.

SANITARY TEES (SINGLE AND DOUBLE) AND QUARTER BENDS SHALL BE ACCEPTABLE ONLY FOR CHANGES OF DIRECTION FROM HORIZONTAL TO VERTICAL

12. USE LONG SWEEPING FITTINGS AND/OR LONG SWEEP BENDS AT BASE OF ALL STACKS.

PROVIDE ROUGHING-IN AND INSTALL ALL PLUMBING FIXTURES AND/OR EQUIPMENT WHICH ARE SUPPLIED BY

FOR ALL UNDERGROUND SANITARY AND STORM DRAINAGE USE: PVC POLYVINYL CHLORIDE) SEWER PIPE AND FITTING: ASTM D 3034, SDR-35, FOR SOLVENT CEMENT OR ELASTOMERIC GASKET JOINTS. A. SOLVENT CEMENT: ASTM D 2564 B. GASKETS: ASTM F 477, ELASTOMERIC SEAL.

PROVIDE ALL PIPE OPENINGS THROUGH SLABS WITH SLEEVES HAVING AN INTERNAL DIAMETER AT LEAST 1" LARGER THAN THE OUTSIDE DIAMETER OF UN-INSULATED PIPES OR OF THE INSULATION FOR INSULATION SPECIFIED TREE PRUNING OR CUTTING OR INCIDENTAL TO OTHER REPAIR WORK SERVICES. FLOOR SLEEVES ARE TO PROJECT 2" ABOVE FINISHED FLOORS.

SLEEVES SHALL BE SCHEDULES 40 GALVANIZED STEEL PIPE

BOTTOM OF THE WATER SERVICES LINE SHALL BE 12 INCHES ABOVE THE HIGHEST POINT OF THE SEWER LINE WHENEVER THE HORIZONTAL DISTANCE BETWEEN THEM IS LESS THAN 5 FT.

PER PLAN CONSIDERING ALL LOCAL AND FEDERAL ENVIRONMENTAL LAWS. AND 18. PROVIDE DOWNSPOUT NOZZLES (SIMILAR TO JAY R. SMITH FIG 1770) AT THE OVERFLOW RAIN WATER OUTLETS,

SUPPLY AND INSTALL 1/4 TURN SHUT OFF VALVES AT EVERY PLUMBING FIXTURE.

ALL PLUMBING FIXTURES, COLORS AND FINISHES, SELECTION BY ARCHITECT

HVAC GENERAL NOTES:

SUPPLY AND INSTALL ALL ELECTRICAL CONTROLS, SAFETY SWITCHES AND ACCESSORIES NOT INDICATED IN THE ELECTRICAL DRAWING AND NECESSARY FOR THE PROPER OPERATION OF THE EQUIPMENT IN ACCORDANCE WITH THE MECHANICAL EQUIPMENT RECOMMENDATIONS AND THE NATIONAL ELECTRIC CODE.

PERFORM ALL WIRING AND CONNECTION (POWER AND CONTROL) NOT INDICATED IN THE ELECTRICAL DRAWINGS AND NECESSARY FOR THE PROPER OPERATION OF THE MECHANICAL EQUIPMENT IN STRICT ACCORDANCE WITH THE NATIONAL ELECTRIC CODE.

TAKE EVERY PRECAUTION IN ORDER TO MINIMIZE OR ELIMINATE THE TRANSMISSION OF NOISE OR VIBRATION FROM THE EQUIPMENT, PIPING SYSTEM OR DUCT SYSTEM TO THE CONDITIONING SPACE.

EQUIPMENT, MATERIALS AND ACCESSORIES SHALL BE SIMILAR TO THE INDICATED SPECIFICATION AND/OR MANUFACTURER MODEL OR CATALOG NUMBER.

UNLESS OTHERWISE NOTED IN DRAWINGS AND/OR SPECIFICATIONS ALL EQUIPMENT AND ACCESSORIES SHALL BE FURNISHED AND INSTALLED BY THE CONTRACTOR.

CIVIL SITE GENERAL NOTES

ALL DISTANCES AND ELEVATIONS ARE EXPRESSED IN METERS UNLESS OTHERWISE SPECIFIED.

ELEVATIONS ARE REFERRED TO MEAN SEA LEVEL. COORDINATES ARE BASED ON THE LAMBERT PROJECTION FOR PUERTO RICO AND THE US VIRGIN ISLAND AND REFERENCED TO THE NORTH AMERICAN DATUM OF 1983 (NAD83 NA2011) EPOCH 2010.00 ADJUSTED IN

METERS COORDINATE WITH THE CONSTRUCTION MANAGER BEFORE CUTTING OR TRIMMING EXISTING TREES AFFECTED EXPANSION FITTINGS SHALL BE USED FOR EVERY CONDUIT CROSSING BUILDING BY THE CONSTRUCTION.

> FOR APPROVAL BY THE PERTINENT AGENCY AND THE CONSTRUCTION MANAGER. PROVIDE AND MAINTAIN A DEWATERING SYSTEM TO KEEP SUBGRADES DRY ANDCONVEY GROUND WATER AWAY FROM EXCAVATIONS. THE DEWATERING PLAN SHALL BE SUBMITTED TO THE CONSTRUCTION MANAGER

PREPARE AND SUBMIT FOR EACH PROJECT AREA, THE CONTROL OF EROSION AND SEDIMENTATION (CES) PLAN

FOR APPROVAL AND COORDINATION DEWATERING PLANS SHALL INCLUDE CONTROL OF EROSION AND SEDIMENTATION FOR EACH PROJECT

PHASE AND/OR WORK AREA. THE WATER FROM THE DEWATERING SYSTEM SHALL BE FREE OF SEDIMENT AND/OR DEBRIS BEFORE ANY DISPOSAL

MAINTAIN THE DEWATERING SYSTEM UNTIL DEWATERING IS NO LONGER REQUIRED. ELECTRICAL, COMMUNICATION, SANITARY AND POTABLE WATER SERVICE SHALL NOT BE INTERRUPTED DURING CONSTRUCTION. IF NECESSARY, A PROVISIONAL TEMPORARY SERVICE AND/OR BY-PASS SHALL BE INSTALLED TO MAINTAIN SERVICE. PROVISIONAL TEMPORARY SERVICE AND/OR BY-PASS SHALL BE SUBMITTED TO THE CONSTRUCTION MANAGER FOR APPROVAL AND COORDINATION PRIOR TO CONSTRUCTION. PREPARE AND SUBMIT THE MAINTENANCE OF SERVICE PLAN FOR ELECTRICAL, SANITARY AND POTABLE WATER

FOR APPROVAL OF THE CONSTRUCTION MANAGER. NOTIFY THE CONSTRUCTION MANAGER IF ANY ELEMENT SUSPECTED OF CONTAINING HAZARDOUS MATERIAL IS ENCOUNTERED, PRIOR TO ANY RELATED WORK ACTIVITY.

VISIT THE PROJECT AREA TO VERIFY THE SPACE LIMITATIONS FOR CONSTRUCTION PROCESS AND EQUIPMENT. THE CONTRACT PRICE SHALL CONSIDER THE REQUIRED CONSTRUCTION PROCESS AND/OR EQUIPMENTS. PRIOR TO COMMENCEMENT OF THE WORK, ALL DIMENSIONS AND EXISTING CONDITIONS AT PROJECT SITE SHALL BE VERIFIED AND ANY DISCREPANCIES BETWEEN EXISTING CONDITIONS AND CONTRACT DOCUMENTS THAT COULD AFFECT CONSTRUCTION WORK SCHEDULE AND /OR PERFORMANCE SHALL BE NOTIFIED TO

CONSTRUCTION MANAGER. RECEPTACLES AND LIGHTING CIRCUITS SHALL BE #12 THHN WIRE AND SHALL BE ALL DETAILS, SECTIONS AND NOTES SHOWN ON DRAWINGS ARE INTENDED TO BE TYPICAL AND SHALL APPLY TO SIMILAR SITUATIONS ELSEWHERE UNLESS OTHERWISE NOTED.

> REPAIR OR REPLACE EXISTING FACILITIES DAMAGED DURING CONSTRUCTION PRIOR TO SUBSTANTIAL COMPLETION.

MAINTAIN IN OPERATION EXISTING FACILITIES UNTIL NEW FACILITIES ARE IN OPERATION.

GENERAL STRUCTURAL NOTES

STRUCTURAL BUILDING AND DESIGN CODES:

PUERTO RICO BUILDING CODE 2018 AND ITS BINDING REFERENCED STANDARDS, INCLUDING BUT NOT LIMITED TO:

THE INTERNATIONAL BUILDING CODE 2018 AMERICAN INSTITUTE FOR STEEL CONSTRUCTION (AISC), STEEL CONSTRUCTION MANUAL, 15 [™] EDITION

AMERICAN CONCRETE INSTITUTE (ACI), BUILDING CODE REQUIREMENTS FOR STRUCTURAL CONCRETE, ACI 318-14. AMERICAN SOCIETY OF CIVIL ENGINEERS, MINIMUM DESIGN LOADS AND ASSOCIATED CRITERIA FOR BUILDINGS AND OTHER STRUCTURES, ASCE/SEI 7-16

STRUCTURAL NOTES ON CONCRETE REPAIR

FOR CLARIFICATION

ALL CONCRETE REPAIR WORKS SHALL BE PERFORMED FOLLOWING THE GUIDELINES OF THE INTERNATIONAL CONCRETE REPAIR INSTITUTE (ICRI). HIRING A PROFESSIONAL EXPERIENCED IN THIS TYPE OF REPAIR IS RECOMMENDED TO ENSURE A FOR THE REPAIR OF AREAS AFFECTED BY CORROSION, ICRI NO. 03730 GUIDELINE FOR SURFACE PREPARATION FOR THE REPAIR

OF DETERIORATED CONCRETE RESULTING FROM REINFORCING STEEL CORROSION SHOULD BE FOLLOWED. BEFORE COMMENCING ANY CONCRETE REPAIR WORK, THE REPAIR DETAILS PRESENTED IN THE DRAWINGS SHALL BE REVIEWED. IN CASE OF DOUBT WITH THE REPAIR DETAILS PRESENTED, CONTACT THE ARCHITECT OR ENGINEER OF RECORD

IT IS IMPORTANT TO FOLLOW THE MANUFACTURER'S RECOMMENDATIONS FOR EACH PRODUCT UTILIZED FOR THIS JOB, IN ORDER TO GUARANTEE THAT THE REPAIR WORKS ARE CARRIED OUT ADEQUATELY.

STRUCTURAL NOTES ON CAST-IN-PLACE CONCRETE:

PORTLAND CEMENT SHALL BE TYPE II. ALL CONCRETE SHALL BE OF REGULAR WEIGHT (145 POUNDS PER CUBIC FOOT)

THE FOLLOWING CONCRETE MIX PARAMETERS SHALL BE USED UNLESS OTHERWISE NOTED:

CONCRETE STRENGTH AT 28 DAYS - 3,000 PSI MAX. WATER/CEMENT RATIO - 0.65 RECOMMENDED SLUMP – 4 INCHES MAX. AGGREGATE SIZE (ASTM C33) - 1 INCH

PROVIDE CONCRETE MIXES DESIGNED BY A QUALIFIED TESTING LABORATORY FOR REVIEW AND APPROVAL BY THE STRUCTURAL ENGINEER. CONCRETE MIX DESIGN SHALL BE SIGNED AND SEALED BY A PROFESSIONAL ENGINEER AUTHORIZED. TO EXERCISE THE PROFESSION IN THE COMMOM WEALTH OF PUERTO RICO.

NOTE ON REINFORCING STEEL BARS:

ALL REINFORCING STEEL SHALL BE NEW STOCK DEFORMED BARS CONFORMING TO ASTM A615, GRADE 60 (FY = 60 KSI). MAINTAIN THE FOLLOWING CONCRETE COVERAGE FOR REINFORCING STEEL UNLESS NOTED OTHERWISE:

CONCRETE CAST AGAINST EARTH: 3 INCHES

CONCRETE IN CONTACT WITH THE GROUND: 2 INCHES CONCRETE SLAB AND WALLS WITHOUT CONTACT WITH GROUND: 1 INCHES

CONCRETE BEAMS AND COLUMNS: 1 1/2 INCHES

STRUCTURAL STEEL

DESIGN, DETAIL AND ERECT STRUCTURAL STEEL ELEMENTS IN ACCORDANCE WITH THE FOLLOWING:

AISC SPECIFICATION FOR THE DESIGN. FABRICATION, AND ERECTION OF STRUCTURAL STEEL FOR BUILDINGS.

AISC MANUAL OF STEEL CONSTRUCTION, ALLOWABLE STRESS DESIGN.

AISC CODE OF STANDARD PRACTICE FOR STEEL BUILDINGS AND BRIDGES. AWS STRUCTURAL WELDING CODE, D1.1.

STRUCTURAL STEEL SHALL CONFORM TO THE FOLLOWING GRADES:

W SHAPES: ASTM A992 (FY = 50 KSI, FU = 65 KSI) STEEL ANGLE, CHANNELS, PLATES: ASTM A36

BOLTS, NUTS AND WASHERS: HIGH-STRENGTH BOLTS, INCLUDING NUTS AND WASHERS: ASTM A325

STEEL PLATES FOR LANDINGS AND THREADS: 1/4" ANTI-SLIP DIAMOND TYPE STEEL PLATE A36

WELDING ELECTRODE FOR STEEL SHALL BE E70XX.

METAL DECK

PROVIDE DESIGN, FABRICATION, AND ERECTION OF METAL DECK CONFORMING TO THE STEEL DECK INSTITUTE'S "CODE OF RECOMMENDED STANDARD PRACTICE AND BASIC DESIGN SPECIFICATIONS".

FORM ROOF DECK FROM STEEL SHEETS CONFORMING TO ASTM A 611 GRADE C AND D OR A 653 OR HIGHER SPECIFICATIONS

WITH A MINIMUM YIELD STRENGTH OF 33 KSI. ATTACH SHEETS TO STEEL SUPPORT MEMBERS AS INDICATED AND IN ACCORDANCE WITH THE MANUFACTURER'S INSTRUCTIONS FOR INSTALLATION. WHEN DECK IS SCHEDULED TO BEEXPOSED, DE-SLAG, CLEAN AND TOUCH UP WELDS WITH A

LAP ROOF AND FLOOR DECK ENDS MINIMUM OF 2 INCHES. WHEN FASTENING DECK TO SUPPORT MEMBERS PROVIDE WELDING

MATERIALS INSTALLATION PROCEDURES TO PREVENT BURNING OF HOLES IN DECK.

AT ENDS OF DECKS OR WHERE CHANGES OF DECK DIRECTION OCCUR, FASTEN TO SUPPORTS AT EACH FLUTE. PROVIDE ADEQUATE CLOSURES AND FASTENERS TO SIDES AT EIGHTEEN INCHES ON CENTER. WHERE PARTIAL PANELS MAY BE REQUIRED TO COMPLETE DECK INSTALLATION AT PERIMETER OF STRUCTURE, PROVIDE

WELDS IN EACH FLUTE TO STRUCTURAL MEMBERS. INSTALL DECK IN THREE CONTINUOUS SPAN LENGTHS. AT PERIMETER OF DECK, SECURE DECK TO STRUCTURAL MEMBERS WITH SAME ATTACHMENTAND SPACING SUPPORT ATTACHMENT AS INDICATED ON PLANS.

HOT DIP GALVANIZE (G90) AFTER FABRICATION ALL METAL DECK AND TOUCH UP CONNECTIONS WITH A ZINC-RICH PRIMER.

NOTES (IF APPLICABLE):

TREE REMOVAL:

REMOVE ALL TREES INDICATED BY DRAWINGS AND SPECIFICATIONS, AS REQUIRED, IN A MANNER THAT WILL NOT DAMAGE ADJACENT TREES OR STRUCTURES, OR COMPACT THE SOIL

REMOVE, IN SECTIONS, TREES THAT ARE ADJACENT TO REMAINING TREES OR STRUCTURES, TO LIMIT DAMAGE TO ADJACENT CROWNS, TRUNKS, GROUND PLANE ELEMENTS AND STRUCTURES.

DO NOT CUT TREES UNLESS THE TREE WILL FALL OUTSIDE THE TREE AND PLANT PROTECTION AREA. NO TREE TO BE REMOVED WITHIN 50 FEET OF THE TREE AND PLANT PROTECTION AREA SHALL BE PUSHED OVER OR UP-ROOTED USING GRADING FOUIPMENT

PROTECT FROM DAMAGE ADJACENT PAVING, SOIL, TREES, SHRUBS, GROUND COVER PLANTINGS AND UNDERSTORY PLANTS TO REMAIN, DURING ALL TREE REMOVAL, AND CONSTRUCTION OPERATIONS. PROTECTION SHALL INCLUDE ROOT SYSTEM, TRUNK,

LIMBS, AND CROWN FROM BREAKAGE OR SCARRING, AND SOIL FROM COMPACTION REMOVE STUMPS AND IMMEDIATE ROOT PLATE FROM EXISTING TREES TO BE REMOVED. GRIND TRUNK BASES AND LARGE BUTTRESS ROOTS EITHER TO THE DEPTH OF THE LARGEST BUTTRESS ROOT OR AT LEAST 18 INCHES BELOW THE TOP MOST

ROOT, CHOOSE WHICH EVER IS LESS. GRIND OVER THE AREA OF THREE TIMES THE DIAMETER OF THE TRUNK (DBH). FOR TREES WHERE THE STUMP WILL FALL UNDER NEW PAVED AREAS, GRIND ROOTS TO A TOTAL DEPTH OF 18 INCHES BELOW THE EXISTING GRADE. IF THE SIDES OF THE STUMP HOLE STILL HAVE GREATER THAN APPROXIMATELY 20% WOOD VISIBLE, CONTINUE GRINDING OPERATION DEEPER AND/OR WIDER UNTIL THE RESULTING HOLE HAS LESS THAN 20% WOOD. REMOVE ALL WOOD CHIPS PRODUCED BY THE GRINDING OPERATION AND BACK FILL IN 8 INCH LAYERS WITH CONTROLLED FILL OF A QUALITY ACCEPTABLE TO THE SITE ENGINEER FOR FILL MATERIAL UNDER STRUCTURES, COMPACTED TO 95% OF THE MAXIMUM DRY DENSITY STANDARD PROCTOR. THE OWNER'S REPRESENTATIVE SHALL APPROVE EACH HOLE AT THE END OF THE GRINDING OPERATION.

IN AREAS WHERE THE TREE LOCATION IS TO BE A PLANTING BED OR LAWN, REMOVE ALL WOODCHIPS AND BACKFILL STUMP HOLES WITH PLANTING SOIL AS DEFINED IN SPECIFICATION SECTION PLANTING SOIL, IN MAXIMUM OF 12 INCH LAYERS AND COMPACT TO 80 - 85% OF THE MAXIMUM DRY DENSITY STANDARD PROCTOR.

WITHIN SIX MONTHS OF THE ESTIMATED DATE OF SUBSTANTIAL COMPLETION, PRUNE ALL DEAD OR HAZARDOUS BRANCHES LARGER THAN 2 INCH IN DIAMETER FROM ALL TREES TO REMAIN.

IMPLEMENT ALL PRUNING RECOMMENDATIONS FOUND IN THE ARBORIST REPORT.

PRUNE ANY LOW, HANGING BRANCHES AND VINES FROM EXISTING TREES AND SHRUBS THAT OVERHANG WALKS, STREETS AND DRIVES, OR PARKING AREAS AS FOLLOWS:

1. WALKS - WITHIN 8 FEET VERTICALLY OF THE PROPOSED WALK ELEVATION.

2. PARKING AREAS - WITHIN 12 FEET VERTICALLY OF THE PROPOSED PARKING SURFACE ELEVATION.

3. STREETS AND DRIVES - WITHIN 14 FEET VERTICALLY OF THE PROPOSED DRIVING SURFACE ELEVATION.

ALL PRUNING SHALL BE DONE IN ACCORDANCE WITH ANSI A300 (PART 1), ISA BMP TREE PRUNING (LATEST EDITION, AND THE "STRUCTURAL PRUNING: A GUIDE FOR THE GREEN INDUSTRY", EDWARD GILMAN, BRIAN KEMPF, NELDA MATHENY AND JIM CLARK, 2013 URBAN TREE FOUNDATION, VISALIA CA.

PERFORM OTHER PRUNING TASK AS INDICATED ON THE DRAWINGS OR REQUESTED BY THE OWNER'S REPRESENTATIVE. WHERE TREE SPECIFIC DISEASE VECTORS REQUIRE, STERILIZE ALL PRUNING TOOLS BETWEEN THE WORK IN INDIVIDUAL


GENERAL DRAWING SYMBOLS:


ABOVE FINISHED FLOOR EXISTING WALL NEW CONCRETE BLOCK WALL 6" OR 8" NEW PLYCEM BOARD WAL CORR'N


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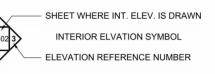
T.O.S

HIDDEN OUTLINE (SHOWING CONDITION BELOW, ABOVE OR BEHIND AS INDICATED. DETAIL REFERENCE NUMBER



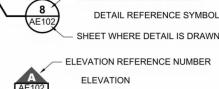

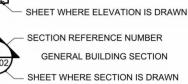

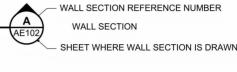



DOOR SYMBOL

WINDOW SYMBOL **KEY NOTE**

EQUIPMENT SYMBOL

HANDICAPPED SYMBOI

THE ASBESTOS ABATEMENT SHALL INCLUDE, BUT NOT BE LIMITED TO THE

FOLLOWING (IF APPLICABLE. REFER TO GENERAL NOTES #15.):

CONSTRUCTION OF TEMPORARY CONTAINMENT

BARRIER/DECONTAMINATION ENCLOSURES

DECONTAMINATION AND CLEANING

PREPARATION FOR ABATEMENT OPERATIONS

APPLICATION OF LOCKDOWN ENCAPSULANTS

NOTIFICATION TO REGULATORY AGENCIES

WORKER HEALTH AND SAFETY PROGRAM

PREPARATION FOR ABATEMENT OPERATIONS

CONTAINMENT AND DECONTAMINATION UNIT

AND DECONTAMINATION UNIT

THE SAFETY OF ITS EMPLOYEES

NECESSARY FOR CONDUCTING THE

DECONTAMINATION AND CLEANING

FINAL JOB CLOSE-OUT

REGULATORY PERMITS, LICENSES, AND APPROVALS

REGULATORY PERMITS. LICENSES AND APPROVALS

REMOVAL OF EXISTING ASBESTOS-CONTAINING MATERIAL

TRANSPORT AND DISPOSAL OF ASBESTOS-CONTAINING MATERIAL

ABATEMENT OF LEAD-BASED PAINT AND LEAD-BASED PAINT HAZARDS GENERAL

ITEMS INCLUDE, BUT NOT LIMITED TO (IF APPLICABLE. REFER TO GENERAL

ABATEMENT OF EXISTING LEAD-BASED PAINT OWNER BUILDING

REMOVAL OF TEMPORARY CONTAINMENT BARRIER/DECONTAMINATION

ESTABLISHING ENGINEERING CONTROLS TO PREVENT MIGRATION OF LEAD

IN AIR FROM THE WORK AREA; INCLUDES CONSTRUCTION OF CONTAINMENT

PERSONAL AIR MONITORING AS REQUIRED BY REGULATORY AGENCIES FOR

TRANSPORT AND DISPOSAL OF LEAD-CONTAINING OR LEAD-CONTAMINATED

PERFORMANCE OF INCIDENTAL MECHANICAL AND ELECTRICAL WORK

REMOVAL OF ENGINEERING CONTROLS, INCLUDING TEARDOWN OF

NOTIFICATION TO REGULATORY AGENCIES

WORKER HEALTH AND SAFETY PROGRAM

AIR MONITORING

ENCLOSURES

MATERIAL

NOTES #15):

FINAL JOB CLOSE-OUT

RISER SYMBOL

LEVEL SYMBOI



REVISION SYMBOL

ABBREVIATIONS:

AIR CONDITIONING ALUMINUM BOTTOM CENTER TO CENTER CONCRETE MASONRY UNI CORRIDOR CORROSION **ELEVATION EQUAL** FLOOR DRAIN FINISH FLOOR ELEVATIONS FINISH FLOOR LEVEL HARDWARE INTERIOR JANITOR CLOSET MASONRY MECHANICAL MINIMUM MOUNTED NOT IN CONTRACT NOT APPLICABLE ON CENTER ROOF DRAIN ROOM REQUIRED REVISION SMOOTH CEMENT PLASTER STAINLESS STEEL STORM SEWER STRUCTURAL T.O.M. TOP OF MASONRY TOP OF STEEL **TELEPHONE** THICK **TYPICAL**

UNLESS OTHERWISE NOTED

DROP MANHOLE

VERIFY IN FIELD

MANHOLE

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CSA ARCHITECTS AND ENGINEERS.

PUERTO RICO

PRIDCO

ISSUE FOR BID

INDUSTRIAL DEVELOPMENT COMPANY

Issue Date

	RE	V	DATE		DESCRIPTION			
С								
	DISCIPLINE INFORMATION:							
	ANNETTE ALFONSO							
	PROFESSIONAL OF RECORD:							
	ANNETTE ALFONSO							
	STAFF DESIGNER:							
	CARLOS COLON							
	Q.C. AUDITOR:							
	PRINCIPAL CAD TECHNICIAN:							

PROFESSIONAL'S STATEMENT: YO, ANNETTE ALFONSO

CERTIFICO QUE SOY EL PROFESIONAL QUE [CONFECCIONÓ, DISEÑÓ O PREPARÓ] ESTOS PLANOS Y LAS ESPECIFICACIONES COMPLEMENTARIAS. TAMBIÉN, CERTIFICO QUE ENTIENDO QUE DICHOS PLANOS Y ESPECIFICACIONES CUMPLEN CON LAS DISPOSICIONES APLICABLES DEL REGLAMENTO CONJUNTO Y LAS DISPOSICIONES APLICABLES DE LOS REGLAMENTOS Y CÓDIGOS DE CONSTRUCCIÓN VIGENTES DE LAS AGENCIAS, JUNTAS REGLAMENTADORAS O CORPORACIONES PÚBLICAS CON JURISDICCION. CERTIFICO, ADEMAS, QUE EN LAPREPARACIÓN DE ESTOS PLANOS Y ESPECIFICACIONES SE HA CUMPLIDO CABALMENTE CON LO DISPUESTO EN LA LEY NÚM. 14 DE 8 DE ENERO DE 2004, SEGÚN ENMENDADA, CONOCIDA COMO LA "LEY PARA LA INVERSIÓN POR LA INDUSTRIA PUERTORRIQUEÑA" Y CON LA [LEY NÚM. 319 DE 15 DE MAYO DE 1938, SEGÚN ENMENDADA; LEY NÚM 96 DE 6 DE JULIO DE 1978 SEGÚN ENMENDADA; SEGÚN APLIQUE]. RECONOZCO QUE CUALQUIER DECLARACIÓN FALSA O FALSIFICACIÓN DE LOS HECHOS QUE SE HAYA PRODUCIDO POR DESCONOCIMIENTO O POR NEGLIGENCIA YA SEA POR MÍ, MIS AGENTES O EMPLEADOS, O POR OTRAS

PRIDCO DAMAGE IMPROVEMENTS **METRO REGION STAGE 1** BID PACKAGE M1-4

PW: 9522 / COMERIO

PERSONAS CON MI CONOCIMIENTO, ME HACEN

DISCIPLINARIA POR LA OGPE.

RESPONSABLE DE CUALQUIER ACCIÓN JUDICIAL Y

DATE ISSUE DESCRIPTION

GENERAL NOTES. ABBREVIATIONS AND LEGEND


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DELIVERY DATE: PROJECT NUMBER 21-0258-02 PRINT DATE & TIME BIM FILE NAME: 8/8/2024 10:52:13 AM

DRAWING / MODEL LOCATION:





DETAIL NUMBER

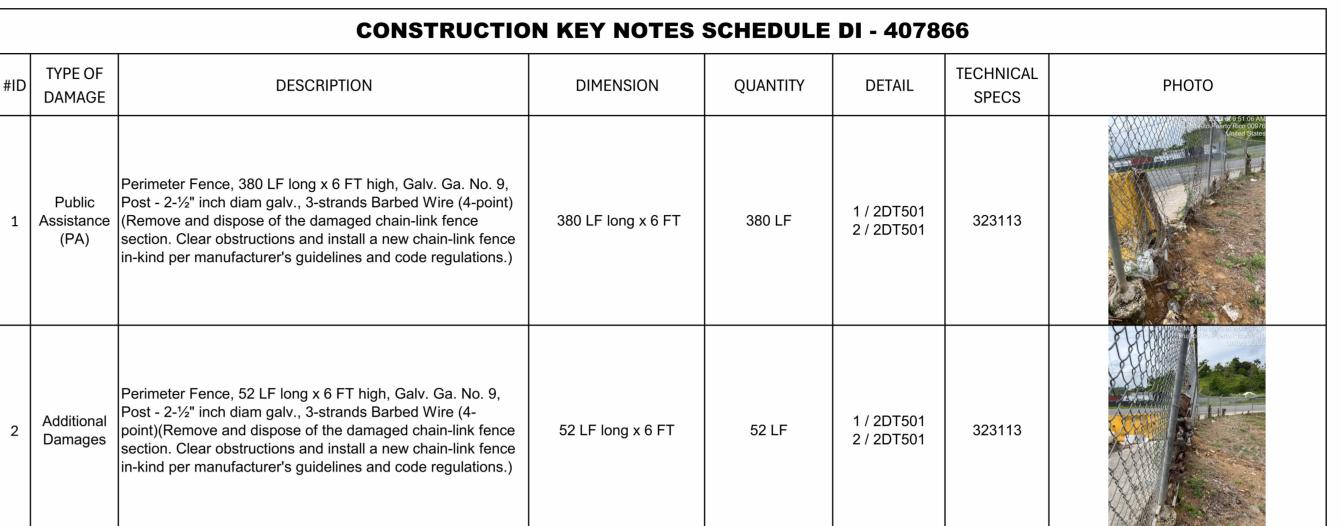

1 KEY PLAN DI 407866

N.T.S.

SHEET WHERE

DETAIL RESIDES



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PUERTO RICO INDUSTRIAL DEVELOPMENT COMPANY

ISSUE FOR BID

PRIDCO

Issue Date

	REV	DATE	DESCRIPTION
С			
		PLINE INFO	DRMATION:

PRIME PROFESIONAL:

ANNETTE ALFONSO

PROFESSIONAL OF RECORD:

ANNETTE ALFONSO

STAFF DESIGNER:

CARLOS COLON

Q.C. AUDITOR:

PRINCIPAL CAD TECHNICIAN:

YO, ANNETTE ALFONSO

PROFESSIONAL'S STATEMENT:

NUM 110 4000

_____NUM. LIC. 12304

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PROJE

PRIDCO DAMAGE IMPROVEMENTS METRO REGION STAGE 1 BID PACKAGE M1-4 PW: 9522 / COMERIO

DATE	ISSUE DESCRIPTION

SITE PLAN BUILDING # DI-407866

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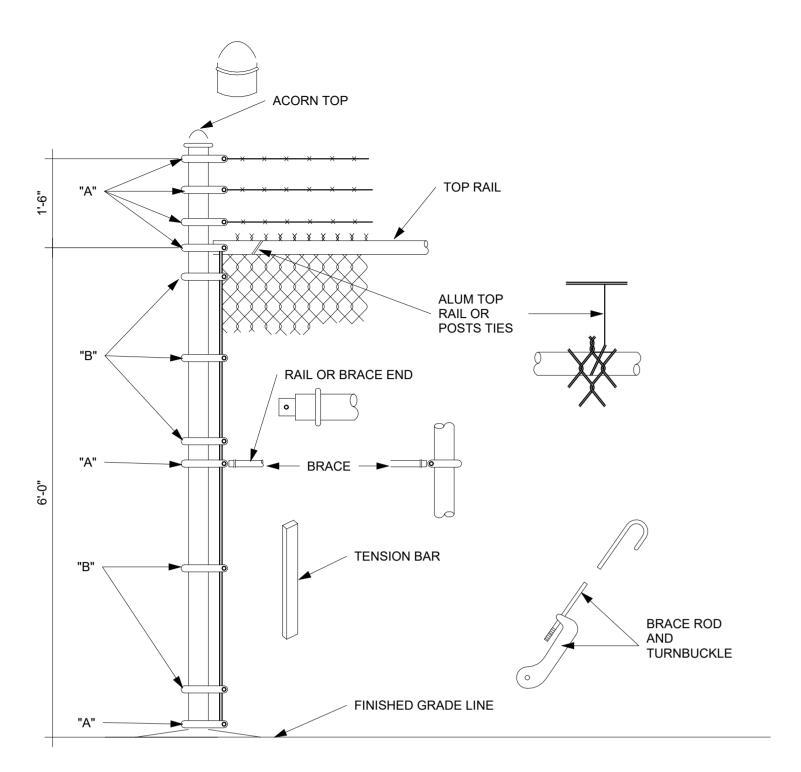
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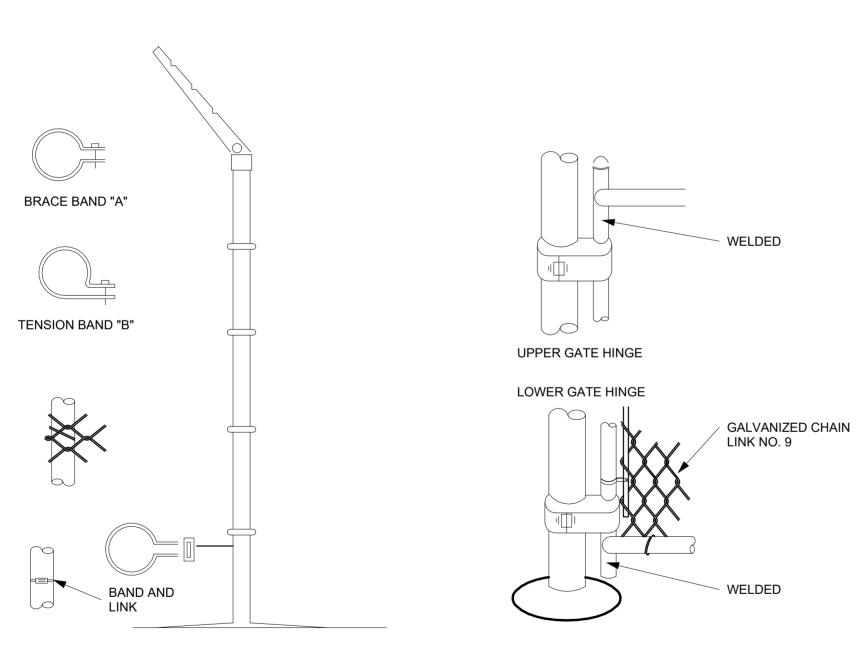
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DRAWING / MODEL LOCATION:

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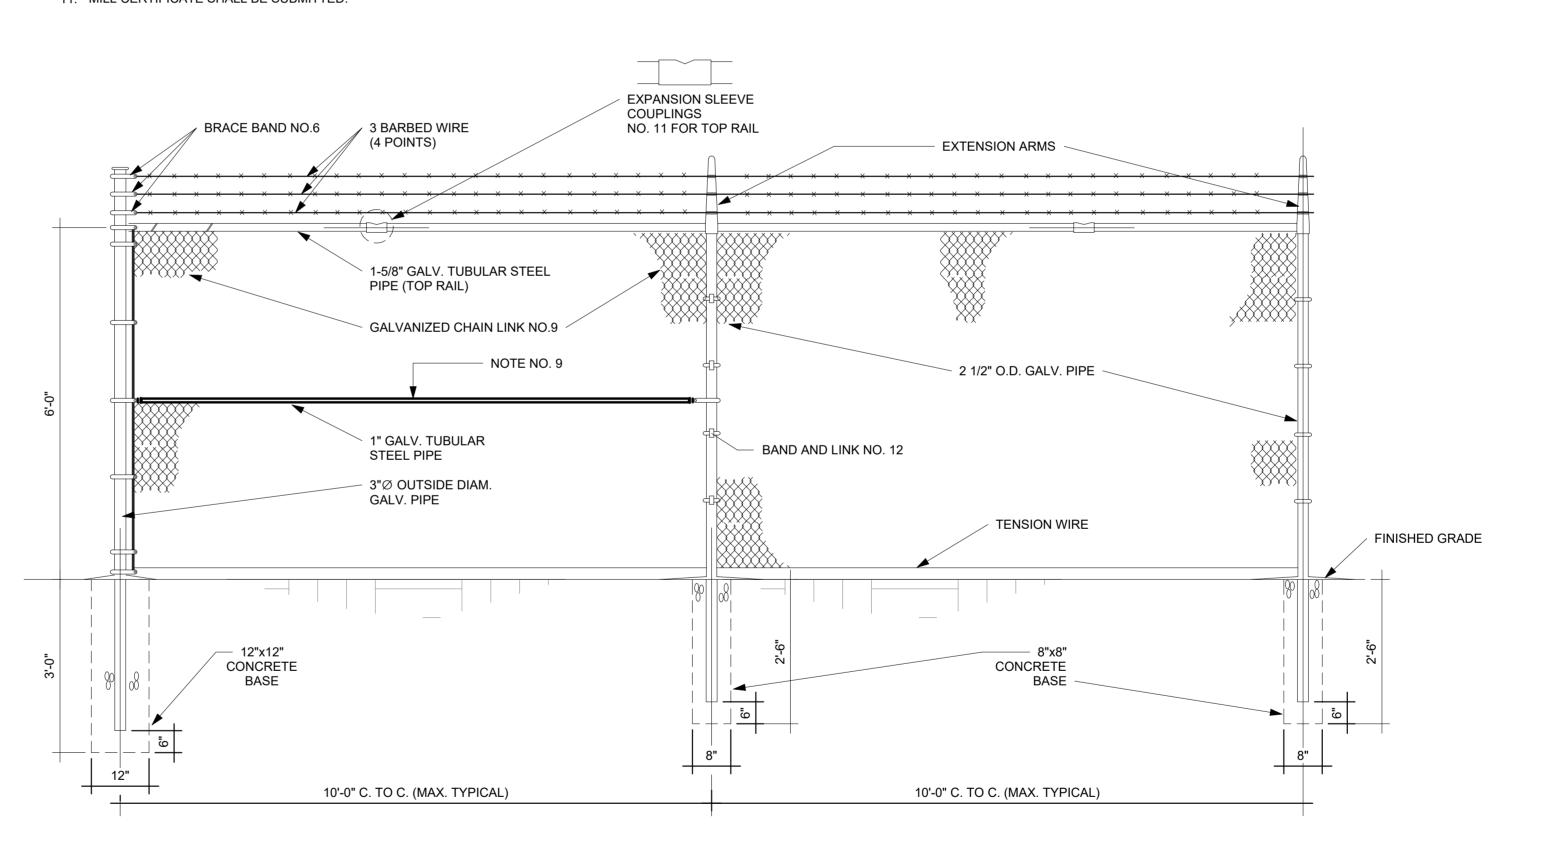


2 INSTALLATION DETAILS FOR CHAIN LINK FENCE & GATES

N.T.S.

NOTES:

- 1. CHAIN LINK FENCE INDUSTRIAL TYPE NO.423
- 2. LINE POSTS 2 1/2" O.D. GALV. STD.WEIGHT PIPE-3.85 LBS. PER LIN. FT.
- 3. TOP RAIL 1 5/8" O.D. GALV. STD.WEIGHT PIPE-2.27 LBS. PER LIN. FT. (GATE FRAME IDEM.)
- 4. CORNER POST 3"Ø O.D. GALV. STD. WEIGHT PIPE 6.79 LBS. PER LIN. FT.
- 5. TENSION WIRE GA. NO.7 GALVANIZED
- 6. GATE POST 4"O.D. GALV. STD. WEIGHT PIPE 9.10 LBS. PER LIN. FT.
- 7. GALVANIZED CHAIN LINK GA. 9-2"X2"-1.2 OUNCES GALVANIZED AFTER WOOVEN.
- 8. STD. WEIGHT PIPE, SCHEDULE 40A. 120 9. ALL FITTINGS EXTRA HEAVY DUTY 10. MILL CERTIFICATE SHALL BE SUBMITTED.
- 9. TUBULAR STEEL PIPE SHALL BE INSTALL EVERY 50'-0" PANEL SPAN (SPAN=10'-0')
 - TUBULAR STEEL PIPE SHALL BE INSTAL EVERY DIRECTIONS CHANGE IN THE FENCE.
 TUBULAR STEEL PIPE SHALL BE INSTALL AT EACH FENCE END PANEL.
- 10. ALL FITTINGS EXTRA HEAVY DUTY.
- 11. MILL CERTIFICATE SHALL BE SUBMITTED.



CHAIN LINK FENCE
PARTIAL ELEVATION

(ALONG PROPERTY LIMITS)

N.T.S.



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ISSUE FOR BID

Issue Date

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J			LINE INF FESIONAL:	ORMATION:

ANNETTE ALFONSO
PROFESSIONAL OF RECORD:
ANNETTE ALFONSO
STAFF DESIGNER:

CARLOS COLON

Q.C. AUDITOR:

PROFESSIONAL'S STATEMENT:

PRINCIPAL CAD TECHNICIAN:

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PRIDCO DAMAGE IMPROVEMENTS

METRO REGION STAGE 1 BID PACKAGE M1-4 PW: 9522 / COMERIO

DATE ISSUE DESCRIPTION

DETAILS AND SPECIFICATIONS

A SCALE:

SHEET TITLE:

46 6HO/W

AS SHOWN

DELIVERY DATE:


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21-0258-02


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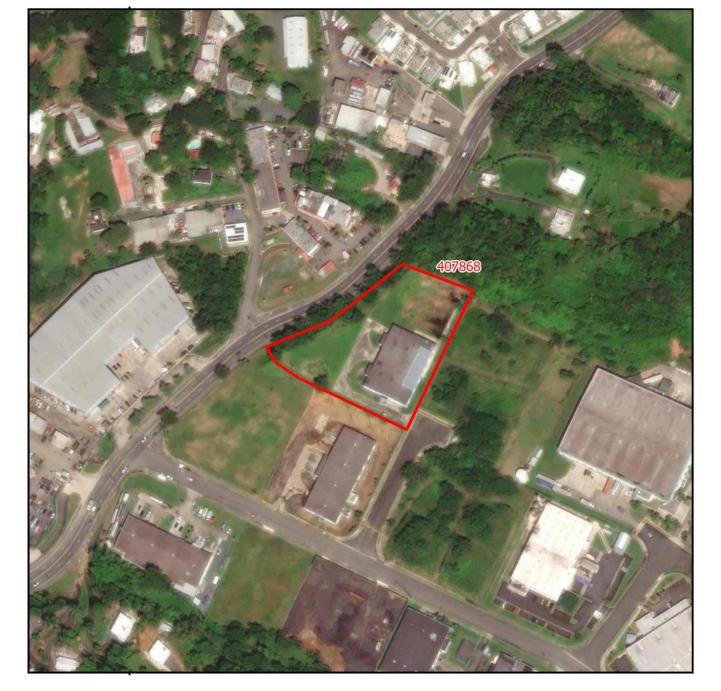
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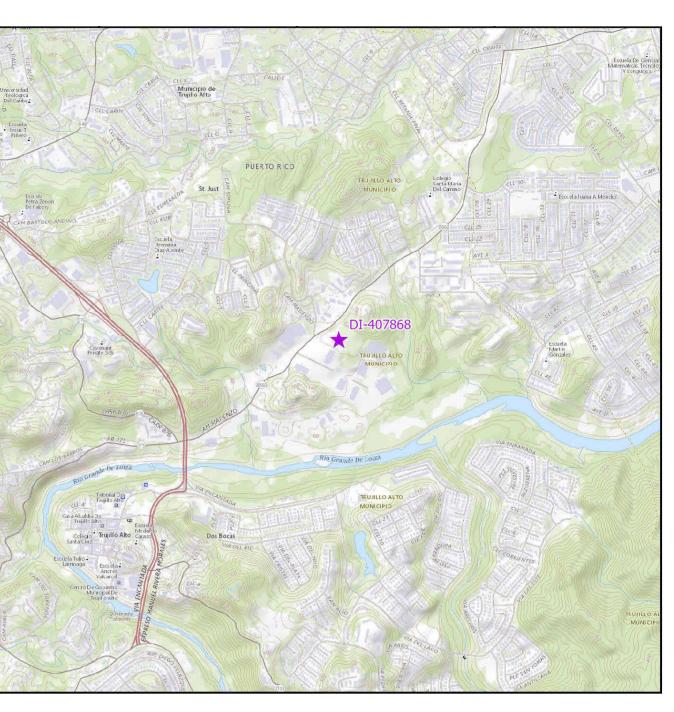
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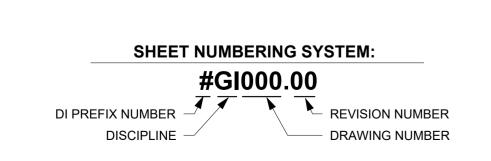
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LOCATION MAP SCALE 1:20,000

INDEX OF DRAWINGS - PW 8583, DI 407868						
Discipline	Sheet Number	Current Revision	Sheet Name			
00GENERAL	3GI001		COVER SHEET-DI-407868			
00GENERAL	3GI002		GENERAL NOTES, ABBREVIATIONS AND LEGEND			
03ARCHITECTURAL	3AE101		SITE PLAN BUILDING # DI-407868			
05DETAILS	3DT501		DETAILS AND SPECIFICATIONS			

PRIDCO-FEMA 4339 DR PROGRAM METRO REGION STAGE 1 BID PACKAGE [M1-4]

3. PW: 8583 / DI: 407868 / Bldg: #T142908800 / Mun: Carr. #860, Bo. Las Cuevas, Trujillo Alto, Puerto Rico 00976

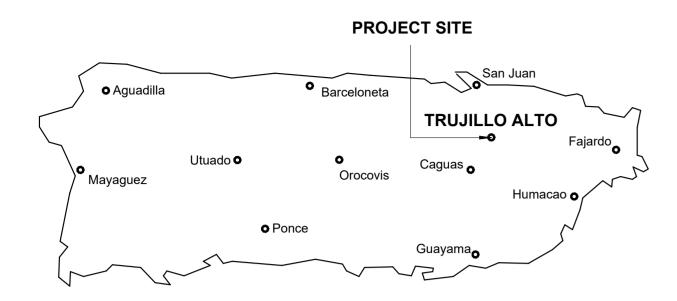

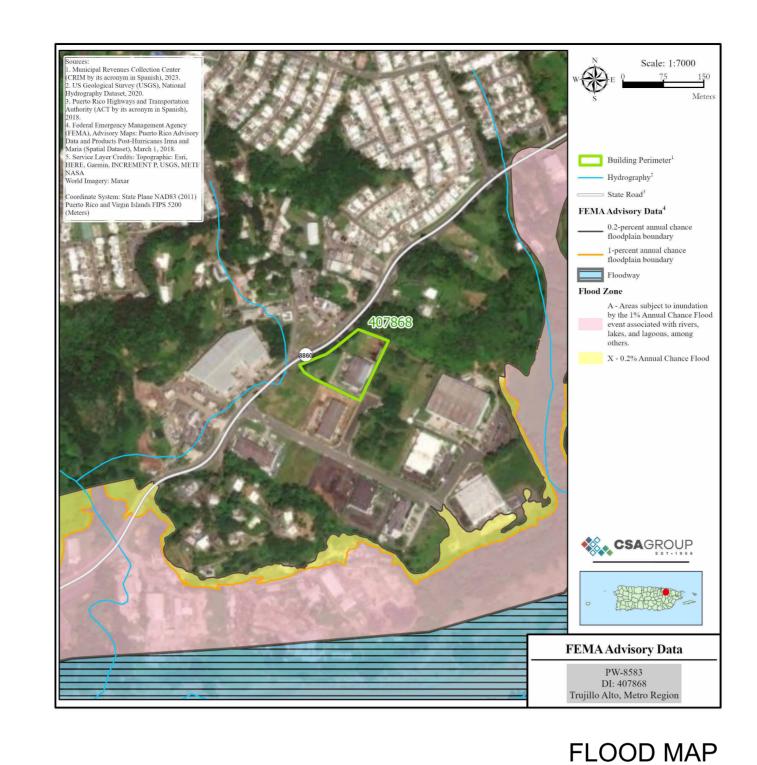





PRIOR THE INSTALLATION OF THE WATERPROOFING SYSTEM. COMPLY WITH

THE MANUFACTURER RECOMMENDATIONS FOR THE INSTALLATION OF ROOF

COORDINATE WITH THE OWNER REPRESENTATIVE/CONSTRUCTION MANAGER

FOR INFORMATION REGARDING ROOFING MEMBRANE WARRANTIES PRIOR TO

TO THE EXHAUST FAN ANCHORING SYSTEM, TO AVOID INVALIDATING THE

ANCHORS, PROPERLY SEAL ANY PENETRATIONS, AND ACCEPT

NO WIRE SHALL BE SMALLER THAN # 12 AWG THHN, 600 VOLTS.

LEAVE A #12 AWG GALVANIZED FISH WIRE IN ALL EMPTY CONDUITS

RESPONSIBILITY FOR MAINTAINING THE MEMBRANE'S WARRANTY

THE INSTALLATION OF ANY ANCHORING DEVICES, INCLUDING BUT NOT LIMITED

WARRANTY. THE CONTRACTOR MUST VERIFY AND ENSURE THE INTEGRITY OF

THE WATERPROOFING SYSTEM DURING THE INSTALLATION OF EXHAUST FAN

ALL CONDUIT SHALL BE RIGID GALVANIZED EXCEPT OTHERWISE INDICATED.

ALL UNDERGROUND CONDUITS SHALL BE PROTECTED WITH 4" CONCRETE

PROVIDE A #12 GREEN THW BONDING JUMPER BETWEEN EACH OUTLET BOX

AND RECEPTACLE GROUNDING TERMINAL, USE 3/8" LONG 10-32 GROUNDING

EXPOSED CONDUITS SHALL BE SUPPORTED BY MEANS OF ONE BOLT CLAMP

ALL NON-GALVANIZED METAL PARTS SHALL BE GIVEN ONE COAT OF RED OXIDE

ALL GALVANIZED RIGID CONDUITS FOR TOGGLE SWITCHES AND RECEPTACLES

ALL LIGHTING CIRCUITS SHALL HAVE ONE (1) PORCELAIN LIGHT SOCKET WITH A

THE NEUTRAL WIRES SHALL BE IDENTIFIED THROUGHT THE INSTALLATION BY

THE USE OF WHITE COLOR COVERED LIVE WIRES WITHIN THE SAME CONDUIT

ALL OVERHANGS AND LEAN - TO'S SHALL BE PROVIDED WITH LIGHT SOCKETS.

CONTACT THE DISTRICT ENGINEER OF LUMA PRIOR TO THE BEGINNING OF THE

ALL INSTALLATIONS SHALL BE IN ACCORDANCE WITH THE LATEST RULES AND

NUMBERS AND COMPLETE SPECIFICATIONS AND DRAWINGS FOR APPROVAL OF

VERIFY LENGTH OF FEEDERS IN THE FIELD BEFORE SUBMITTING BIDS.

OVERHANGS SHALL BE PROVIDED WITH STAINLESS STEEL COVERS.

ALL SWITCHES AND RECEPTACLES THAT ARE CONCEALED IN WALLS AND

WORK AND COORDINATE WITH THEM FOR THE EXECUTION OF THE WORK

CONCERNING THE SERVICE ENTRANCE AND SUBSTATION IF REQUIRED. IN

ADDITION, A CERTIFICATE OF INSPECTION SHALL BE OBTAINED AT THE

COMPLETION OF THE WORK AND FORWARDED TO THE PUERTO RICO

ALL BOXES FOR RECEPTACLES & LIGHTING SWITCHES FOR EXPOSED

A LIST OF MATERIALS AND EQUIPMENT GIVING MANUFACTURER CATALOG

P.R.I.D.C.O. SHALL BE SUBMITTED PRIOR TO THE PURCHASING OF SAID

RECEPTACLES AND LIGHTING CIRCUITS SHALL BE #12 THHN WIRE AND SHALL BE

LOCATED AT DOORWAYS AND LEAN - TO SHALL BE CONCEALED WITHIN ROOF

ALL INSTALLATIONS SHALL BE EXPOSED UNLESS OTHERWISE INDICATED.

AN EXPOSED WORK CONDULET SHALL BE USED FOR ALL 90 BENDS.

OF THE REPRESENTATIVE FROM THE MECHANICAL AND ELECTRICAL

LED TYPE BULB, EQUIVALENT TO 100W INCANDESCENT LUMENS.

SWITCHES AND RECEPTACLES SHALL BE INSTALLED 4'-0" A.F.F.

CONNECTED TO 20 AMP BREAKERS AT THE PANELBOARD.

AND TWO COATS OF METALLIC GRAY PRIOR TO INSTALLATION.

MEMBRANE TO VALIDATE THE WARRANTY.

NO CONDUIT SHALL BE SMALLER THAN 3/4"

ALL WIRE SHALL BE COPPER, INSULATED AS NOTED.

ELECTRICAL GENERAL NOTES

EXPANSION JOINTS.

DEPARTMENT

ALL LOADS SHALL BE BALANCED

SLAB, WALLS AND OVERHANGS.

SPACED NOT FURTHER THAN 7'-6" APART.

SHALL BE COLOR CODED AS PER N.E.C.

INDUSTRIAL DEVELOPMENT COMPANY.

REGULATIONS OF THE N.E.C. AND LUMA.

INSTALLATION SHALL BE "FS" TYPE.

MATERIALS AND/OR EQUIPMENT.

HVAC GENERAL NOTES:

PLUMBING GENERAL NOTES:

SUPPLY AND INSTALL ALL ELECTRICAL CONTROLS, SAFETY SWITCHES AND ACCESSORIES NOT INDICATED IN THE ELECTRICAL DRAWING AND NECESSARY FOR THE PROPER OPERATION OF THE EQUIPMENT IN ACCORDANCE WITH THE MECHANICAL EQUIPMENT RECOMMENDATIONS AND THE NATIONAL ELECTRIC CODE.

PERFORM ALL WIRING AND CONNECTION (POWER AND CONTROL) NOT INDICATED IN THE ELECTRICAL DRAWINGS AND NECESSARY FOR THE PROPER OPERATION OF THE MECHANICAL EQUIPMENT IN STRICT ACCORDANCE WITH THE NATIONAL ELECTRIC CODE.

PLUMBING SHALL BE IN STRICT ACCORDANCE WITH THE 2018 PUERTO RICO BUILDING CODE

ALL PIPING CONCEALED WHEREVER POSSIBLE UNLESS OTHERWISE NOTED.

DIAMETER OR LESS AND NOT MORE THAN 100 FEET APART FOR LARGER PIPES.

WITH CODE REQUIREMENTS OR AS SHOWN ON DRAWINGS.

SHALL BE BROUGHT TO THE ATTENTION OF THE ARCHITECT.

PIPES SHALL BE SLOPED 1/8"PER FOOT.

BEING INSTALLED BY ANOTHER SUB-CONTRACTOR.

ASTM D 2564 B. GASKETS: ASTM F 477, ELASTOMERIC SEAL.

SLEEVES SHALL BE SCHEDULES 40 GALVANIZED STEEL PIPE.

SERVICES. FLOOR SLEEVES ARE TO PROJECT 2" ABOVE FINISHED FLOORS.

WHENEVER THE HORIZONTAL DISTANCE BETWEEN THEM IS LESS THAN 5 FT.

SUPPLY AND INSTALL 1/4 TURN SHUT OFF VALVES AT EVERY PLUMBING FIXTURE.

ALL PLUMBING FIXTURES, COLORS AND FINISHES, SELECTION BY ARCHITECT.

DIRECTION FROM HORIZONTAL TO VERTICAL

FURNISH AND SET IN PLACE BEFORE CONCRETE POURING ALL NECESSARY SLEEVES FOR WASTE OR SOIL,

THE PLUMBING DRAWING IS GENERALLY DIAGRAMATTIC AND INDICATIVE OF THE WORK TO BE INSTALLED. RUN

SIZES SHOWN IN FIXTURE SCHEDULE ARE MINIMUM AND SHALL BE INCREASED AS NECESSARY TO COMPLY

BEFORE CONSTRUCTION VERIFY EXISTING ELEVATIONS AGAINST PROPOSED SLOPES. ANY DISCREPANCIES

CLEANOUT SHALL BE OF SAME SIZE AS THE PIPES TO WHICH THEY ARE CONNECTED UP TO 4", FOR LARGE

CLEANOUT SHALL BE NOT MORE THAN 50 FEET AP-ART IN HORIZONTAL DRAINAGE LINES OF 4" NOMINAL

FOR FIXTURES AND EQUIPMENT NOT LISTED IN SCHEDULE, SEE CONTRACT SPECIFICATIONS.

USE LONG SWEEPING FITTINGS AND/OR LONG SWEEP BENDS AT BASE OF ALL STACKS.

UNLESS OTHERWISE INDICATED, ALL DRAINAGE PIPING 3" AND SMALLER SHALL BE SLOPED 1/4" PER FT., LARGER

DETERMINE EXACT LOCATION OF THE PIPING TO AVOID ANY INTERFERENCE WITH PIPING AND/OR EQUIPMENT

SANITARY TEES (SINGLE AND DOUBLE) AND QUARTER BENDS SHALL BE ACCEPTABLE ONLY FOR CHANGES OF

PROVIDE ROUGHING-IN AND INSTALL ALL PLUMBING FIXTURES AND/OR EQUIPMENT WHICH ARE SUPPLIED BY

FOR ALL UNDERGROUND SANITARY AND STORM DRAINAGE USE: PVC POLYVINYL CHLORIDE) SEWER PIPE AND

PROVIDE ALL PIPE OPENINGS THROUGH SLABS WITH SLEEVES HAVING AN INTERNAL DIAMETER AT LEAST 1"

BOTTOM OF THE WATER SERVICES LINE SHALL BE 12 INCHES ABOVE THE HIGHEST POINT OF THE SEWER LINE

PROVIDE DOWNSPOUT NOZZLES (SIMILAR TO JAY R. SMITH FIG 1770) AT THE OVERFLOW RAIN WATER OUTLETS,

LARGER THAN THE OUTSIDE DIAMETER OF UN-INSULATED PIPES OR OF THE INSULATION FOR INSULATION

FITTING: ASTM D 3034, SDR-35, FOR SOLVENT CEMENT OR ELASTOMERIC GASKET JOINTS. A. SOLVENT CEMENT:

VENT, HOT, AND COLD WATER LINES, THESE SLEEVES SHALL BE AS SPECIFIED OR REQUIRED BY THE

TAKE EVERY PRECAUTION IN ORDER TO MINIMIZE OR ELIMINATE THE TRANSMISSION OF NOISE OR VIBRATION FROM THE EQUIPMENT, PIPING SYSTEM OR DUCT SYSTEM TO THE CONDITIONING SPACE.

EQUIPMENT, MATERIALS AND ACCESSORIES SHALL BE SIMILAR TO THE INDICATED SPECIFICATION AND/OR MANUFACTURER MODEL OR CATALOG NUMBER.

UNLESS OTHERWISE NOTED IN DRAWINGS AND/OR SPECIFICATIONS ALL EQUIPMENT AND ACCESSORIES SHALL BE FURNISHED AND INSTALLED BY THE CONTRACTOR

CIVIL SITE GENERAL NOTES

ALL DISTANCES AND ELEVATIONS ARE EXPRESSED IN METERS UNLESS OTHERWISE SPECIFIED. ELEVATIONS ARE REFERRED TO MEAN SEA LEVEL

COORDINATES ARE BASED ON THE LAMBERT PROJECTION FOR PUERTO RICO AND THE US VIRGIN ISLAND AND REFERENCED TO THE NORTH AMERICAN DATUM OF 1983 (NAD83 NA2011) EPOCH 2010.00 ADJUSTED IN **METERS**

COORDINATE WITH THE CONSTRUCTION MANAGER BEFORE CUTTING OR TRIMMING EXISTING TREES AFFECTED EXPANSION FITTINGS SHALL BE USED FOR EVERY CONDUIT CROSSING BUILDING BY THE CONSTRUCTION.

PREPARE AND SUBMIT FOR EACH PROJECT AREA, THE CONTROL OF EROSION AND SEDIMENTATION (CES) PLAN FOR APPROVAL BY THE PERTINENT AGENCY AND THE CONSTRUCTION MANAGER.

PROVIDE AND MAINTAIN A DEWATERING SYSTEM TO KEEP SUBGRADES DRY ANDCONVEY GROUND WATER AWAY FROM EXCAVATIONS. THE DEWATERING PLAN SHALL BE SUBMITTED TO THE CONSTRUCTION MANAGER FOR APPROVAL AND COORDINATION.

DEWATERING PLANS SHALL INCLUDE CONTROL OF EROSION AND SEDIMENTATION FOR EACH PROJECT PHASE AND/OR WORK AREA. THE WATER FROM THE DEWATERING SYSTEM SHALL BE FREE OF SEDIMENT AND/OR DEBRIS BEFORE ANY DISPOSAL

MAINTAIN THE DEWATERING SYSTEM UNTIL DEWATERING IS NO LONGER REQUIRED. ELECTRICAL, COMMUNICATION, SANITARY AND POTABLE WATER SERVICE SHALL NOT BE INTERRUPTED DURING CONSTRUCTION. IF NECESSARY, A PROVISIONAL TEMPORARY SERVICE AND/OR BY-PASS SHALL BE INSTALLED TO MAINTAIN SERVICE. PROVISIONAL TEMPORARY SERVICE AND/OR BY-PASS SHALL BE SUBMITTED TO THE CONSTRUCTION MANAGER FOR APPROVAL AND COORDINATION PRIOR TO CONSTRUCTION. PREPARE AND SUBMIT THE MAINTENANCE OF SERVICE PLAN FOR ELECTRICAL, SANITARY AND POTABLE WATER

PROVIDE ELECTRICAL SERVICE TO TEST ALL ELECTRICAL SYSTEM IN PRESENCE FOR APPROVAL OF THE CONSTRUCTION MANAGER. NOTIFY THE CONSTRUCTION MANAGER IF ANY ELEMENT SUSPECTED OF CONTAINING HAZARDOUS MATERIAL IS ENCOUNTERED, PRIOR TO ANY RELATED WORK ACTIVITY.

VISIT THE PROJECT AREA TO VERIFY THE SPACE LIMITATIONS FOR CONSTRUCTION PROCESS AND EQUIPMENT. THE CONTRACT PRICE SHALL CONSIDER THE REQUIRED CONSTRUCTION PROCESS AND/OR EQUIPMENTS. PRIOR TO COMMENCEMENT OF THE WORK, ALL DIMENSIONS AND EXISTING CONDITIONS AT PROJECT SITE

SHALL BE VERIFIED AND ANY DISCREPANCIES BETWEEN EXISTING CONDITIONS AND CONTRACT DOCUMENTS THAT COULD AFFECT CONSTRUCTION WORK SCHEDULE AND /OR PERFORMANCE SHALL BE NOTIFIED TO CONSTRUCTION MANAGER.

ALL DETAILS, SECTIONS AND NOTES SHOWN ON DRAWINGS ARE INTENDED TO BE TYPICAL AND SHALL APPLY TO SIMILAR SITUATIONS ELSEWHERE UNLESS OTHERWISE NOTED.

REPAIR OR REPLACE EXISTING FACILITIES DAMAGED DURING CONSTRUCTION PRIOR TO SUBSTANTIAL

COMPLETION.

MAINTAIN IN OPERATION EXISTING FACILITIES UNTIL NEW FACILITIES ARE IN OPERATION.

GENERAL STRUCTURAL NOTES

STRUCTURAL BUILDING AND DESIGN CODES:

PUERTO RICO BUILDING CODE 2018 AND ITS BINDING REFERENCED STANDARDS, INCLUDING BUT NOT LIMITED TO:

THE INTERNATIONAL BUILDING CODE 2018 AMERICAN INSTITUTE FOR STEEL CONSTRUCTION (AISC), STEEL CONSTRUCTION MANUAL, 15 TH EDITION

AMERICAN CONCRETE INSTITUTE (ACI). BUILDING CODE REQUIREMENTS FOR STRUCTURAL CONCRETE. ACI 318-14. AMERICAN SOCIETY OF CIVIL ENGINEERS, MINIMUM DESIGN LOADS AND ASSOCIATED CRITERIA FOR BUILDINGS AND OTHER STRUCTURES, ASCE/SEI 7-16

STRUCTURAL NOTES ON CONCRETE REPAIR:

ALL CONCRETE REPAIR WORKS SHALL BE PERFORMED FOLLOWING THE GUIDELINES OF THE INTERNATIONAL CONCRETE REPAIR INSTITUTE (ICRI). HIRING A PROFESSIONAL EXPERIENCED IN THIS TYPE OF REPAIR IS RECOMMENDED TO ENSURE A

FOR THE REPAIR OF AREAS AFFECTED BY CORROSION, ICRI NO. 03730 GUIDELINE FOR SURFACE PREPARATION FOR THE REPAIR OF DETERIORATED CONCRETE RESULTING FROM REINFORCING STEEL CORROSION SHOULD BE FOLLOWED. BEFORE COMMENCING ANY CONCRETE REPAIR WORK, THE REPAIR DETAILS PRESENTED IN THE DRAWINGS SHALL BE

REVIEWED. IN CASE OF DOUBT WITH THE REPAIR DETAILS PRESENTED, CONTACT THE ARCHITECT OR ENGINEER OF RECORD

FOR CLARIFICATION IT IS IMPORTANT TO FOLLOW THE MANUFACTURER'S RECOMMENDATIONS FOR EACH PRODUCT UTILIZED FOR THIS JOB, IN ORDER TO GUARANTEE THAT THE REPAIR WORKS ARE CARRIED OUT ADEQUATELY.

STRUCTURAL NOTES ON CAST-IN-PLACE CONCRETE:

PORTLAND CEMENT SHALL BE TYPE II.

ALL CONCRETE SHALL BE OF REGULAR WEIGHT (145 POUNDS PER CUBIC FOOT) THE FOLLOWING CONCRETE MIX PARAMETERS SHALL BE USED UNLESS OTHERWISE NOTED:

CONCRETE STRENGTH AT 28 DAYS - 3,000 PSI MAX. WATER/CEMENT RATIO - 0.65 RECOMMENDED SLUMP – 4 INCHES MAX. AGGREGATE SIZE (ASTM C33) – 1 INCH

PROVIDE CONCRETE MIXES DESIGNED BY A QUALIFIED TESTING LABORATORY FOR REVIEW AND APPROVAL BY THE STRUCTURAL ENGINEER. CONCRETE MIX DESIGN SHALL BE SIGNED AND SEALED BY A PROFESSIONAL ENGINEER AUTHORIZED TO EXERCISE THE PROFESSION IN THE COMMOM WEALTH OF PUERTO RICO.

NOTE ON REINFORCING STEEL BARS:

ALL REINFORCING STEEL SHALL BE NEW STOCK DEFORMED BARS CONFORMING TO ASTM A615, GRADE 60 (FY = 60 KSI). MAINTAIN THE FOLLOWING CONCRETE COVERAGE FOR REINFORCING STEEL UNLESS NOTED OTHERWISE:

CONCRETE CAST AGAINST EARTH: 3 INCHES

CONCRETE IN CONTACT WITH THE GROUND: 2 INCHES

CONCRETE SLAB AND WALLS WITHOUT CONTACT WITH GROUND: 1 INCHES

CONCRETE BEAMS AND COLUMNS: 1 1/2 INCHES

STRUCTURAL STEEL

DESIGN, DETAIL AND ERECT STRUCTURAL STEEL ELEMENTS IN ACCORDANCE WITH THE FOLLOWING:

AISC SPECIFICATION FOR THE DESIGN, FABRICATION, AND ERECTION OF STRUCTURAL STEEL FOR BUILDINGS.

AISC MANUAL OF STEEL CONSTRUCTION, ALLOWABLE STRESS DESIGN.

AISC CODE OF STANDARD PRACTICE FOR STEEL BUILDINGS AND BRIDGES.

STRUCTURAL STEEL SHALL CONFORM TO THE FOLLOWING GRADES:

W SHAPES: ASTM A992 (FY = 50 KSI, FU = 65 KSI)

AWS STRUCTURAL WELDING CODE, D1.1

STEEL ANGLE, CHANNELS, PLATES: ASTM A36 BOLTS, NUTS AND WASHERS: HIGH-STRENGTH BOLTS, INCLUDING NUTS AND WASHERS: ASTM A325

STEEL PLATES FOR LANDINGS AND THREADS: 1/4" ANTI-SLIP DIAMOND TYPE STEEL PLATE A36

WELDING ELECTRODE FOR STEEL SHALL BE E70XX.

PROVIDE DESIGN, FABRICATION, AND ERECTION OF METAL DECK CONFORMING TO THE STEEL DECK INSTITUTE'S "CODE OF RECOMMENDED STANDARD PRACTICE AND BASIC DESIGN SPECIFICATIONS".

FORM ROOF DECK FROM STEEL SHEETS CONFORMING TO ASTM A 611 GRADE C AND D OR A 653 OR HIGHER SPECIFICATIONS

WITH A MINIMUM YIELD STRENGTH OF 33 KSI. ATTACH SHEETS TO STEEL SUPPORT MEMBERS AS INDICATED AND IN ACCORDANCE WITH THE MANUFACTURER'S

INSTRUCTIONS FOR INSTALLATION. WHEN DECK IS SCHEDULED TO BEEXPOSED, DE-SLAG, CLEAN AND TOUCH UP WELDS WITH A

LAP ROOF AND FLOOR DECK ENDS MINIMUM OF 2 INCHES. WHEN FASTENING DECK TO SUPPORT MEMBERS PROVIDE WELDING MATERIALS INSTALLATION PROCEDURES TO PREVENT BURNING OF HOLES IN DECK. AT ENDS OF DECKS OR WHERE CHANGES OF DECK DIRECTION OCCUR. FASTEN TO SUPPORTS AT EACH FLUTE. PROVIDE

ADEQUATE CLOSURES AND FASTENERS TO SIDES AT EIGHTEEN INCHES ON CENTER. WHERE PARTIAL PANELS MAY BE REQUIRED TO COMPLETE DECK INSTALLATION AT PERIMETER OF STRUCTURE, PROVIDE

WELDS IN EACH FLUTE TO STRUCTURAL MEMBERS. INSTALL DECK IN THREE CONTINUOUS SPAN LENGTHS. AT PERIMETER OF DECK, SECURE DECK TO STRUCTURAL MEMBERS WITH SAME ATTACHMENTAND SPACING SUPPORT

ATTACHMENT AS INDICATED ON PLANS HOT DIP GALVANIZE (G90) AFTER FABRICATION ALL METAL DECK AND TOUCH UP CONNECTIONS WITH A ZINC-RICH PRIMER.

NOTES (IF APPLICABLE):

TREE REMOVAL:

REMOVE ALL TREES INDICATED BY DRAWINGS AND SPECIFICATIONS, AS REQUIRED, IN A MANNER THAT WILL NOT DAMAGE ADJACENT TREES OR STRUCTURES, OR COMPACT THE SOIL

REMOVE, IN SECTIONS, TREES THAT ARE ADJACENT TO REMAINING TREES OR STRUCTURES , TO LIMIT DAMAGE TO ADJACENT CROWNS, TRUNKS, GROUND PLANE ELEMENTS AND STRUCTURES.

DO NOT CUT TREES UNLESS THE TREE WILL FALL OUTSIDE THE TREE AND PLANT PROTECTION AREA. NO TREE TO BE REMOVED WITHIN 50 FEET OF THE TREE AND PLANT PROTECTION AREA SHALL BE PUSHED OVER OR UP-ROOTED USING GRADING

EQUIPMENT. PROTECT FROM DAMAGE ADJACENT PAVING. SOIL. TREES. SHRUBS. GROUND COVER PLANTINGS AND UNDERSTORY PLANTS TO REMAIN, DURING ALL TREE REMOVAL, AND CONSTRUCTION OPERATIONS. PROTECTION SHALL INCLUDE ROOT SYSTEM, TRUNK,

LIMBS, AND CROWN FROM BREAKAGE OR SCARRING, AND SOIL FROM COMPACTION. REMOVE STUMPS AND IMMEDIATE ROOT PLATE FROM EXISTING TREES TO BE REMOVED. GRIND TRUNK BASES AND LARGE BUTTRESS ROOTS EITHER TO THE DEPTH OF THE LARGEST BUTTRESS ROOT OR AT LEAST 18 INCHES BELOW THE TOP MOST ROOT, CHOOSE WHICH EVER IS LESS. GRIND OVER THE AREA OF THREE TIMES THE DIAMETER OF THE TRUNK (DBH).

FOR TREES WHERE THE STUMP WILL FALL UNDER NEW PAVED AREAS, GRIND ROOTS TO A TOTAL DEPTH OF 18 INCHES BELOW THE EXISTING GRADE. IF THE SIDES OF THE STUMP HOLE STILL HAVE GREATER THAN APPROXIMATELY 20% WOOD VISIBLE, CONTINUE GRINDING OPERATION DEEPER AND/OR WIDER UNTIL THE RESULTING HOLE HAS LESS THAN 20% WOOD. REMOVE ALL WOOD CHIPS PRODUCED BY THE GRINDING OPERATION AND BACK FILL IN 8 INCH LAYERS WITH CONTROLLED FILL OF A QUALITY ACCEPTABLE TO THE SITE ENGINEER FOR FILL MATERIAL UNDER STRUCTURES, COMPACTED TO 95% OF THE MAXIMUM DRY DENSITY STANDARD PROCTOR. THE OWNER'S REPRESENTATIVE SHALL APPROVE EACH HOLE AT THE END OF THE GRINDING OPERATION.

IN AREAS WHERE THE TREE LOCATION IS TO BE A PLANTING BED OR LAWN, REMOVE ALL WOODCHIPS AND BACKFILL STUMP HOLES WITH PLANTING SOIL AS DEFINED IN SPECIFICATION SECTION PLANTING SOIL, IN MAXIMUM OF 12 INCH LAYERS AND COMPACT TO 80 - 85% OF THE MAXIMUM DRY DENSITY STANDARD PROCTOR.

PRUNING:

WITHIN SIX MONTHS OF THE ESTIMATED DATE OF SUBSTANTIAL COMPLETION, PRUNE ALL DEAD OR HAZARDOUS BRANCHES LARGER THAN 2 INCH IN DIAMETER FROM ALL TREES TO REMAIN.

IMPLEMENT ALL PRUNING RECOMMENDATIONS FOUND IN THE ARBORIST REPORT. PRUNE ANY LOW, HANGING BRANCHES AND VINES FROM EXISTING TREES AND SHRUBS THAT OVERHANG WALKS, STREETS AND

DRIVES, OR PARKING AREAS AS FOLLOWS:

1. WALKS - WITHIN 8 FEET VERTICALLY OF THE PROPOSED WALK ELEVATION.

2. PARKING AREAS - WITHIN 12 FEET VERTICALLY OF THE PROPOSED PARKING SURFACE ELEVATION.

3. STREETS AND DRIVES - WITHIN 14 FEET VERTICALLY OF THE PROPOSED DRIVING SURFACE ELEVATION.

ALL PRUNING SHALL BE DONE IN ACCORDANCE WITH ANSI A300 (PART 1), ISA BMP TREE PRUNING (LATEST EDITION, AND THE "STRUCTURAL PRUNING: A GUIDE FOR THE GREEN INDUSTRY", EDWARD GILMAN, BRIAN KEMPF, NELDA MATHENY AND JIM CLARK, 2013 URBAN TREE FOUNDATION, VISALIA CA.

PERFORM OTHER PRUNING TASK AS INDICATED ON THE DRAWINGS OR REQUESTED BY THE OWNER'S REPRESENTATIVE. WHERE TREE SPECIFIC DISEASE VECTORS REQUIRE, STERILIZE ALL PRUNING TOOLS BETWEEN THE WORK IN INDIVIDUAL

GENERAL DRAWING SYMBOLS: ABBREVIATIONS:

EXISTING WALL

NEW CONCRETE BLOCK WALL 6" OR 8"

HIDDEN OUTLINE (SHOWING

DETAIL REFERENCE NUMBER

ELEVATION REFERENCE NUMBER

SHEET WHERE DETAIL IS DRAWN

SHEET WHERE ELEVATION IS DRAWN

GENERAL BUILDING SECTION

SHEET WHERE SECTION IS DRAWN

WALL SECTION REFERENCE NUMBER

SHEET WHERE INT. ELEV. IS DRAWN

INTERIOR ELVATION SYMBOL

ELEVATION REFERENCE NUMBER

NORTH ARROV

AXIS SYMBO

DOOR SYMBO

KEY NOTE

LEVEL SYMBOI

RISER SYMBOL

☐ ROOM NUMBER

WINDOW SYMBO

EQUIPMENT SYMBOL

ROOM IDENTIFICATIO

REVISION SYMBOL

HANDICAPPED SYMBO

THE ASBESTOS ABATEMENT SHALL INCLUDE. BUT NOT BE LIMITED TO THE

FOLLOWING (IF APPLICABLE. REFER TO GENERAL NOTES #15.):

CONSTRUCTION OF TEMPORARY CONTAINMENT

BARRIER/DECONTAMINATION ENCLOSURES

PREPARATION FOR ABATEMENT OPERATIONS

APPLICATION OF LOCKDOWN ENCAPSULANTS

NOTIFICATION TO REGULATORY AGENCIES

WORKER HEALTH AND SAFETY PROGRAM

PREPARATION FOR ABATEMENT OPERATIONS

CONTAINMENT AND DECONTAMINATION UNIT

AND DECONTAMINATION UNIT

THE SAFETY OF ITS EMPLOYEES

NECESSARY FOR CONDUCTING THE

DECONTAMINATION AND CLEANING

FINAL JOB CLOSE-OUT

REGULATORY PERMITS. LICENSES, AND APPROVALS

REGULATORY PERMITS, LICENSES AND APPROVALS

REMOVAL OF EXISTING ASBESTOS-CONTAINING MATERIAL

TRANSPORT AND DISPOSAL OF ASBESTOS-CONTAINING MATERIAL

ABATEMENT OF LEAD-BASED PAINT AND LEAD-BASED PAINT HAZARDS GENERAL

ITEMS INCLUDE, BUT NOT LIMITED TO (IF APPLICABLE. REFER TO GENERAL

ABATEMENT OF EXISTING LEAD-BASED PAINT OWNER BUILDING

PERFORMANCE OF INCIDENTAL MECHANICAL AND ELECTRICAL WORK

REMOVAL OF ENGINEERING CONTROLS, INCLUDING TEARDOWN OF

REMOVAL OF TEMPORARY CONTAINMENT BARRIER/DECONTAMINATION

ESTABLISHING ENGINEERING CONTROLS TO PREVENT MIGRATION OF LEAD

IN AIR FROM THE WORK AREA; INCLUDES CONSTRUCTION OF CONTAINMENT

PERSONAL AIR MONITORING AS REQUIRED BY REGULATORY AGENCIES FOR

TRANSPORT AND DISPOSAL OF LEAD-CONTAINING OR LEAD-CONTAMINATED

NOTIFICATION TO REGULATORY AGENCIES

WORKER HEALTH AND SAFETY PROGRAM

DECONTAMINATION AND CLEANING

AIR MONITORING

ENCLOSURES

MATERIAL

NOTES #15):

FINAL JOB CLOSE-OUT

CONDITION BELOW, ABOVE OR

NEW PLYCEM BOARD WALI

ABOVE FINISHED FLOOR AIR CONDITIONING ALUMINUM BOTTOM CENTER TO CENTER CONCRETE MASONRY UNIT CORRIDOR CORROSION ELEVATION **EQUAL** FLOOR DRAIN FINISH FLOOR ELEVATIONS FINISH FLOOR LEVEL **HARDWARE INTERIOR** JANITOR CLOSET MASONRY **MECHANICAL** MINIMUM MOUNTED NOT IN CONTRACT NOT APPLICABLE ON CENTER ROOF DRAIN ROOM REQUIRED REVISION SMOOTH CEMENT PLASTER STAINLESS STEEL STORM SEWER

STRUCTURAL

TOP OF STEEL

TELEPHONE

TYPICAL

MANHOLE

TOP OF MASONRY

DROP MANHOLE

VERIFY IN FIELD

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PRIDCO

INDUSTRIAL DEVELOPMENT COMPANY

PUERTO RICO

Issue Date

ISSUE FOR BID

UNLESS OTHERWISE NOTED DISCIPLINE INFORMATION: ANNETTE ALFONSO **ANNETTE ALFONSO CARLOS COLON** Q.C. AUDITOR PRINCIPAL CAD TECHNICIAN

YO, ANNETTE ALFONSO

PROFESSIONAL'S STATEMENT:

CERTIFICO QUE SOY EL PROFESIONAL QUE [CONFECCIONÓ, DISEÑÓ O PREPARÓ] ESTOS PLANOS Y LAS ESPECIFICACIONES COMPLEMENTARIAS. TAMBIÉN, CERTIFICO QUE ENTIENDO QUE DICHOS PLANOS Y ESPECIFICACIONES CUMPLEN CON LAS DISPOSICIONES APLICABLES DEL REGLAMENTO CONJUNTO Y LAS DISPOSICIONES APLICABLES DE LOS REGLAMENTOS Y CÓDIGOS DE CONSTRUCCIÓN VIGENTES DE LAS AGENCIAS, JUNTAS REGLAMENTADORAS O CORPORACIONES PÚBLICAS CON JURISDICCION. CERTIFICO, ADEMAS, QUE EN LAPREPARACIÓN DE ESTOS PLANOS Y ESPECIFICACIONES SE HA CUMPLIDO CABALMENTE CON LO DISPUESTO EN LA LEY NÚM. 14 DE 8 DE ENERO DE 2004, SEGÚN ENMENDADA, CONOCIDA COMO LA "LEY PARA LA INVERSIÓN POR LA INDUSTRIA PUERTORRIQUEÑA" Y CON LA [LEY NÚM. 319 DE 15 DE MAYO DE 1938, SEGÚN ENMENDADA; LEY NÚM 96 DE 6 DE JULIO DE 1978 SEGÚN ENMENDADA: SEGÚN APLIQUEI. RECONOZCO QUE CUALQUIER DECLARACIÓN FALSA O FALSIFICACIÓN DE LOS HECHOS QUE SE HAYA PRODUCIDO POR

DESCONOCIMIENTO O POR NEGLIGENCIA YA SEA POR MÍ, MIS AGENTES O EMPLEADOS, O POR OTRAS PERSONAS CON MI CONOCIMIENTO, ME HACEN RESPONSABLE DE CUALQUIER ACCIÓN JUDICIAL Y DISCIPLINARIA POR LA OGPE.

PRIDCO DAMAGE IMPROVEMENTS **METRO REGION STAGE 1** BID PACKAGE M1-4

PW: 9522 / COMERIO

DATE ISSUE DESCRIPTION

GENERAL NOTES.


ABBREVIATIONS AND LEGEND

SHEET TITLE:


AS SHOWN

DELIVERY DATE: PROJECT NUMBER 21-0258-02 PRINT DATE & TIME BIM FILE NAME: 8/8/2024 10:52:22 AM DRAWING / MODEL LOCATION:



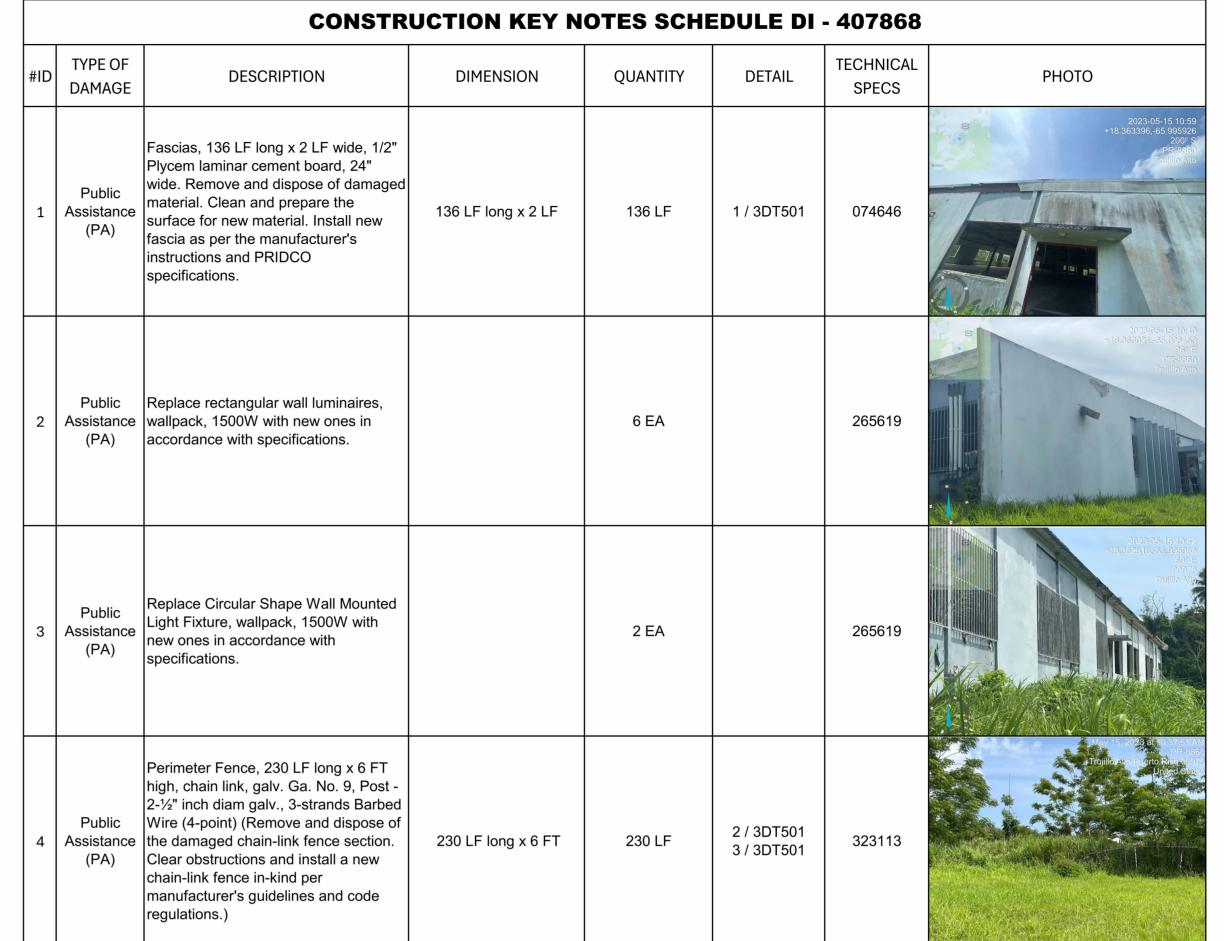

NOTE: SEE GENERAL NOTES, ITEM #7 IN 3GI002

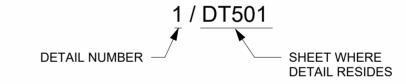



1 KEY PLAN DI 407868

N.T.S.



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CSA ARCHITECTS AND ENGINEERS.



ISSUE FOR BID

Issue Date

	RE	V	DATE		DESCRIPTION
С					
	DIS	CIP	LINE INF	OR	RMATION:

DISCIPLINE INFORMATION: RIME PROFESIONAL:

ANNETTE ALFONSO
PROFESSIONAL OF RECORD:
ANNETTE ALFONSO
STAFF DESIGNER:
CARLOS COLON
Q.C. AUDITOR:

PRINCIPAL CAD TECHNICIAN:

PROFESSIONAL'S STATEMENT:

YO, ANNETTE ALFONSO

NUM. LIC. 12304

CERTIFICO QUE SOY EL PROFESIONAL QUE [CONFECCIONÓ, DISEÑO O PREPARO] ESTOS PLANOS Y LAS ESPECIFICACIONES COMPLEMENTARIAS. TAMBIÉN, CERTIFICO QUE ENTIENDO QUE DICHOS PLANOS Y ESPECIFICACIONES CUMPLEN CON LAS DISPOSICIONES APLICABLES DEL REGLAMENTO CONJUNTO Y LAS DISPOSICIONES APLICABLES DE LOS REGLAMENTOS Y CÓDIGOS DE CONSTRUCCIÓN VIGENTES DE LAS AGENCIAS, JUNTAS REGLAMENTADORAS O CORPORACIONES PÚBLICAS CON JURISDICÇION. CERTIFICO, ADEMAS, QUE EN LAPREPARACIÓN DE ESTOS PLANOS Y ESPECIFICACIONES SE HA CUMPLIDO CABALMENTE CON LO DISPUESTO EN LA LEY NÚM. 14 DE 8 DE ENERO DE 2004, SEGÚN ENMENDADA, CONOCIDA COMO LA "LEY PARA LA INVERSIÓN POR LA INDUSTRIA PUERTORRIQUEÑA" Y CON LA [LEY NÚM. 319 DE 15 DE MAYO DE 1938, SEGÚN ENMENDADA; R LEY NÚM. 96 DE 6 DE JULIO DE 1978, SEGÚN ENMENDADA; SEGÚN APLIQUE]. RECONOZCO QUE CUALQUIER DECLARACIÓN FALSA O FALSIFICACIÓN DE LOS HECHOS QUE SE HAYA PRODUCIDO POR DESCONOCIMIENTO O POR NEGLIGENCIA YA SEA POR MÍ, MIS AGENTES O EMPLEADOS, O POR OTRAS PERSONAS CON MI CONOCIMIENTO, ME HACEN RESPONSABLE DE CUALQUIER ACCIÓN JUDICIAL Y DISCIPLINARIA POR LA OGPE.

PROJE

PRIDCO DAMAGE IMPROVEMENTS METRO REGION STAGE 1 BID PACKAGE M1-4 PW: 9522 / COMERIO

DATE	ISSUE DESCRIPTION					

SHEET TITLE:

AS SHOWN


SITE PLAN BUILDING # DI-407868


DELIVERY DATE: PROJECT NUMBER: 21-0258-02

PRINT DATE & TIME: BIM FILE NAME: 8/8/2024 10:52:27 AM


3AE101

DRAWING / MODEL LOCATION:

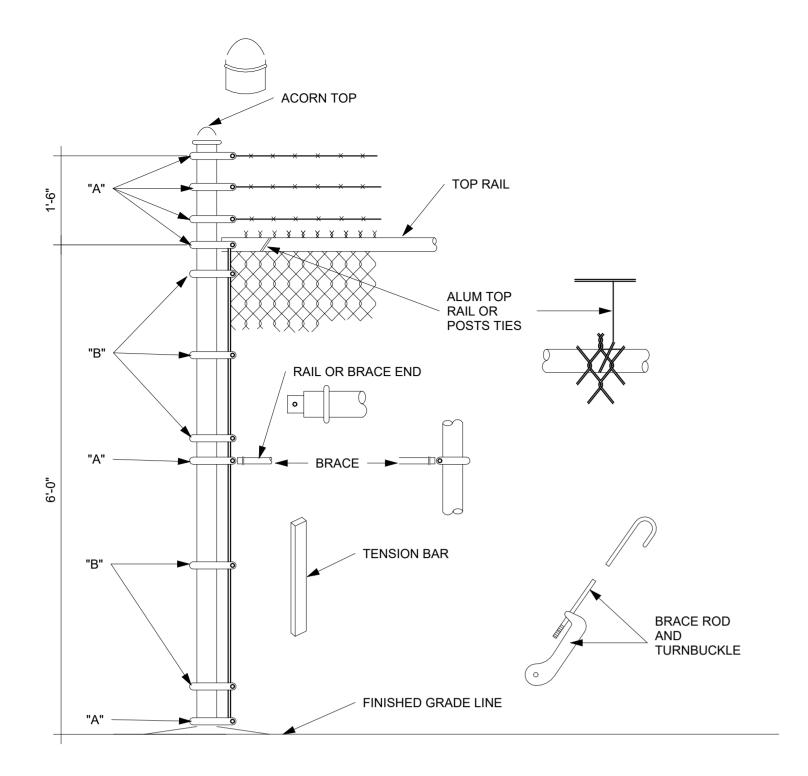

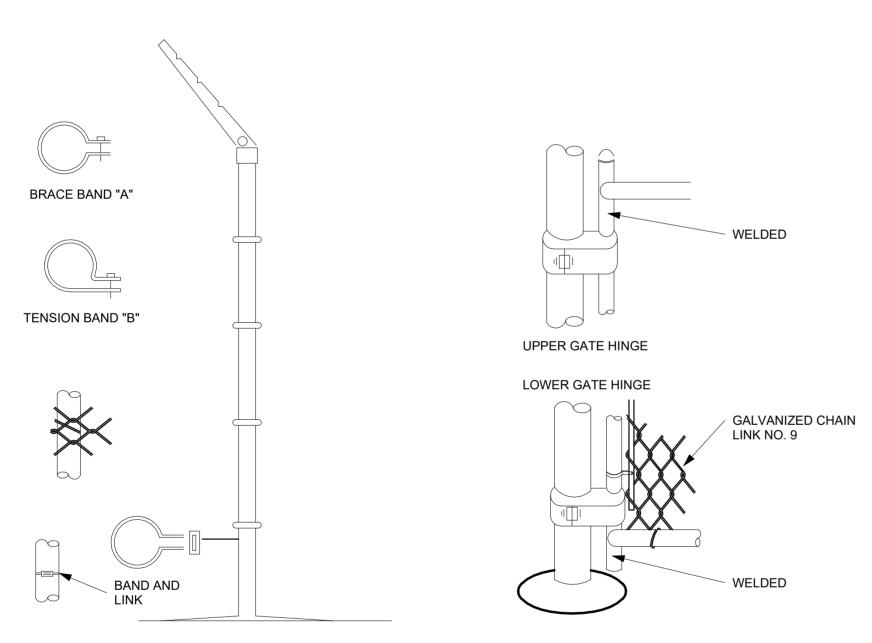


INSTALLATION DETAILS FOR CHAIN LINK FENCE & GATES

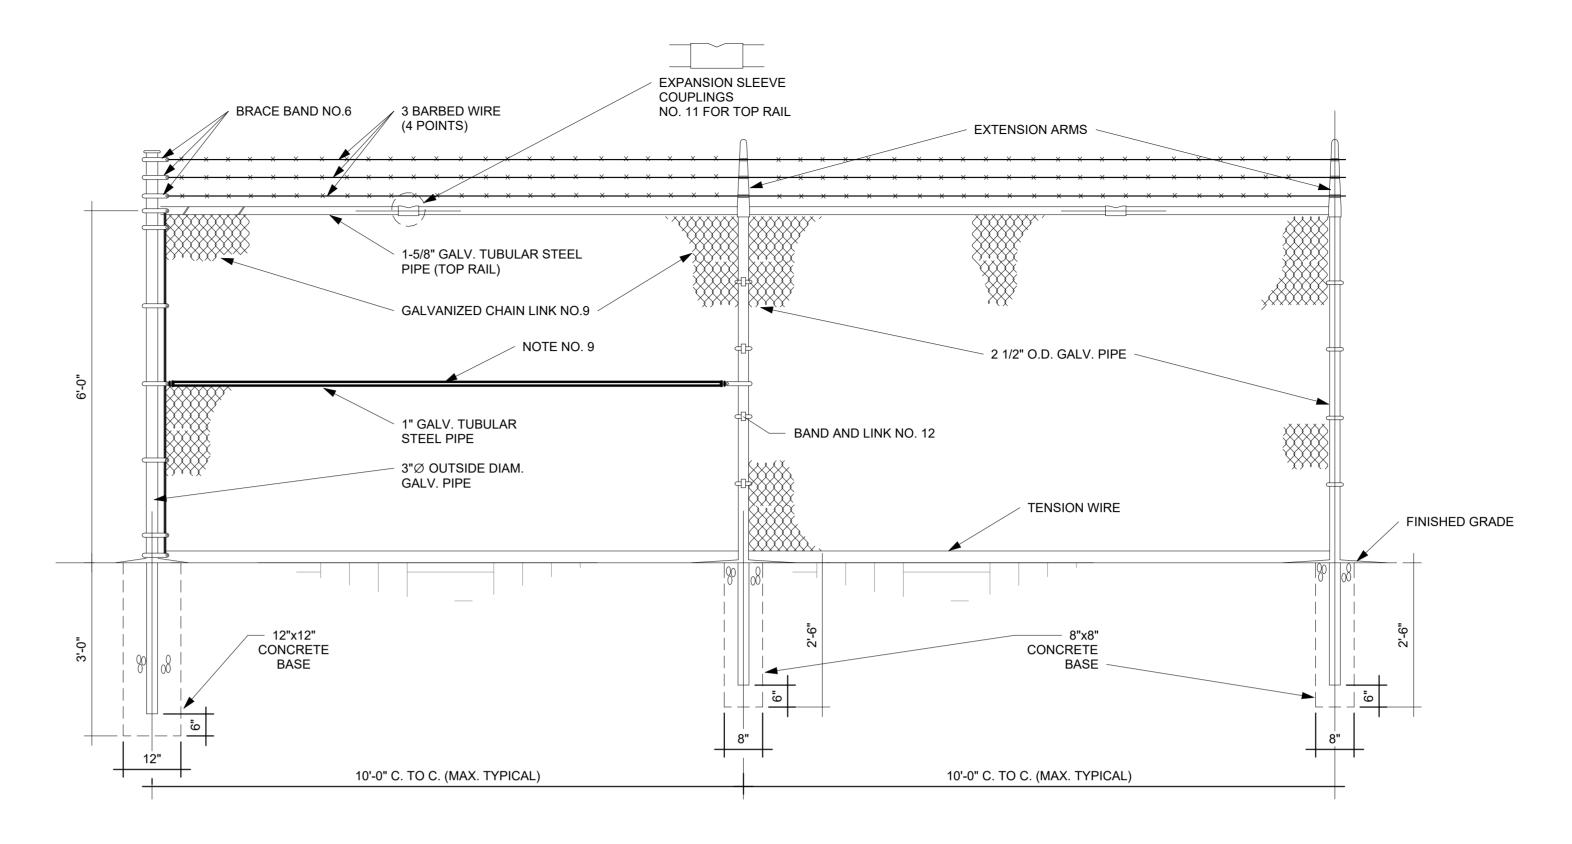

NOTES:

- 1. CHAIN LINK FENCE INDUSTRIAL TYPE NO.423
- 2. LINE POSTS 2 1/2" O.D. GALV. STD.WEIGHT PIPE-3.85 LBS. PER LIN. FT.
- 3. TOP RAIL 1 5/8" O.D. GALV. STD.WEIGHT PIPE-2.27 LBS. PER LIN. FT. (GATE FRAME IDEM.)
- 4. CORNER POST 3"Ø O.D. GALV. STD. WEIGHT PIPE 6.79 LBS. PER LIN. FT.
- 5. TENSION WIRE GA. NO.7 GALVANIZED
- 6. GATE POST 4"O.D. GALV. STD. WEIGHT PIPE 9.10 LBS. PER LIN. FT.
- 7. GALVANIZED CHAIN LINK GA. 9-2"X2"-1.2 OUNCES GALVANIZED AFTER WOOVEN.
- 8. STD. WEIGHT PIPE, SCHEDULE 40A. 120 9. ALL FITTINGS EXTRA HEAVY DUTY 10. MILL CERTIFICATE SHALL BE SUBMITTED.
- 9. TUBULAR STEEL PIPE SHALL BE INSTALL EVERY 50'-0" PANEL SPAN (SPAN=10'-0')
- TUBULAR STEEL PIPE SHALL BE INSTAL EVERY DIRECTIONS CHANGE IN THE FENCE. TUBULAR STEEL PIPE SHALL BE INSTALL AT EACH FENCE END PANEL.
- 10. ALL FITTINGS EXTRA HEAVY DUTY.
- 11. MILL CERTIFICATE SHALL BE SUBMITTED.



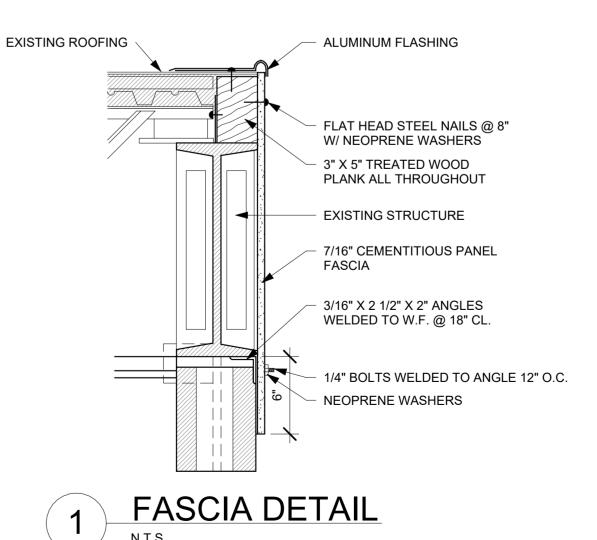



THIS DOCUMENT REPRESENTS THE IDEAS AND EFFORTS OF CSA ARCHITECTS AND ENGINEERS IT SHALL BE USED ONLY BY AUTHORIZED PERSONS AND SHALL NOT BE REPRODUCED OR EXHIBITED WITHOUT WRITTEN CONSENT OF CSA ARCHITECTS AND ENGINEERS.



ISSUE FOR BID

Issue Date

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ANNETTE ALFONSO

ANNETTE ALFONSO STAFF DESIGNER: CARLOS COLON

PRINCIPAL CAD TECHNICIAN:

Q.C. AUDITOR:

PROFESSIONAL'S STATEMEN

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DISCIPLINARIA POR LA OGPE.

PRIDCO DAMAGE IMPROVEMENTS METRO REGION STAGE 1 BID PACKAGE M1-4 **PW: 9522 / COMERIO**

PERSONAS CON MI CONOCIMIENTO, ME HACEN RESPONSABLE DE CUALQUIER ACCIÓN JUDICIAL Y

DATE	ISSUE DESCRIPTION
DDAMINO	INFORMATIONS

DETAILS AND SPECIFICATIONS

SCALE:

SHEET TITLE:

AS SHOWN

DELIVERY DATE: PROJECT NUMBER: 21-0258-02 PRINT DATE & TIME: BIM FILE NAME: 8/8/2024 10:52:28 AM DRAWING / MODEL LOCATION:

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